

I-75 REST AREAS PROJECT DEVELOPMENT AND ENVIRONMENT (PD&E) STUDY

SARASOTA AND CHARLOTTE COUNTIES

DRAFT LOCATION HYDRAULICS REPORT

FINANCIAL PROJECT NO.: 436602-1-22-01

MARCH 2017



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Florida Department of Transportation

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1 Executive Summary

The Florida Department of Transportation (FDOT) is conducting a Project Development and Environment (PD&E) study to identify sites for the placement of one northbound (NB) and one southbound (SB) rest area facility along I-75. In April of 2015, the FDOT closed the Jones Loop Rest Area at exit 161 in Charlotte County. This facility was an “off-system” rest area that serviced vehicles in both directions of I-75. The proposed rest areas will serve as a replacement for this recently closed rest area thus reducing the distances between rest area facilities. The study limits extend from the Charlotte/Lee County line north to the interchange of SR 681 and I-75. The total study corridor length is approximately 51 miles (22 miles in Charlotte County and 29 miles in Sarasota County). A preliminary investigation was conducted to determine potential rest area sites. The results of this preliminary investigation are detailed in the site selection report that was prepared in March of 2016.

This project will identify two sites for new rest areas along I-75, one each in the northbound and southbound direction. After the preliminary analysis, five rest area sites were identified for farther evaluation. Three of these sites are located off of NB I-75 (NB-2, NB-2B & NB-WIM) and the other two sites are located off of SB I-75 (SB-2 & SB-WIM).

The proposed sites will have both longitudinal impacts and transverse floodplain impacts. The longitudinal impacts will occur where fill from the rest area sites and the ramps that provide access to these facilities is placed below the base flood elevation. The transverse impacts will occur where the cross drains either need to be extended or new cross drains will need to be installed under the ramps that provide access to the rest areas. SWFWMD will require that no adverse impacts occur as a result of the required modifications. Floodplain impacts and compensation were calculated utilizing “cup for cup” methodology. One floodplain compensation site has been identified for each rest area alternative.

This analysis assumed that the rest area sites would be implemented as a pair that had to be within relatively close proximity of each other. As such, the WIM sites were included as one pair with the SB-2 site included with both the NB-2 site and the NB-2B site to form an additional two pairs.

NB-WIM and SB-WIM are the northbound/southbound alternative pair that required the smallest footprint for compensatory floodplain volume. This is mainly due to the fact that the SB-WIM site does not encroach into the floodplain and that the NB-WIM site is located in Zone A which has a very shallow floodplain depth relative to the existing ground. The alternative that required the largest compensatory floodplain volume was the NB-2 and SB-2 northbound/southbound alternative pair because the largest elevation difference between the existing ground and the 100-year floodplain occurred in this location.

Based solely on the floodplain compensation requirements, the WIM sites are the best alternative because the additional R/W required for floodplain compensation is the smallest of any of the northbound/southbound alternatives.

2 Introduction

The Florida Department of Transportation (FDOT) is conducting a Project Development and Environment (PD&E) study to identify sites for the placement of one northbound (NB) and one southbound (SB) rest area facility along I-75. In April of 2015, the FDOT closed the Jones Loop Rest Area at exit 161 in Charlotte County. This facility was an “off-system” rest area that serviced vehicles in both directions of I-75. The proposed rest area will serve as a replacement for this recently closed rest area thus reducing the distances between rest area facilities.


2.1 Report Purpose

This Location Hydraulics Report (LHR) was prepared as part of the I-75 Rest Areas PD&E Study. A summary of the drainage requirements have been compiled as part of this study to ensure that the preferred alternative takes all aspects of the project into account. One floodplain compensation site has been identified for each alternative.

2.2 Project Description

The study limits extend from the Charlotte/Lee County line north to the interchange of SR 681 and I-75, see **Figure 2-1**. The total study corridor length is approximately 51 miles (22 miles in Charlotte County and 29 miles in Sarasota County). Note that there is a very small portion (approximately 0.214 miles) of I-75 located in DeSoto County between Charlotte County and Sarasota County. For this study, this portion is included with the Sarasota County section of the project. The project will identify two sites for new rest areas along I-75, one each in the northbound and southbound direction. After the preliminary analysis, five rest area sites were identified for farther evaluation. Three of these sites are located off of NB I-75 (NB-2, NB-2B & NB-WIM) and the other two sites are located off of SB I-75 (SB-2 & SB-WIM). These sites have been shown on **Figure 2-1**.

Figure 2-1: Project Location Map

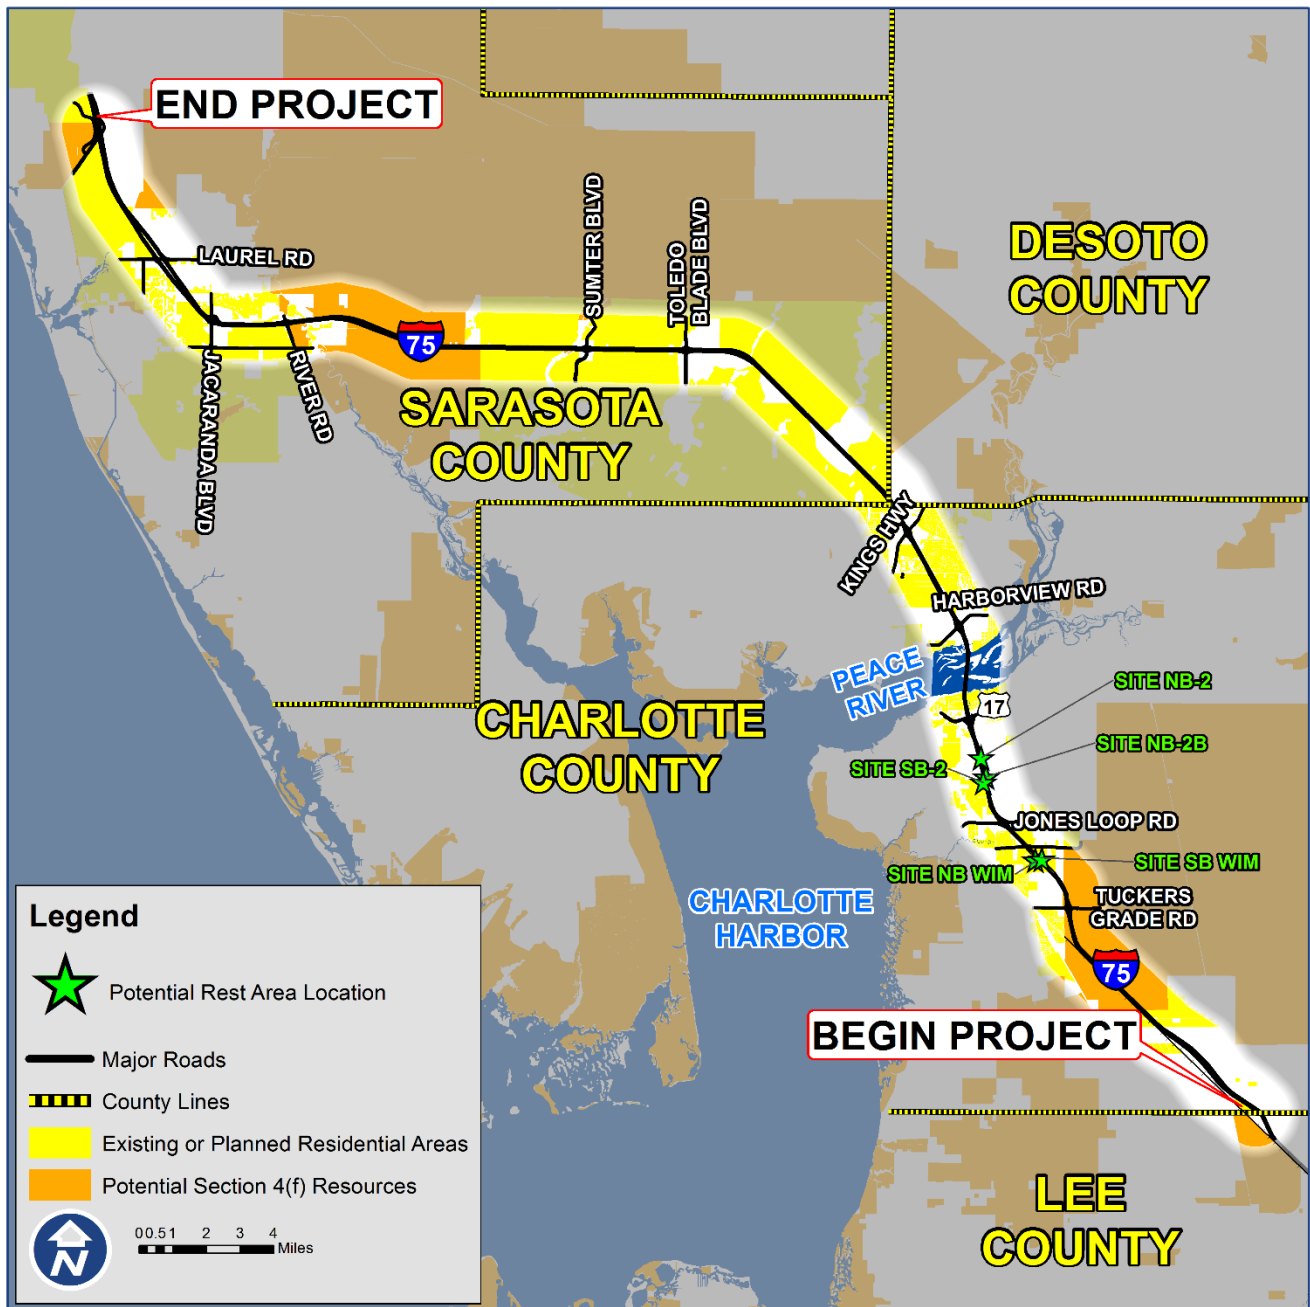

2.3 Future Land Use

Future land uses for this project are taken from the following data sources: City of North Port, 2015; Sarasota County GIS, 2015; and Charlotte County GIS, 2015. **Table 2-1** summarizes the future land uses for each of the alternatives.

Table 2-1: Future Land Use

Rest Area Alternative	Future Land Uses
SB-2	High Density Residential/ Commercial
SB-WIM	Low Density Residential
NB-2	Industrial
NB-2B	Industrial
NB-WIM	High Density Residential

3 Data Collection

Data was obtained from a variety of sources in order to complete the analysis. A list of the data collected and the source of the data is provided in **Table 3-1**.

Table 3-1: Data Collected

FEATURE DATASET	SOURCE
GIS Base Layers	Florida Geographic Data Library, 2015
Existing Land Use	Charlotte County Property Appraiser, 2015; Southwest Florida Water Management District, 2011; Aerial Imagery, 2014
Future Land Use	City of North Port, 2015; Sarasota County GIS, 2015; Charlotte County GIS, 2015
Section 4(f) Resources	Florida Natural Areas Inventory, 2014
Wetlands	Southwest Florida Water Management District, 2011
Flood Zones	Federal Emergency Management Agency (FEMA) Statewide National Flood Hazard Layer (NFHL), 2015; FEMA Sarasota County Preliminary NFHL, 2014

4 Regulatory Agency Coordination

This project will require coordination with the Florida Department of Environmental Protection (FDEP), Southwest Florida Water Management District (SWFWMD) and the U.S. Army Corps of Engineers (USACE). RS&H did not coordinate with the water management district for this specific project, however, RS&H has coordinated with the water management district on a current I-75 widening project (FPID No. 413042-4 52-01) that overlaps three of the five rest area alternatives. The other two rest area sites are located approximately one mile south of the southern end of the I-75 widening project.

5 Existing Conditions

5.1 Site Locations

I-75 (SR 93) is one of two major north-south limited access interstates that connect south Florida with the state of Georgia. As noted previously, in April of 2015 the FDOT closed the Jones Loop Rest Area at exit 161 in Charlotte County. This facility was an “off-system” rest area that serviced vehicles in both directions of I-75. The next closest rest area is the Lee County Rest Area, located at exit 131 on Daniel’s Parkway. However, this site is planned for closure as it is also an “off-system” site. With the planned closure of the Lee County Rest Area, the nearest adjacent rest areas on I-75 are the Hillsborough County Rest Area, located at mile marker 238, and the Collier County Rest Area, located at mile marker 63. The distance between these two rest area facilities is approximately 175 miles. The American Association of State Highway and Transportation Officials (AASHTO) guidelines recommend rest areas should be spaced approximately a one-hour drive between appropriate stopping opportunities. At interstate speeds, this equates to approximately 70 miles between stopping opportunities. It is important to note that one set of rest areas will not meet the recommended spacing of 70 miles between the stopping opportunities. One of the considerations for the placement of the new rest area facilities will be that they are as equidistant to the existing rest area sites as possible.

A preliminary investigation was conducted to determine potential rest area sites. These sites were chosen from the segments identified in the Site Selection Report prepared in March of 2016. Five alternatives were selected for a more detailed analysis; SB-2, SB-WIM, NB-2, NB-2B and NB-WIM. Each of these five alternatives are described in greater detail below.

SB-2

Alternative SB-2 is located approximately 1500 feet south of Airport Road. The existing land use is pasture and the future land use has been defined as commercial on the north end of the rest area and residential on the south end of the rest area. There are no wetlands located at this site. The majority of this rest area is located within FEMA Flood Zone AE (Elev. 12.0-feet) with the southern end of the site located within FEMA Flood Zone X which is defined as an area of minimal flooding with no established base flood

elevation. SB-2 is located in the Broad Creek Basin and WBID No. 2062 which is not impaired for either total phosphorus or total nitrogen

NB-2

Alternative NB-2 is located approximately 2000 feet north of Airport Road. The existing land use is industrial and the future land use has also been defined as industrial. There are no wetlands located at NB-2. There is a permitted floodplain compensation facility (SWFWMD Permit No. 43000164.038) located on this site and NB-2 is located within FEMA Flood Zone AE (Elev. 10.5-feet). As such, impacts for fill material placed below the base flood elevation will need to be accounted for. NB-2 is located in the Broad Creek Basin and WBID No. 2062 which is not impaired for total phosphorus or total nitrogen.

NB-2B

Alternative NB-2B is located approximately 700 feet south of Airport Road. The existing land use is industrial and the future land use has also been defined as industrial. There are no wetlands located at this site. The majority of this rest area is located within FEMA Flood Zone AE (Elev. 12.0-feet) with the southern end of the site located within FEMA Flood Zone X which is defined as an area of minimal flooding and no established base flood elevation. NB-2B is located in the Broad Creek Basin and WBID No. 2062 which is not impaired for total phosphorus or total nitrogen.

SB-WIM

Alternative SB-WIM is located approximately 2500 feet south of South Jones Loop Road directly west of the existing SB weigh in motion station. The existing land use is pasture and the future land use has been defined as residential. There are no wetlands located at this site. SB-WIM is located within FEMA Flood Zone X which is defined as an area of minimal flooding and with as no established base flood elevation. SB-WIM is located in the Alligator Creek Basin and WBID No. 2074 which is currently impaired for dissolved solids, but not total phosphorus or total nitrogen.

NB-WIM

Alternative NB-WIM is located approximately 2500 feet south of South Jones Loop Road directly east of the existing NB weigh in motion station. The existing land use is pasture and the future land use has been defined as residential. There are no wetlands located at this site. The majority of the NB-WIM site is located within FEMA Flood Zone A. There is no established base flood elevation, but for the purposes of this report it has been estimated at elevation 20.7-feet based on an approximate elevation at the limits of the floodplain map obtained from GIS LiDAR topographic information. The on and off ramps to the rest area are located within FEMA Flood Zone X which is defined as an area of minimal flooding. NB-WIM is located in the Alligator Creek Basin and WBID No. 2074 which is currently impaired for dissolved solids.

5.2 Cross Drains

There are several existing cross drains that are located within the limits of the rest area sites and the ramps needed to access the rest areas. Locations of these cross drains were taken from existing plans for FPID No. 413042-3-52-01 and FPID No. 413042-4-52-01. **Table 5-1** identifies each cross drain location and size as they were presented in the two previously mentioned plan sets.

Table 5-1: Cross Drain Locations

REST AREA SITE ASSOCIATED WITH IMPACT	SIZE OF CROSS DRAIN	LOCATION OF CROSS DRAIN
NB-2	30"	1000' north of Airport Rd
NB-2	10'X6'	1800' north of Airport Rd
NB-2	24"	600' south of Henry St
NB-2B, SB-2	30"	4900' north of Jones Loop Rd
NB-2B, SB-2	30"	5500' north of Jones Loop Rd
NB-WIM	18"	4600' north of Tuckers Grade
NB-WIM, SB-WIM	18"	5600' north of Tuckers Grade
NB-WIM, SB-WIM	48"	5600' south of S Jones Loop Rd
NB-WIM, SB-WIM	30"	3900' south of S Jones Loop Rd
NB-WIM, SB-WIM	10'X5'	900' south of S Jones Loop Rd
SB-WIM	30"	1600' north of N Jones Loop Rd

6 Proposed Condition

6.1 Floodplain Encroachment and Compensation

Floodplain impacts and compensation were calculated utilizing "cup for cup" methodology. Topography and the seasonal high water elevation were factored into the location of each floodplain compensation site. It was assumed that all floodplain compensation sites would have a 15 foot maintenance berm and 1:4 side slopes for the interior of the storage area. Unless noted differently, all elevations are taken from the NGVD 29 Datum. Supporting calculations for the sizing of the floodplain compensation sites are provided in **Appendix B**. Each individual rest area site is discussed below.

SB-2

Alternative SB-2 is located approximately 1500 feet south of Airport Road. This site would be constructed on an existing pasture adjacent to the I-75 right of way. The seasonal high water table elevation was estimated at elevation 7.9-feet. This value is approximately 1.5-feet below existing ground and is comparable to the seasonal high water elevations established for the I-75 widening project currently under design (FPID – 413042-4-52-01). The existing ground elevation at SB-2 is approximately 9.4. Since the base flood elevation is 12.0 at SB-2, compensation will be required for all fill placed within the floodplain. Two floodplain compensation sites have been identified between I-75 and Piper Road directly north of Airport Road. The site closest to Piper Road was sized to accommodate the needs for SB-2, however, the size of the site closest to I-75 could also be adjusted in order to meet all of the floodplain

Figure 6-1: NB-2B & SB-2 Rest Area Sites

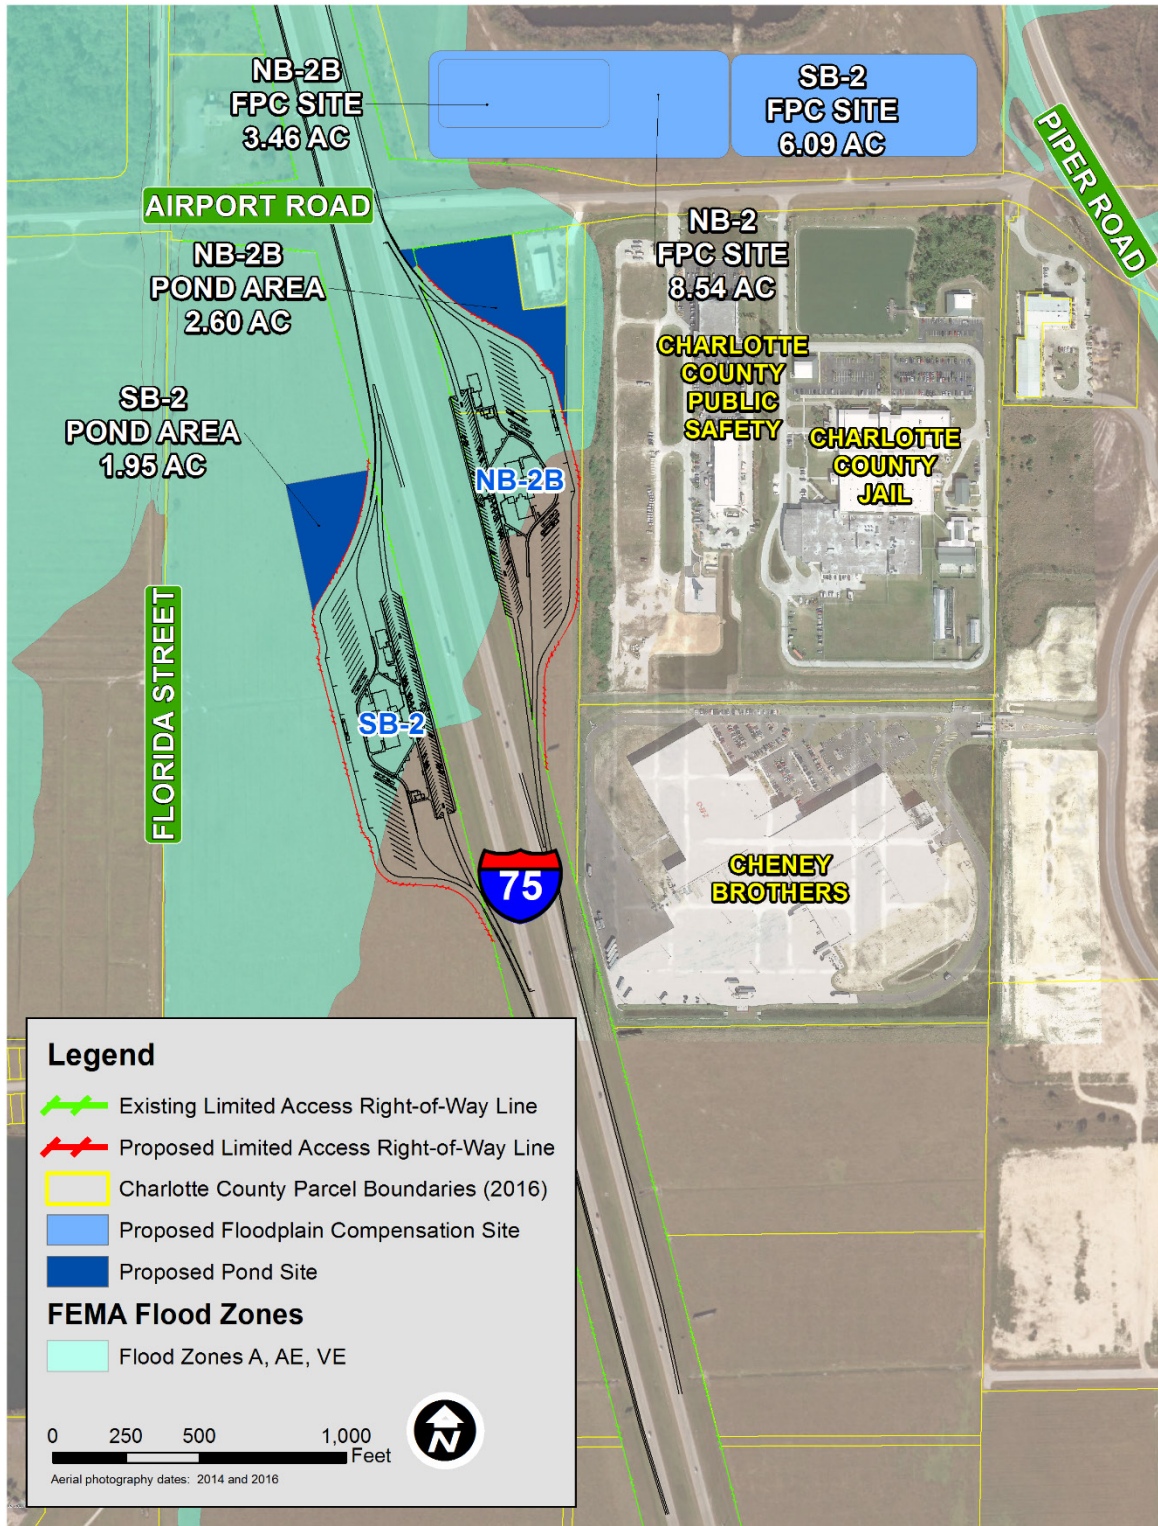


Figure 6-2: NB-2 Rest Area Site



Figure 6-3: NB & SB WIM Rest Area Sites



compensation requirements for SB-2. Both of these sites would require the purchase of additional right of way. The location of these two floodplain compensation sites are shown on **Figure 6-1**. Floodplain impacts and compensation requirements are summarized in **Table 6-1**.

NB-2

Alternative NB-2 is located approximately 2000 feet north of Airport Road. The majority of this rest area would be constructed on an existing permitted floodplain compensation site (SWFWMD Permit No. 43000164.038). Compensation for impacts to this facility will need to be provided. Excerpts from this permit are included in **Appendix C**. This land is currently owned by the Charlotte County Airport Authority. Per SWFWMD Permit No. 43000164.038, the seasonal high water elevation at NB-2 is at elevation 6.50 which is 2 feet below the existing ground. This value is comparable to the seasonal high water elevations that were established near this location for the I-75 mainline widening design (FPID – 413042-4-52-01). It should be noted that NB-2 would have to be configured so as to accommodate Broad Creek which is located between I-75 and the borrow pit. This may require the construction of several hundred feet of box culvert extension to carry Broad Creek beneath, or adjacent to, the rest area.

The existing ground elevation at NB-2 is approximately 8.5. Since the base flood elevation is 10.5 at NB-2, compensation will be required for all fill placed within the floodplain and all impacts to the existing floodplain compensation site. Two proposed floodplain compensation sites have been identified between I-75 and Piper Road directly north of Airport Road. The site closest to I-75 was sized to accommodate the needs for NB-2, however, the size of the site closest to Piper Road, which was sized for SB-2, could also be adjusted in order to meet all of the floodplain compensation requirements for NB-2. Both of these sites would require the purchase of additional right of way. The location of these two floodplain compensation sites are shown on **Figure 6-2**. Floodplain impacts and compensation requirements are summarized in **Table 6-1**.

NB-2B

Alternative NB-2B is located approximately 700 feet south of Airport Road. This site would be constructed on an existing pasture adjacent to the I-75 right of way. The seasonal high water table elevation was estimated at elevation 9.4-feet. This value is approximately 1.5-feet below existing ground and is comparable to the seasonal high water elevations established for the I-75 widening project currently under design (FPID – 413042-4-52-01).

The majority of this rest area is located within FEMA Flood Zone AE with the southern end of the site located within FEMA Flood Zone X which is defined as an area of minimal flooding. Two proposed floodplain compensation sites have been identified between I-75 and Piper Road directly north of Airport Road. The site closest to I-75 was sized to accommodate the needs for NB-2B, however, the floodplain compensation requirements could also be met at the site closest to Piper Road. Both of these sites would require the purchase of additional right of way. The location of these two floodplain compensation sites are shown on **Figure 6-1**. Floodplain impacts and compensation requirements are summarized in **Table 6-1**.

SB-WIM

Alternative SB-WIM is located approximately 2500 feet south of South Jones Loop Road directly west of the existing SB weigh in motion station. This site would be constructed on an existing pasture adjacent to the I-75 SB weigh in motion station. The seasonal high water table was estimated at elevation 19.5-feet which is approximately the same elevation used for the existing WIM stations (SWFWMD Permit No. 409592). The location of rest area SB-WIM is shown on **Figure 6-3**. SB-WIM is located within FEMA Flood Zone X which is defined as an area of minimal flooding with no base flood elevations established. Since the existing ground elevation at the SB WIM site is approximately the same as the floodplain elevation at the NB WIM site, minimal or no impacts to the floodplain are anticipated at the SB-WIM site.

NB-WIM

Alternative NB-WIM is located approximately 2500 feet south of South Jones Loop Road directly east of the existing NB weigh in motion station. This site would be constructed on an existing pasture adjacent to the I-75 NB weigh in motion station. The seasonal high water table elevation was set at 19.5-feet which is approximately the same elevation used for the existing WIM stations. The existing ground elevation at the NB-WIM rest area site varies from approximately 18.0 to 23.0. The majority of the NB-WIM site is located within FEMA Flood Zone A which has no established base flood elevation. However, for the purposes of this evaluation, the base flood elevation has been set at 20.7-feet based on an approximate elevation near the edge of the floodplain shape based on GIS LiDAR topographical data. Therefore, compensation will be required for all fill placed within the floodplain. The on and off ramps to the rest area are located within FEMA Flood Zone X which is defined as an area of minimal flooding. The floodplain compensation site for NB-WIM is located between the I-75 on ramp and an existing borrow pit lake at the southern end of the rest area site in what has been classified as existing pasture land. The location of the floodplain compensation site is shown on **Figure 6-3**. Floodplain impacts and compensation requirements are summarized in **Table 6-1**.

Table 6-1: Floodplain Impacts and Sizing of Compensation Sites

REST AREA SITE	VOLUME IMPACTED (ACRE-FT)	AREA REQUIRED TO ACCOMMODATE IMPACTED VOLUME (ACRES)
SB-2	17.52	6.09
NB-2	28.99	8.54
NB-2B	10.29	3.46
SB-WIM	N/A	N/A
NB-WIM	4.88	4.12

There is potential for transverse impacts resulting from the extension or replacement of culverts. However, based on a preliminary inspection of cross drain locations, no adverse impacts will result at these crossings. FDOT and SWFWMD design criteria do not allow for any significant increase in flood stage upstream of cross drains. A more detailed analysis of these impacts is needed during the design phase of this project to ensure that that this criteria is met.

6.2 Project Classification

In accordance with the requirements set forth in 23 CFR 650A, the project corridor was evaluated to determine the effects of the proposed improvements on the hydrology and hydraulics of the surrounding area. This project is located in a low density minimally developed area. The FDOT's and SWFWMD's design standards, which do not allow for any significant impacts, will be adhered to for the design of this project.

Replacement drainage structures for this project are limited to hydraulically equivalent structures. The limitations to the hydraulic equivalency being proposed are basically due to restrictions imposed by the geometrics of design, cost feasibility, or practicability. Since flooding conditions in the project area are inherent in the topography or are a result of other outside contributing sources, and there is no practical alternative to totally eradicate flood impacts or even reduce them in any significant amount, existing flooding will continue, but not be increased. The proposed structure will be hydraulically equivalent to or greater than the existing structure, and backwater surface elevations are not expected to increase. As a result, the project will not affect existing flood heights or floodplain limits. This project will not result in any new or increased adverse environmental impacts. There will be no significant change in the potential for interruption or termination of emergency service or emergency evacuation routes. Therefore, it has been determined that this encroachment is not significant.

7 Conclusion

The proposed project involves siting and preliminary design for new rest areas on I-75 between the Charlotte/Lee County line and SR 681 in Sarasota County. As part of this analysis stormwater management volumes were tabulated and factored into the decision matrix. Floodplain impact volumes were all utilized to preliminarily locate floodplain compensation sites. This analysis assumed that the rest area sites would be implemented as a pair that had to be within relatively close proximity of each other. As such, the WIM sites were included as one pair while the SB-2 site was included with both the NB-2 site and the NB-2B site to form an additional two pairs.

NB-WIM and SB-WIM are the northbound/southbound alternative pair that required the smallest footprint for compensatory floodplain volume. This is mainly due to the fact that the SB-WIM site does not encroach into the floodplain and that the NB-WIM site is located in Zone A which has a very shallow floodplain depth relative to the existing ground. The alternative that required the largest compensatory floodplain volume was the NB-2 and SB-2 northbound/southbound alternative pair because the largest elevation difference between the existing ground and the 100-year floodplain occurred at this location.

Based solely on the floodplain compensation requirements, the WIM sites are the best alternative because the additional R/W required for floodplain compensation is the smallest of any of the northbound/southbound alternatives.

It should be noted that significant engineering judgement was required to arrive at the recommended alternative. Estimates were made as to the average elevation of the existing ground, the seasonal high water table and proposed profile gradeline. As much as possible these estimates are supported by existing permitted infrastructure and GIS data. However, the floodplain compensation sites, may ultimately become smaller during final design once additional engineering information has been obtained.

8 References

- Federal Emergency Management Agency, *Flood Insurance Rate Map for Charlotte County, Florida, Panels 242 & 263*, May 5, 2003.
- Florida Department of Transportation, *Drainage Manual*, 2016.
- Florida Department of Transportation, *Stormwater Management Facilities Handbook*, 2004.
- Florida Department of Transportation, *PD&E Manual*, Part 2, Chapter 24-Floodplains, August 17, 2016.
- Florida Department of Transportation, *Culvert Handbook*, 2004.
- Southwest Florida Water Management District, *Environmental Resource Permit Applicant's Handbook Volume II*, October 1, 2013.
- United States Department of Agriculture, *Soil Survey Geographic Database for Charlotte County, Florida*, November 19, 2015.

APPENDIX A
FEMA FIRM Maps & Soils Maps

SCALE 1" = 500'

500 FEET

1000 FEET

METERS

PANEL 0242 F

FIRM
FLOOD INSURANCE RATE MAP
 CHARLOTTE COUNTY,
 FLORIDA
 AND INCORPORATED AREAS

PANEL 242 OF 525

(SEE MAP INDEX FOR FIRM PANEL LAYOUT)
 CONTAINS:
 COMMUNITY NUMBER PANEL SUFFIX
 CHARLOTTE COUNTY 120061 0242 F


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EFFECTIVE DATE
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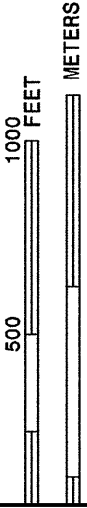
Federal Emergency Management Agency

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SCALE 1" = 500'



PANEL 0242 F

FIRM FLOOD INSURANCE RATE MAP CHARLOTTE COUNTY, FLORIDA AND INCORPORATED AREAS

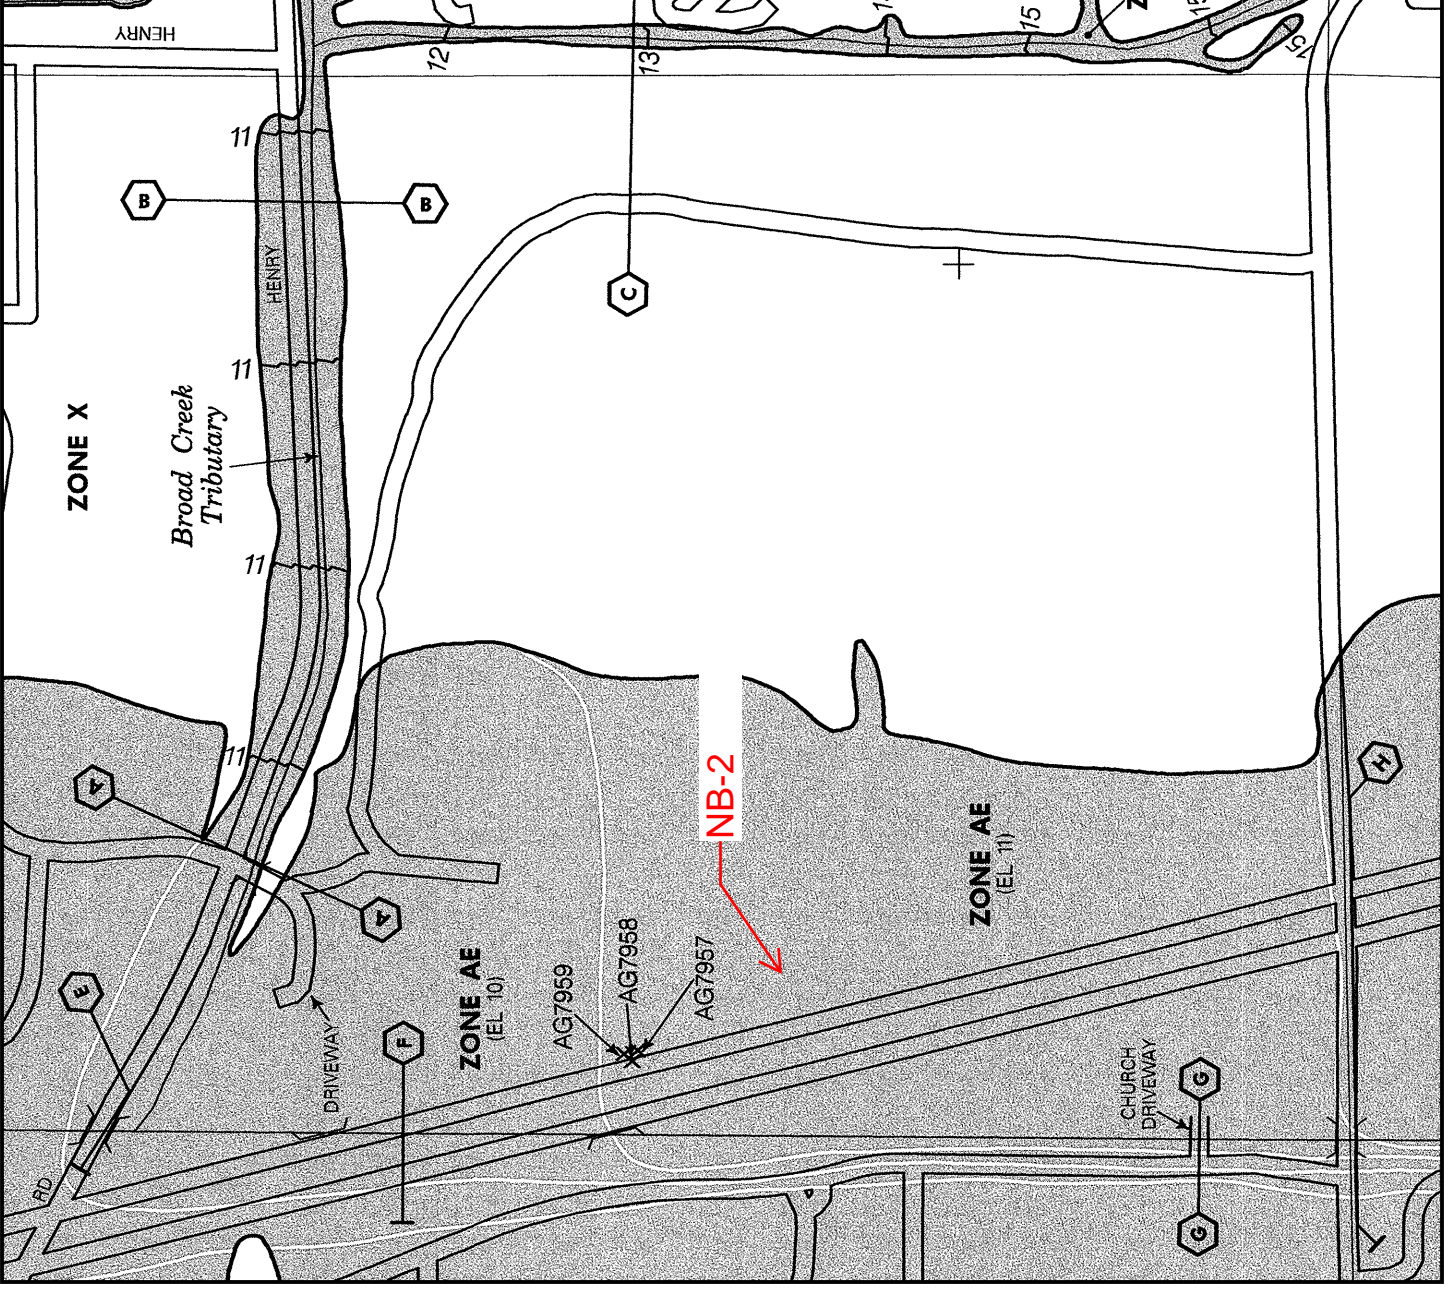PANEL 242 OF 525

(SEE MAP INDEX FOR FIRM PANEL LAYOUT)

CONTAINS:

COMMUNITY	NUMBER	PANEL	SUFFIX
CHARLOTTE COUNTY	120061	0242	F

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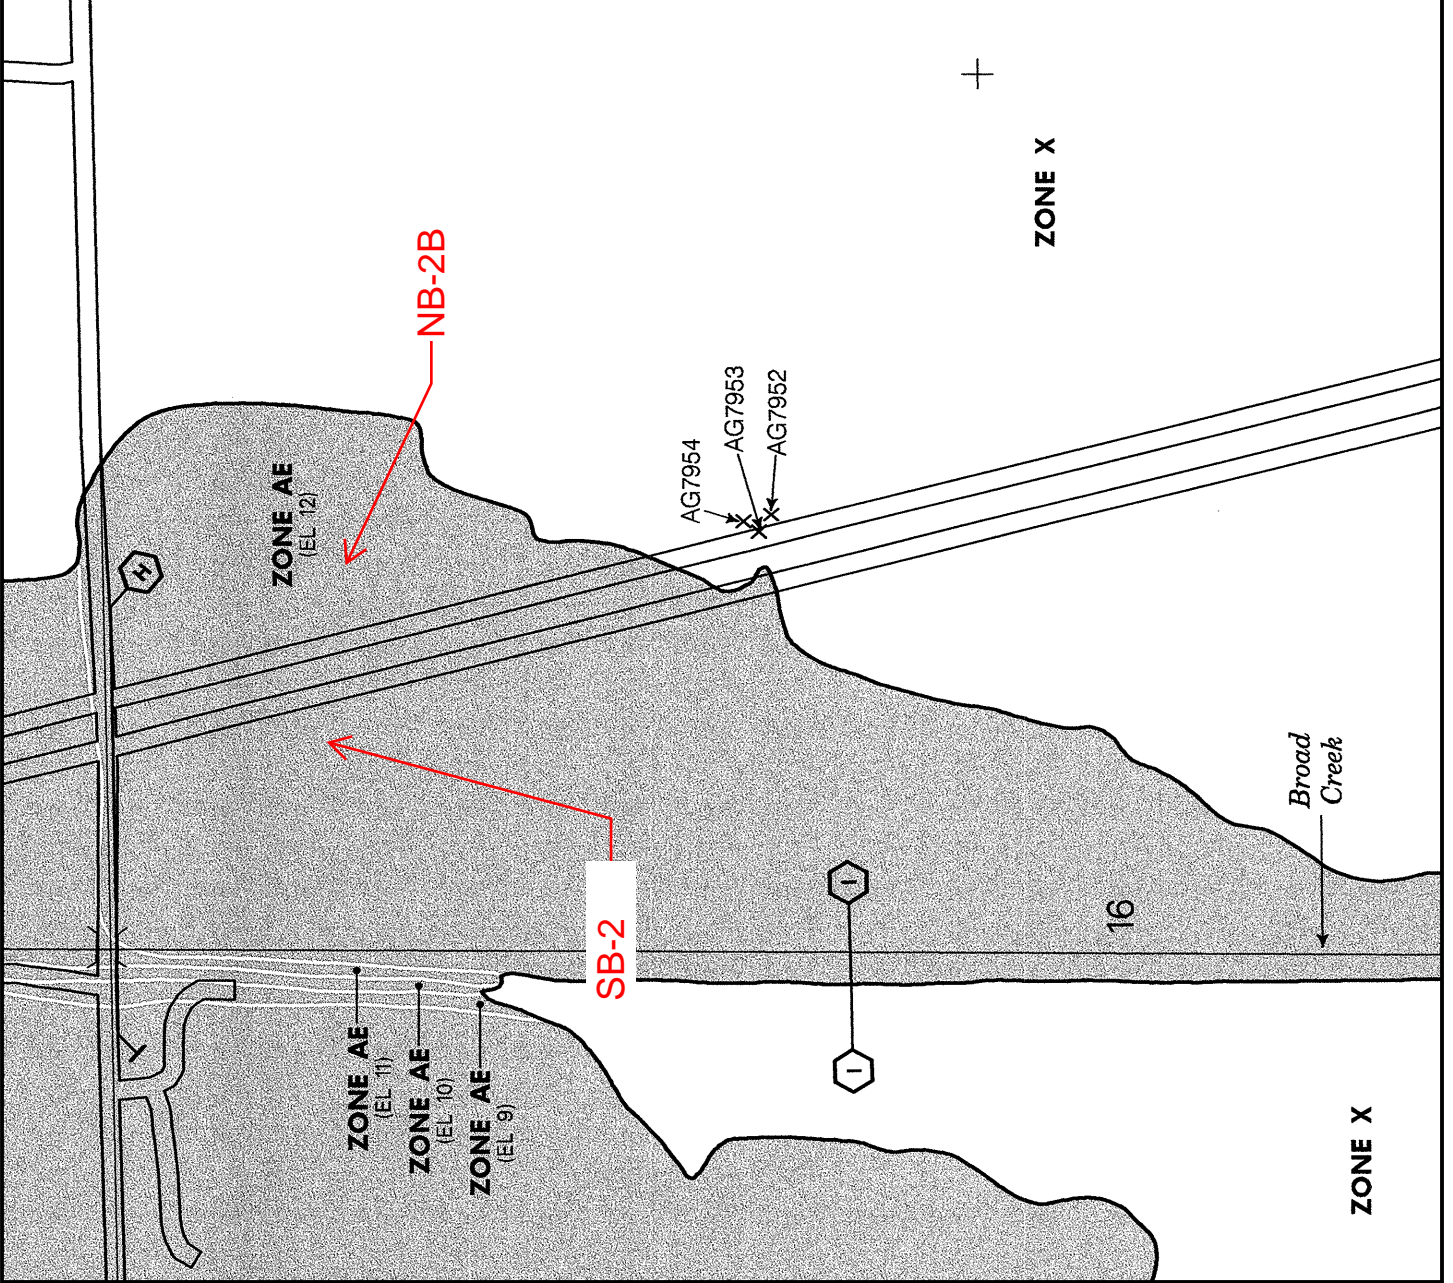


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EFFECTIVE DATE
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Federal Emergency Management Agency

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SCALE 1" = 500'

500 FEET

1000 METERS

PANEL 0263 F

FIRM FLOOD INSURANCE RATE MAP CHARLOTTE COUNTY, FLORIDA AND INCORPORATED AREAS

PANEL 263 OF 525

(SEE MAP INDEX FOR FIRM / PANEL LAYOUT)

CONTAINS:

COMMUNITY NUMBER 120061
PANEL SUFFIX 0263
SUFFIX F

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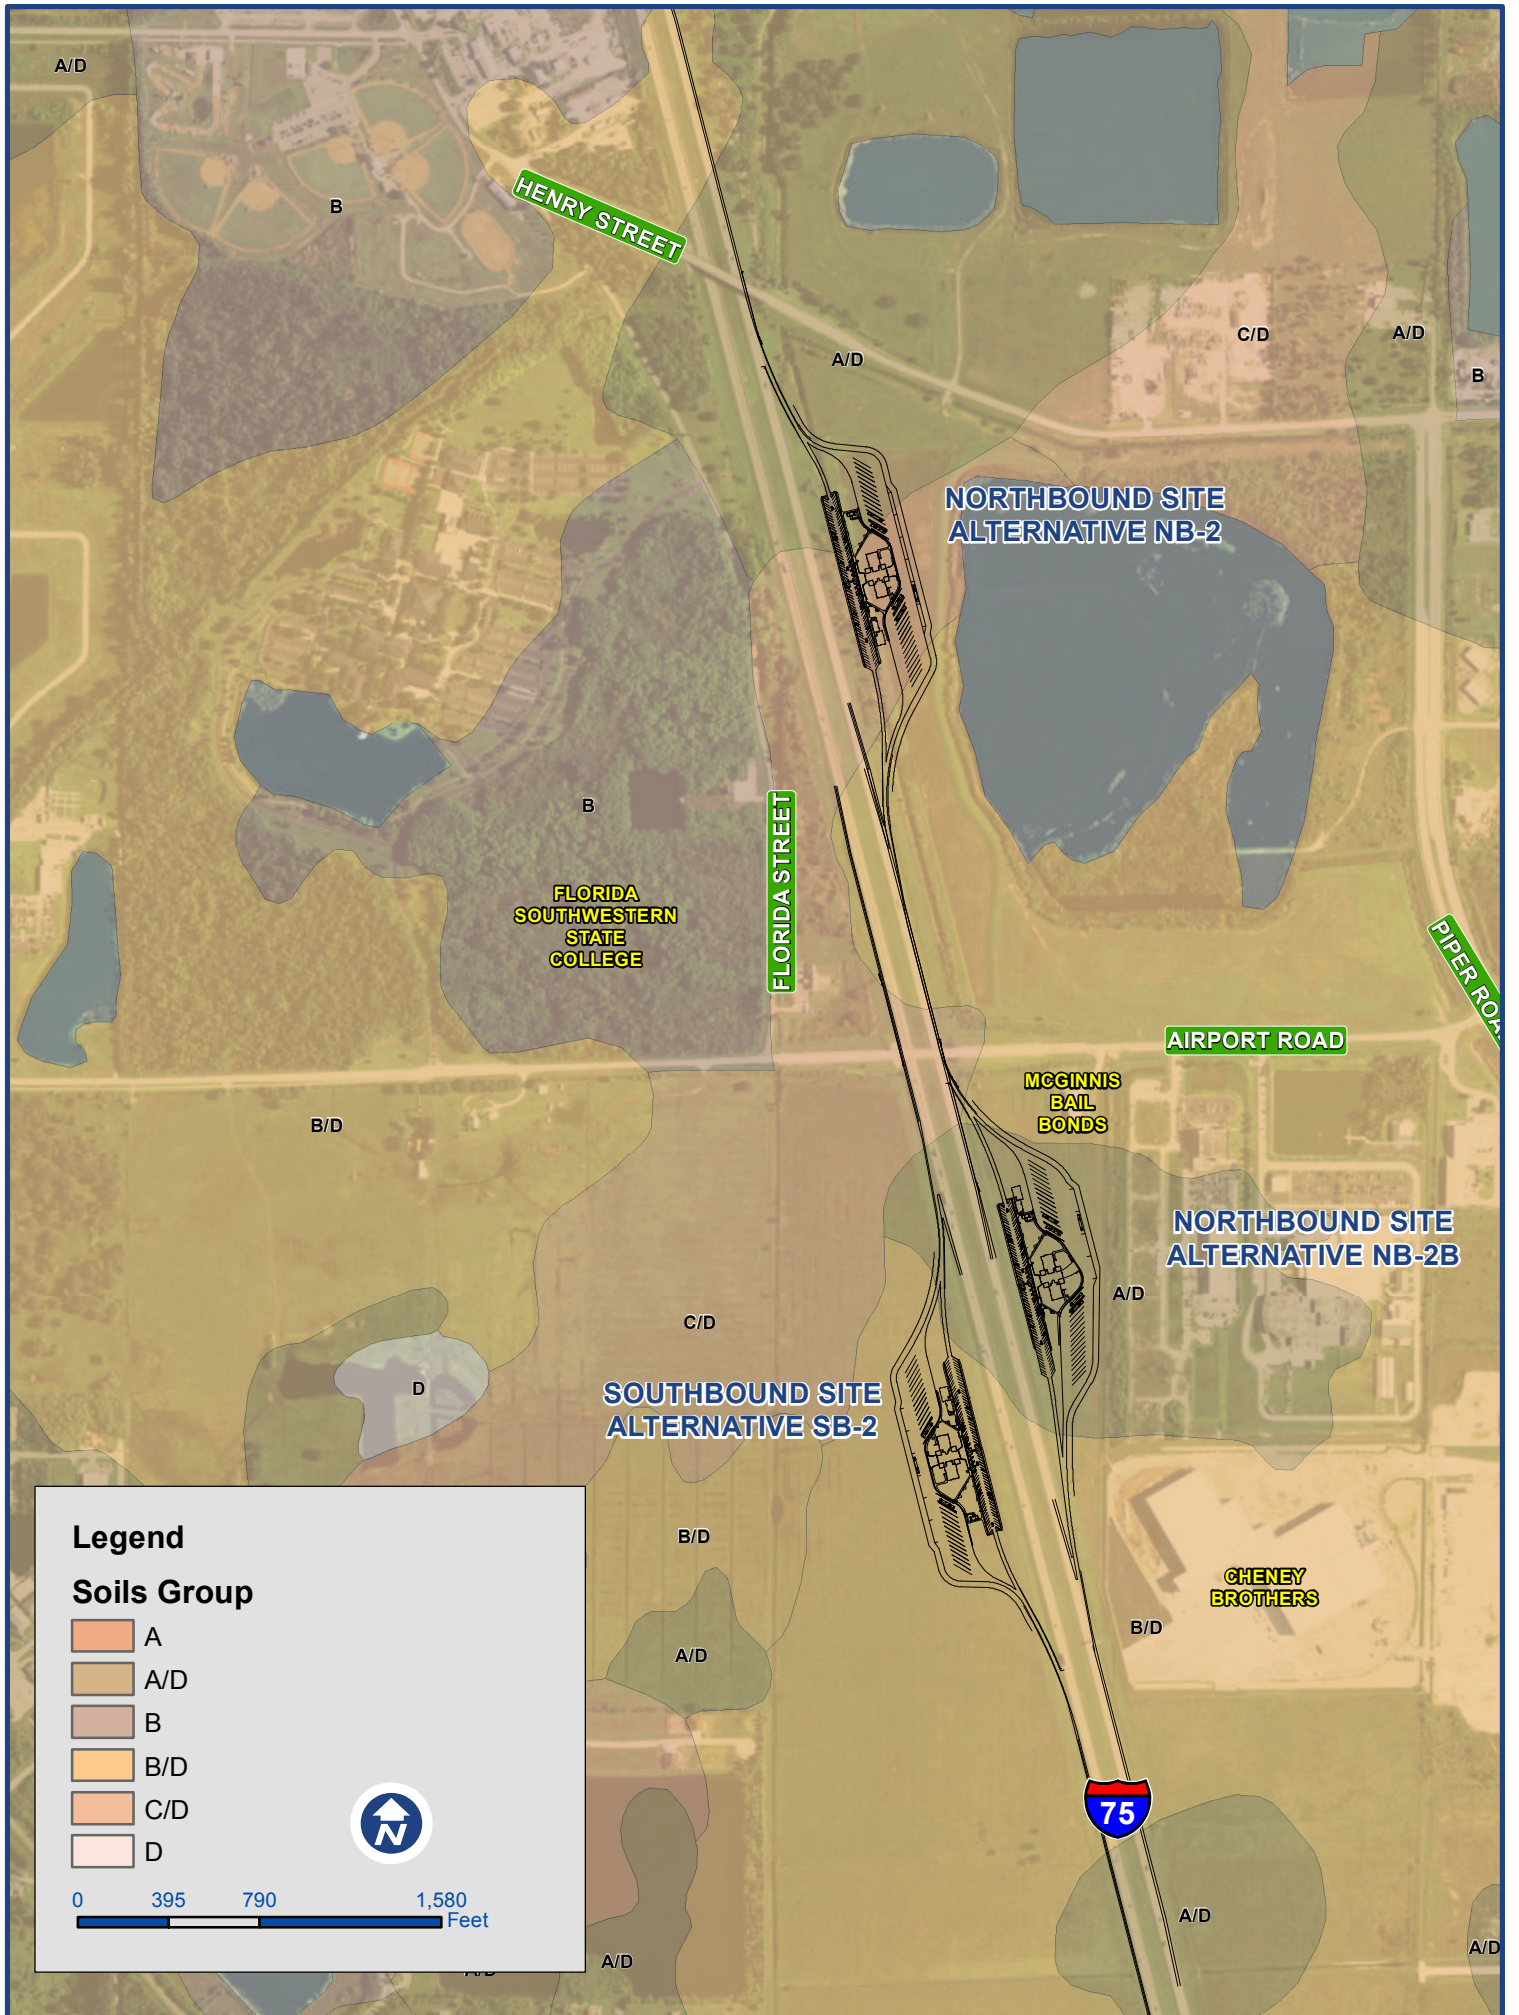
EFFECTIVE DATE
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Federal Emergency Management Agency

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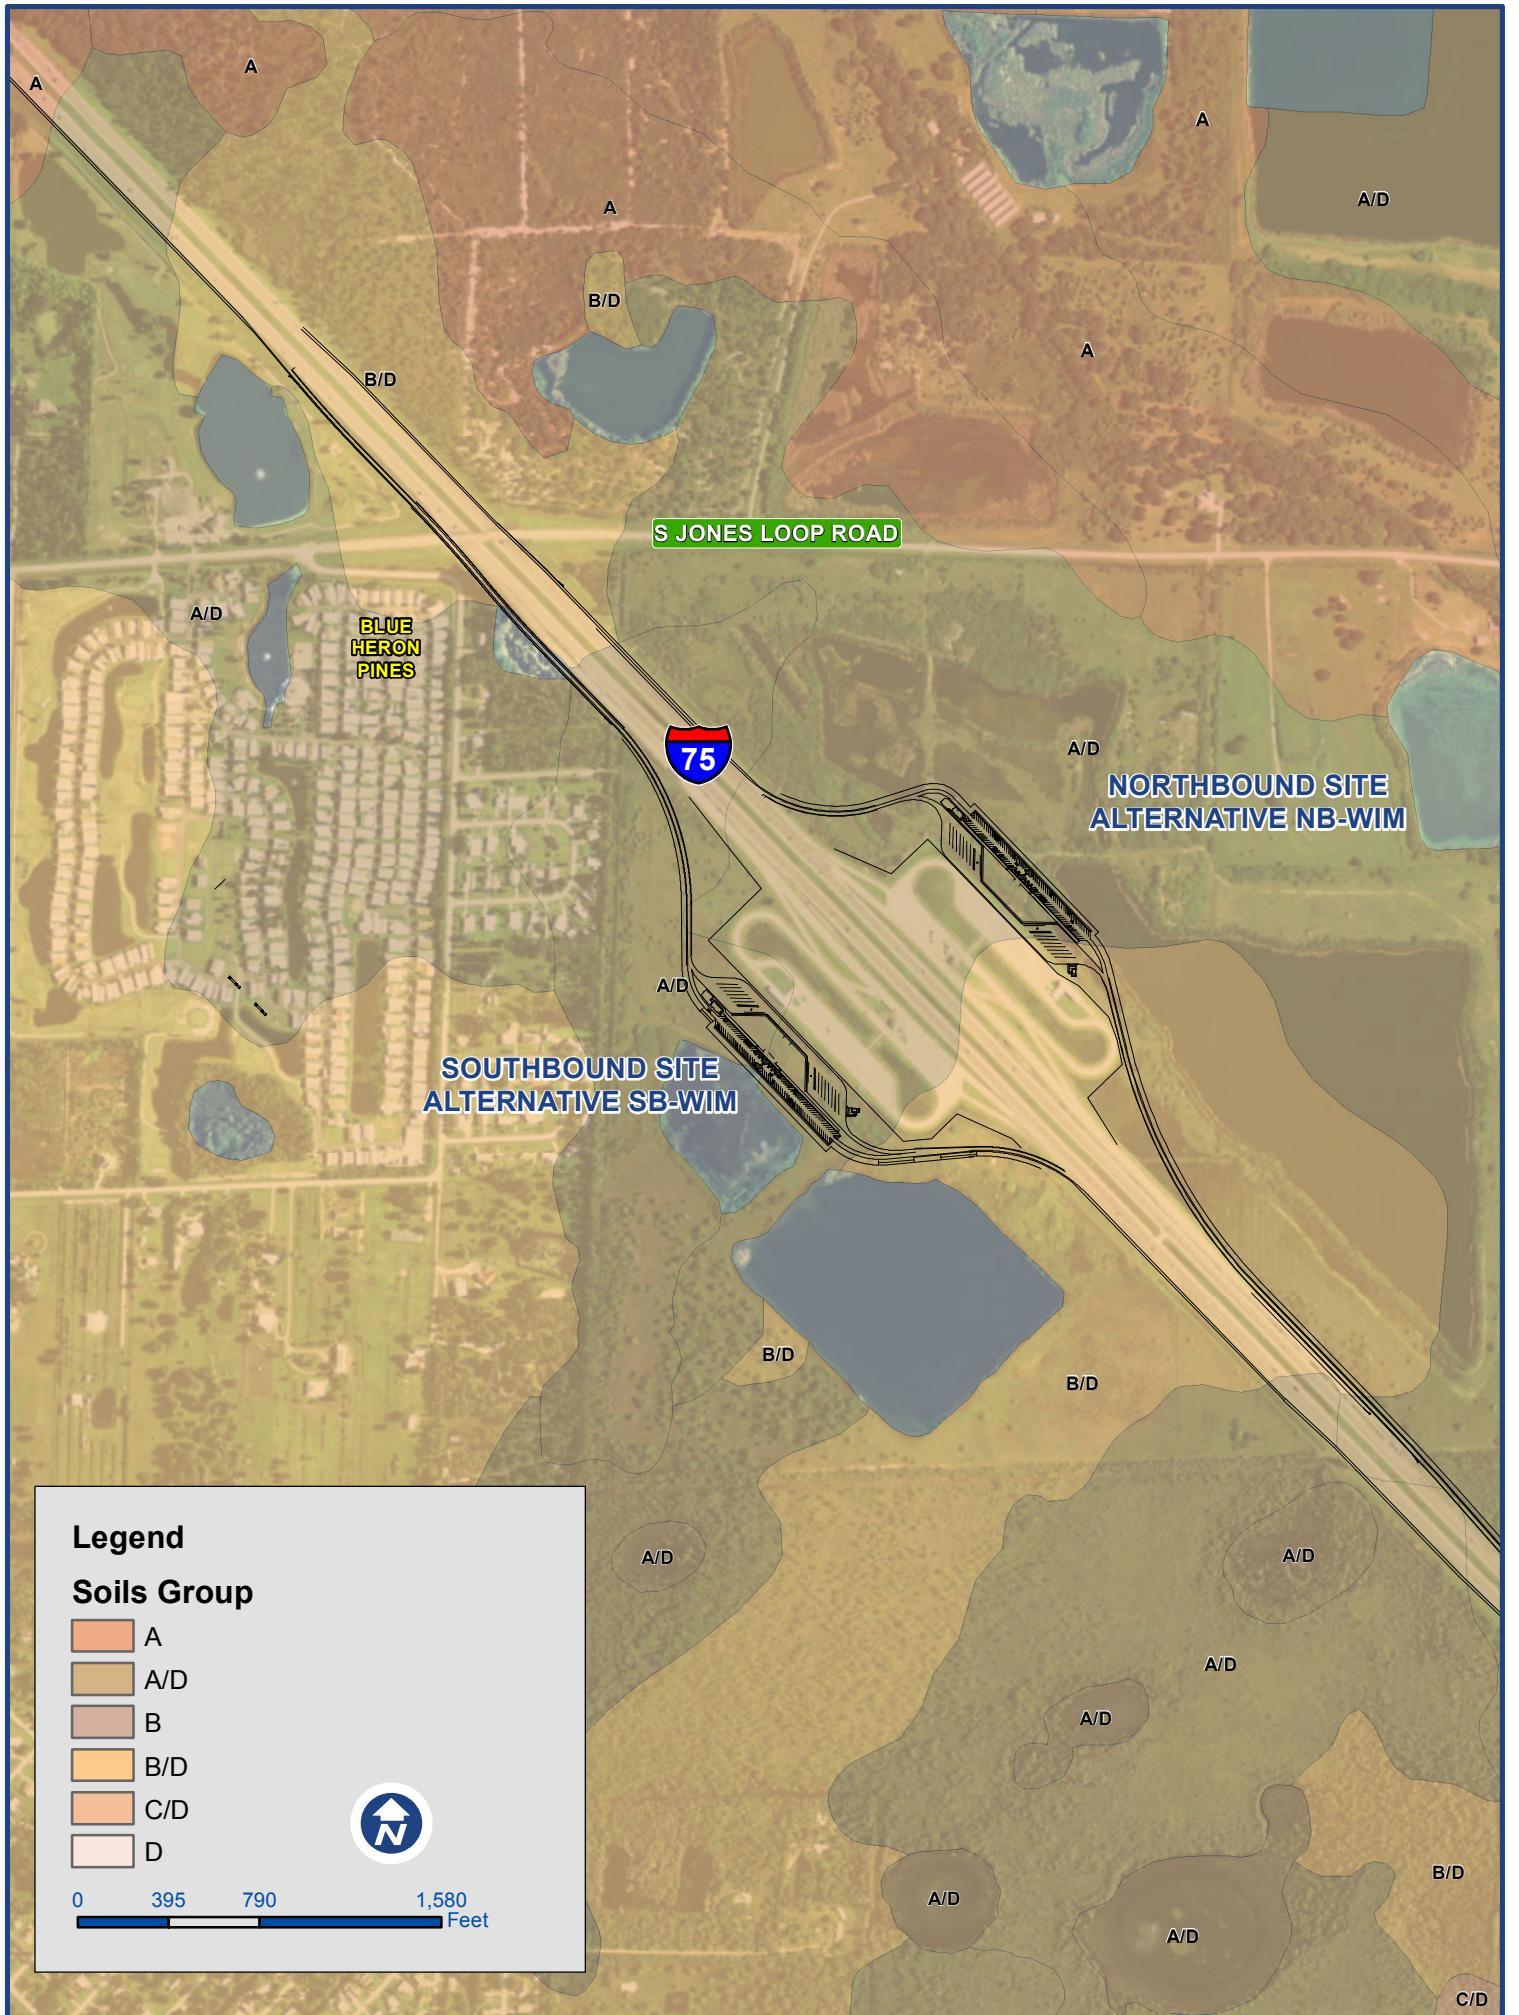
Legend

Soils Group

- A
- A/D
- B
- B/D
- C/D
- D



0 395 790 1,580
 Feet



Hydrologic Soil Group

Hydrologic Soil Group— Summary by Map Unit — Charlotte County, Florida (FL015)				
Map unit symbol	Map unit name	Rating	Acres in AOI	Percent of AOI
6	Hallandale fine sand, wet, 0 to 2 percent slopes	B/D	1,745.1	1.9%
7	Matlacha-Urban land complex	B	1,066.9	1.2%
8	Hallandale fine sand, tidal	B/D	275.6	0.3%
9	EauGallie sand, 0 to 2 percent slopes	A/D	862.8	0.9%
10	Pompano fine sand, 0 to 2 percent slopes	A/D	377.1	0.4%
11	Myakka fine sand, 0 to 2 percent slopes	A/D	1,877.4	2.0%
12	Felda fine sand, 0 to 2 percent slopes	A/D	4,322.6	4.7%
13	Boca fine sand, 0 to 2 percent slopes	A/D	4,447.3	4.9%
14	Valkaria fine sand, 0 to 2 percent slopes	A/D	696.9	0.8%
16	Peckish mucky fine sand	A/D	115.8	0.1%
17	Daytona sand	A	379.0	0.4%
18	Matlacha gravelly fine sand, limestone substratum	B	301.2	0.3%
19	Gator muck, frequently ponded, 0 to 1 percent slopes	C/D	54.0	0.1%
23	Wulfert muck	A/D	1,196.5	1.3%
24	Kesson fine sand	A/D	408.9	0.4%
26	Pineda fine sand, 0 to 2 percent slopes	A/D	5,286.7	5.8%
27	Pompano fine sand, depressional	A/D	68.2	0.1%
28	Immokalee sand, 0 to 2 percent slopes	B/D	7,834.6	8.6%
33	Oldsmar sand, 0 to 2 percent slopes	A/D	7,823.2	8.5%
34	Malabar fine sand, 0 to 2 percent slopes	A/D	1,906.5	2.1%
35	Wabasso sand, 0 to 2 percent slopes	C/D	7,488.5	8.2%

Hydrologic Soil Group— Summary by Map Unit — Charlotte County, Florida (FL015)				
Map unit symbol	Map unit name	Rating	Acres in AOI	Percent of AOI
36	Immokalee-Urban land complex	B/D	76.8	0.1%
37	Satellite fine sand, 0 to 2 percent slopes	A/D	1.0	0.0%
38	Isles fine sand, slough	B/D	10.8	0.0%
39	Isles fine sand, depressiona	B/D	294.2	0.3%
40	Anclote sand, depressiona, 0 to 1 percent slopes	A/D	66.4	0.1%
42	Wabasso sand, limestone substratum, 0 to 2 percent slopes	C/D	2,630.6	2.9%
43	Smyrna fine sand, 0 to 2 percent slopes	A/D	2,126.5	2.3%
44	Malabar fine sand, depressiona, 0 to 1 percent slopes	A/D	77.9	0.1%
45	Copeland sandy loam, depressiona	D	82.9	0.1%
49	Felda fine sand, depressiona	A/D	3,515.0	3.8%
51	Floridana sand, depressiona	C/D	345.6	0.4%
53	Myakka fine sand, depressiona	A/D	193.6	0.2%
55	Cocoa fine sand	A	10.8	0.0%
56	Isles muck	B/D	2,705.5	3.0%
57	Boca fine sand, tidal	A/D	853.6	0.9%
59	Urban land		483.1	0.5%
61	Orsino fine sand	A	351.1	0.4%
62	Winder sand, depressiona	C/D	2,257.6	2.5%
63	Malabar fine sand, high, 0 to 2 percent slopes	A/D	1,378.1	1.5%
67	Smyrna-Urban land complex	A/D	619.9	0.7%
69	Matlacha gravelly fine sand	B	2,650.0	2.9%
70	Heights fine sand	B/D	4,786.6	5.2%
73	Pineda fine sand, depressiona, 0 to 1 percent slopes	A/D	1,364.2	1.5%
74	Boca fine sand, slough	A/D	18.3	0.0%
77	Pineda fine sand, limestone substratum	C/D	368.3	0.4%

APPENDIX B
Floodplain Impacts and Compensation Site Sizing



Project Name: I-75 Rest Areas PD&E
Project Number: 104-0007-000
Task Description: Floodplain Comp

Prepared by: FAM
Checked by: RMG
Date: 11/17/2016

SB-2 Rest Area			
	Area (ac.)	Depth (ft)	Volume (ac-ft)
Impact	6.74	2.6	17.52

SB-2 EXISTING GROUND/SHWT ELEVATIONS	
Floodplain Impact Area	
Floodplain Elev.	12.00'
Existing Ground Elev.	9.40'

SB-2 TOTAL COMP. REQ. =	17.52 ac.ft.
--------------------------------	---------------------



Project Name: I-75 Rest Areas PD&E
Project Number: 104-0007-000
Task Description: Estimation of ROW Requirement

Prepared by: FAM
Checked by: RMG
Date: 11/17/2016

Floodplain ROW REQUIREMENTS - Alternate SB 2

FEMA Floodplain Elevation at Comp Site	11.00 NGVD (Zone AE From FEMA Map)
Existing Ground at Comp Site	14.40 NGVD (Estimated From GIS Topographic Information)
Elev SHW =	6.50 NGVD based on SWFWMD Permit No. 43000164.038
Floodplain Impact	17.52 AC-FT.
FPC Site Bottom Area at SHWT	4.00 AC
Storage Depth	4.50 FT.
Unit Length Based on L/W = 2	590 FT.
Unit Width Based on L/W = 2	295 FT.
Horizontal Distance Based on a 1:4 Slope and Storage Depth	36 FT.
Total Pond Length (including grade adjustments)	626 FT.
Total Pond Width (including grade adjustments)	331 FT.
Top Area (including grade adjustments but no berms and no grading to existing grd.)	4.76 AC.
Compensation Provided	19.71 ac.ft.
Maintenance Berm Width of 15-ft	30 FT.
Grading to Existing Ground	27.20 FT.
Total Pond Length (including maintenance berm)	683.52 FT
Total Pond Width (including maintenance berm)	388.36 FT
Preliminary Property Size Required	6.09 AC.
MINIMUM PROPERTY SIZE FOR FLOODPLAIN COMPENSATION	6.09 AC.

Note: The floodplain compensation site for this alternative is located north of Airport Road



Project Name: I-75 Rest Areas PD&E
Project Number: 104-0007-000
Task Description: Floodplain Comp

Prepared by: FAM
Checked by: RMG
Date: 11/17/2016

NB-2 Rest Area (Impact from Proposed Footprint)			
	Area (ac.)	Depth (ft)	Volume (ac-ft)
Impact	11.41	2.00	22.82

NB-2 Rest Area (Impact from Existing Floodplain Comp.)			
	Area (ac.)	Depth (ft)	Volume (ac-ft)
Impact	4.11	1.50	6.17

NB-2 EXISTING GROUND/SHWT ELEVATIONS	
Floodplain Impact Area	
Floodplain Elev.	10.50'
Existing Ground Elev.	8.50'

NB-2 TOTAL COMP. REQ. =	28.99 ac.ft.
--------------------------------	---------------------

Note: The impact to the existing permitted floodplain compensation site is based on a SHWT Elev. of 6.5 and an existing ground elevation of 8.5. These variables were taken from the existing permitted plansheets.



Project Name: I-75 Rest Areas PD&E
Project Number: 104-0007-000
Task Description: Estimation of ROW Requirement

Prepared by: FAM
Checked by: RMG
Date: 11/17/2016

FLOODPLAIN ROW REQUIREMENTS - Alternate NB 2

FEMA Floodplain Elevation	10.50 NGVD (Estimated From FEMA Map)
Existing Ground at Comp Site	10.50 NGVD (Estimated From GIS Topographic Information)
Elev SHW =	6.50 NGVD based on SWFWMD Permit No. 43000164.038
Floodplain Impact	28.99 AC-FT.
FPC Site Bottom Area at SHWT	6.81 AC
Storage Depth	4.00 FT.
Unit Length Based on L/W = 2	770 FT.
Unit Width Based on L/W = 2	385 FT.
Horizontal Distance Based on a 1:4 Slope and Storage Depth	32 FT.
Total Pond Length (including grade adjustments)	802 FT.
Total Pond Width (including grade adjustments)	417 FT.
Total Area (including grade adjustments but no berms)	7.68 AC.
Compensation Provided	28.99 AC.FT.
Maintenance Berm Width of 15-ft	30 FT.
Total Pond Length (including maintenance berm)	832.31 FT.
Total Pond Width (including maintenance berm)	447.15 FT.
Preliminary Property Size Required	8.54 AC.
MINIMUM PROPERTY SIZE FOR FLOODPLAIN COMPENSATION	8.54 AC.



Project Name: I-75 Rest Areas PD&E
Project Number: 104-0007-000
Task Description: Floodplain Comp

Prepared by: FAM
Checked by: RMG
Date: 11/17/2016

NB-2B Rest Area			
	Area (ac.)	Depth (ft)	Volume (ac-ft)
Impact	9.35	1.1	10.29

NB-2B EXISTING GROUND/SHWT ELEVATIONS	
Floodplain Impact Area	
Floodplain Elev.	12.00'
Existing Ground Elev.	10.90'

NB-2B TOTAL COMP. REQ. = 10.29 ac.ft.

Note: The floodplain compensation site for this alternative is located north of Airport Road



Project Name: I-75 Rest Areas PD&E
Project Number: 104-0007-000
Task Description: Estimation of ROW Requirement

Prepared by: FAM
Checked by: RMG
Date: 11/17/2016

FLOODPLAIN ROW REQUIREMENTS - Alternate NB 2B

FEMA Floodplain Elevation	11.00 NGVD (Zone AE From FEMA Map)
Existing Ground at Comp Site	10.50 NGVD (Estimated From GIS Topographic Information)
Elev SHW =	6.50 NGVD based on SWFWMD Permit No. 43000164.038
Floodplain Impact	10.29 AC-FT.
FPC Site Bottom Area at SHWT	2.40 AC
Storage Depth	4.00 FT.
Unit Length Based on L/W = 2	457 FT.
Unit Width Based on L/W = 2	229 FT.
Horizontal Distance Based on a 1:4 Slope and Storage Depth	32 FT.
Total Pond Length (including grade adjustments)	489 FT.
Total Pond Width (including grade adjustments)	261 FT.
Top Area (including grade adjustments but no berms)	2.93 AC.
Compensation Provided	10.65 AC.FT.
Maintenance Berm Width of 15-ft	30 FT.
Total Pond Length (including maintenance berm)	519.26
Total Pond Width (including maintenance berm)	290.63
Preliminary Property Size Required	3.46 AC.
MINIMUM PROPERTY SIZE FOR FLOODPLAIN COMPENSATION	3.46 AC.



Project Name: I-75 Rest Areas PD&E
Project Number: 104-0007-000
Task Description: Floodplain Comp

Prepared by: FAM
Checked by: RMG
Date: 11/17/2016

NB WIM Rest Area			
	Area (ac.)	Depth (ft)	Volume (ac-ft)
Impact	6.97	0.70	4.88

NB-WIM EXISTING GROUND/SHWT ELEVATIONS	
Floodplain Impact Area	
Floodplain Elev.	20.70'
Existing Ground Elev.	20.00'

NB-WIM TOTAL COMP. REQ. =	4.88 ac.ft.
----------------------------------	--------------------



Project Name: I-75 Rest Areas PD&E
Project Number: 104-0007-000
Task Description: Estimation of ROW Requirement

Prepared by: FAM
Checked by: RMG
Date: 11/17/2016

FLOODPLAIN ROW REQUIREMENTS - Alternate NB WIM

FEMA Floodplain Elevation 20.70 NGVD (Zone A Estimated From FEMA Map)
Existing Ground at Comp Site 21.00 NGVD (Estimated From GIS Topographic Information)
Elev SHW = 19.50 NGVD (Estimated From NRCS Soil Survey)



Floodplain Impact	4.88 AC-FT.
FPC Site Bottom Area at SHWT	3.30 AC
Storage Depth	1.50 FT.
Unit Length Based on L/W = 2	536 FT.
Unit Width Based on L/W = 2	268 FT.
Horizontal Distance Based on a 1:4 Slope and Storage Depth	12 FT.
Total Pond Length (including grade adjustments)	548 FT.
Total Pond Width (including grade adjustments)	280 FT.
Top Area (including grade adjustments but no berms)	3.52 AC.
Compensation Provided	5.12 ac.ft.
Maintenance Berm Width of 15-ft	30 FT.
Total Pond Length (including maintenance berm)	578.19
Total Pond Width (including maintenance berm)	310.09
Preliminary Property Size Required	4.12 AC.
MINIMUM PROPERTY SIZE FOR FLOODPLAIN COMPENSATION	4.12 AC.

Note: Compensation site at higher elevation than location where impacts occur

APPENDIX C
Excerpts from Existing Permits

SEE SHEET 35

(BORROW PIT 5)
TOB=12.5
SHWL=6.5
DHWL-100 YR/24 HR EL.=12.05
DHWL-25 YR/24 HR. EL.=10.92

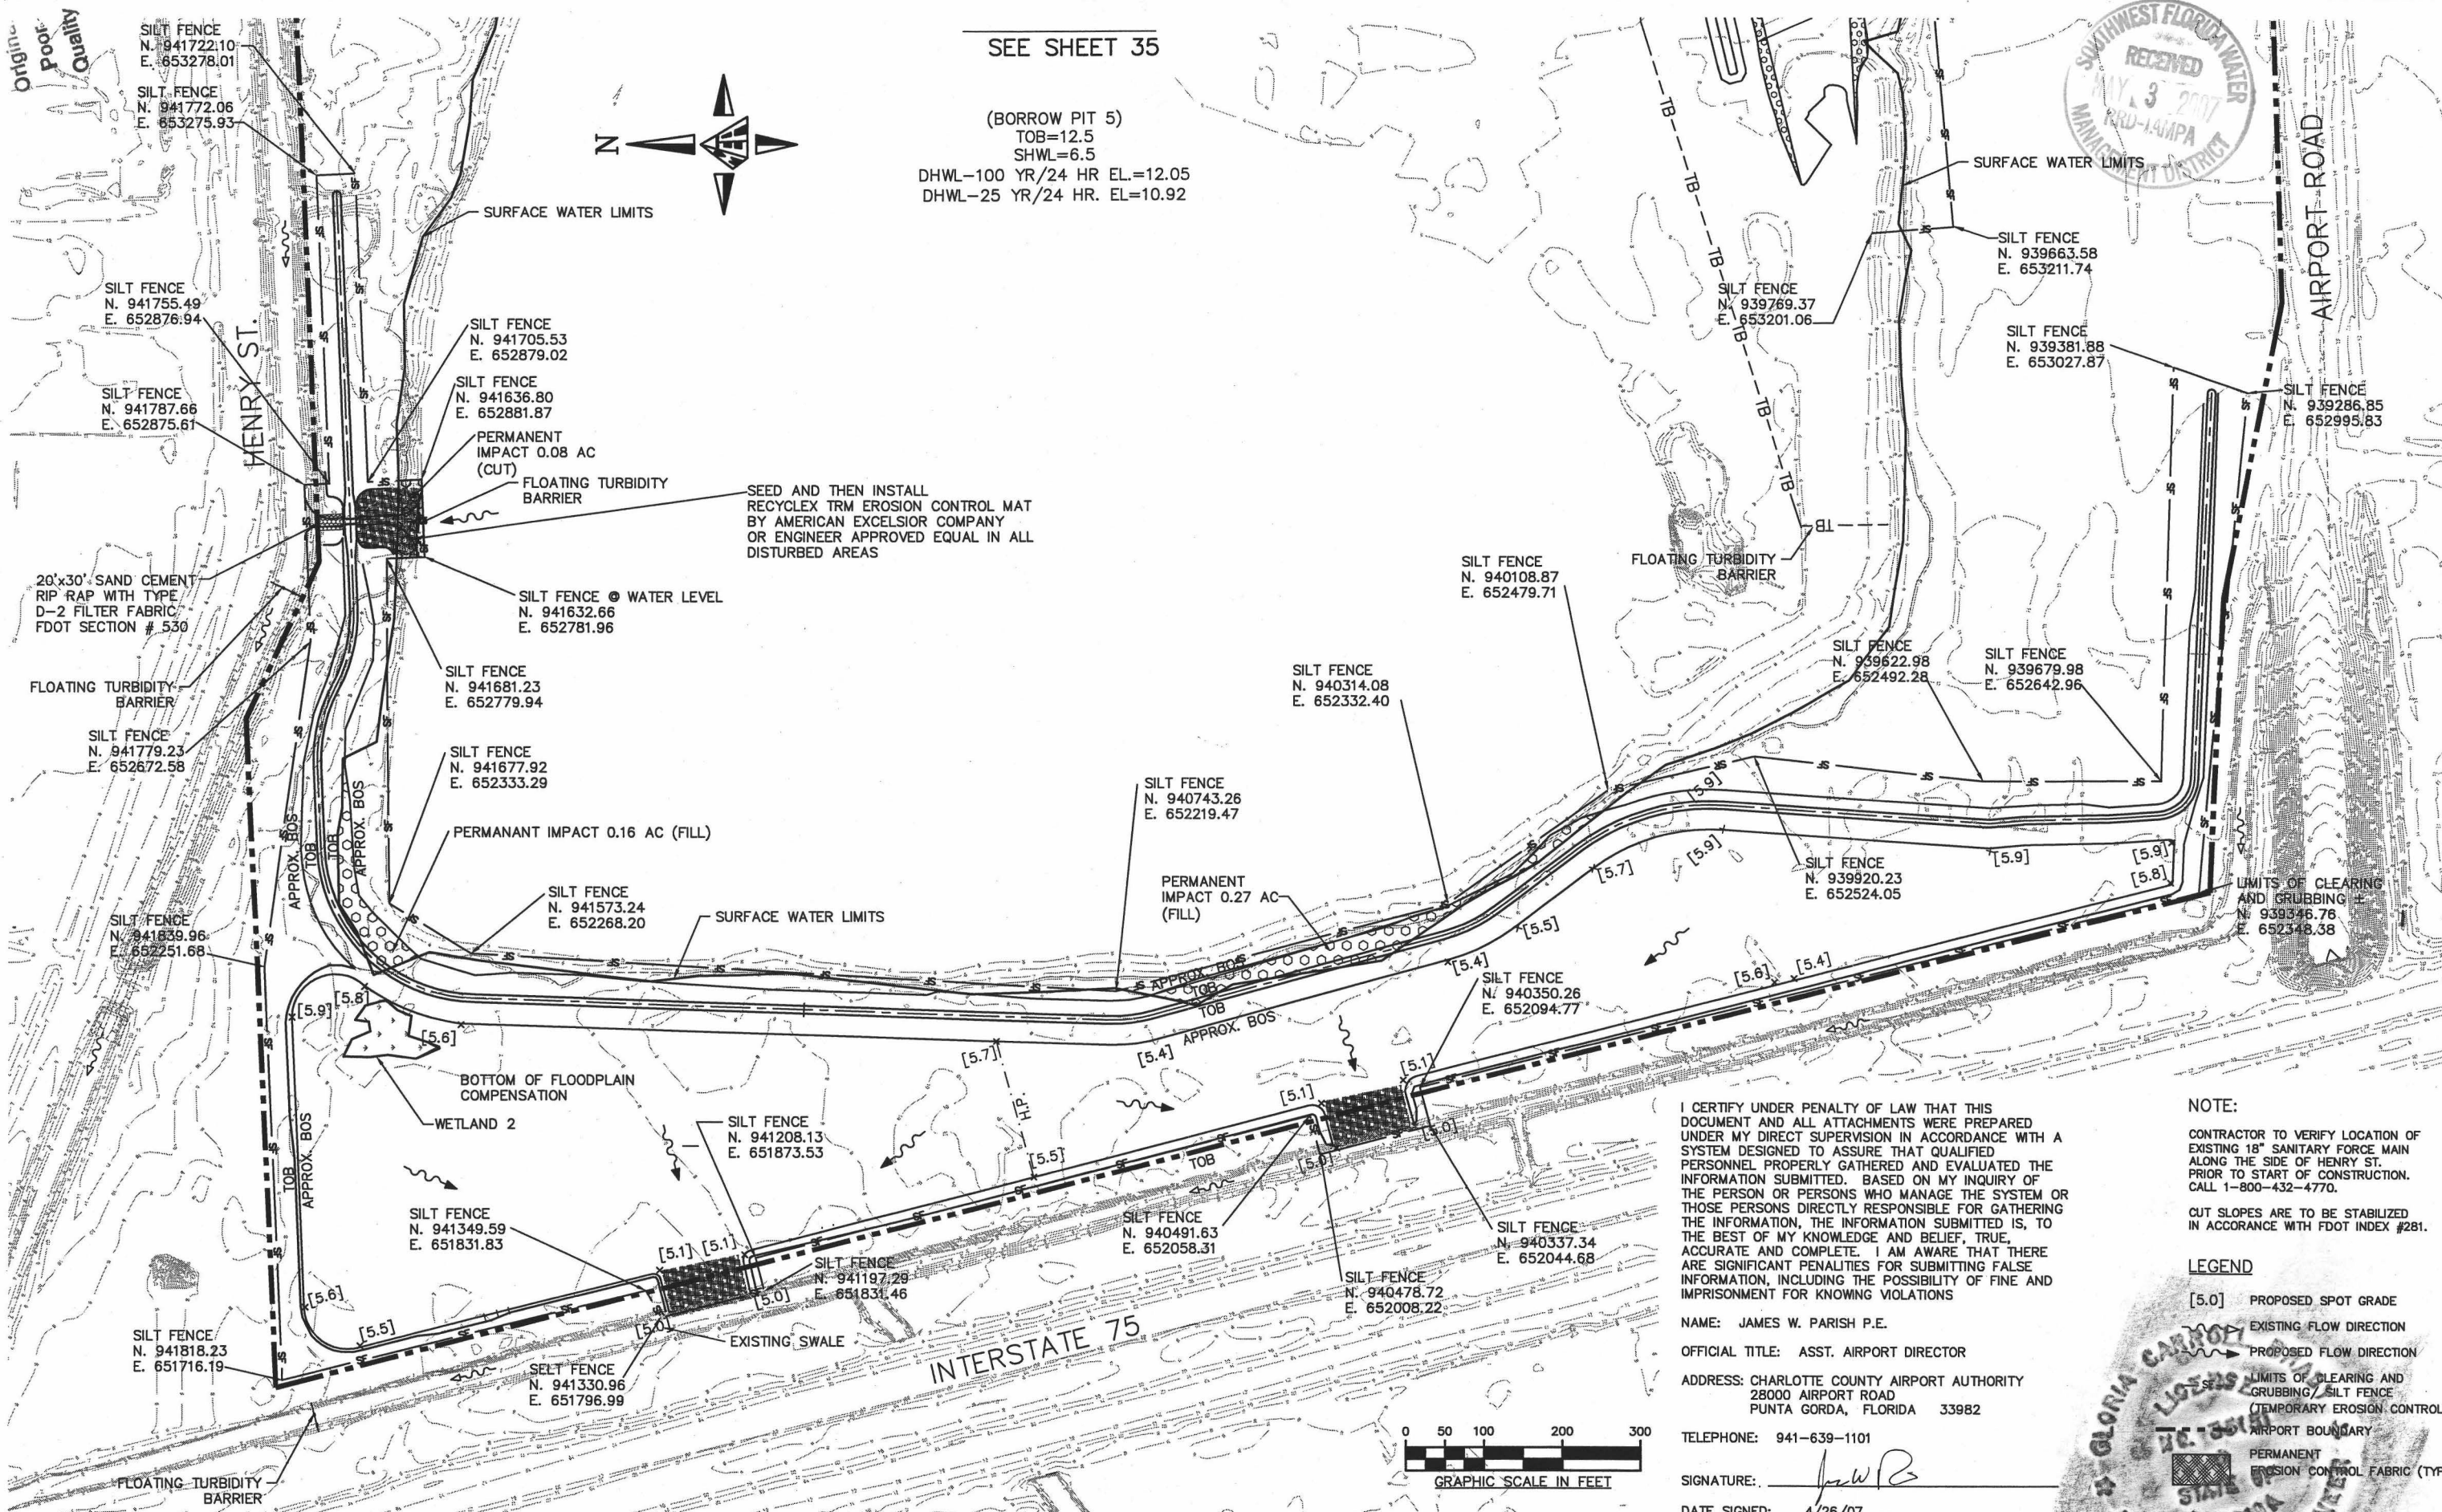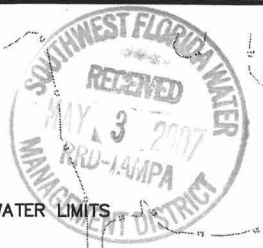


I CERTIFY UNDER PENALTY OF LAW THAT THIS DOCUMENT AND ALL ATTACHMENTS WERE PREPARED UNDER MY DIRECT SUPERVISION IN ACCORDANCE WITH A SYSTEM DESIGNED TO ASSURE THAT QUALIFIED PERSONNEL PROPERLY GATHERED AND EVALUATED THE INFORMATION SUBMITTED. BASED ON MY INQUIRY OF THE PERSON OR PERSONS WHO MANAGE THE SYSTEM OR THOSE PERSONS DIRECTLY RESPONSIBLE FOR GATHERING THE INFORMATION, THE INFORMATION SUBMITTED IS, TO THE BEST OF MY KNOWLEDGE AND BELIEF, TRUE, ACCURATE AND COMPLETE. I AM AWARE THAT THERE ARE SIGNIFICANT PENALTIES FOR SUBMITTING FALSE INFORMATION, INCLUDING THE POSSIBILITY OF FINE AND IMPRISONMENT FOR KNOWING VIOLATIONS

NAME: JAMES W. PARISH P.E.
OFFICIAL TITLE: ASST. AIRPORT DIRECTOR
ADDRESS: CHARLOTTE COUNTY AIRPORT AUTHORITY
28000 AIRPORT ROAD
PUNTA GORDA, FLORIDA 33982
TELEPHONE: 941-639-1101
SIGNATURE: [Signature]
DATE SIGNED: 4/26/07

NOTE:
CONTRACTOR TO VERIFY LOCATION OF EXISTING 18" SANITARY FORCE MAIN ALONG THE SIDE OF HENRY ST. PRIOR TO START OF CONSTRUCTION. CALL 1-800-432-4770.
CUT SLOPES ARE TO BE STABILIZED IN ACCORDANCE WITH FDOT INDEX #281.

LEGEND
[5.0] PROPOSED SPOT GRADE
[Symbol] EXISTING FLOW DIRECTION
[Symbol] PROPOSED FLOW DIRECTION
[Symbol] LIMITS OF CLEARING AND GRUBBING/ SILT FENCE (TEMPORARY EROSION CONTROL)
[Symbol] AIRPORT BOUNDARY
[Symbol] PERMANENT EROSION CONTROL FABRIC (TYP)

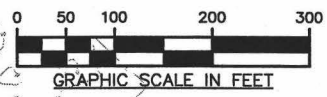

C:\P\03\99003.2\2006 UPDT MDP V2.0 DWG\Surface Water Management Improvements\99003.2_SWMSI_ESCP-PI.dwg Apr 30, 2007 - 5:01pm janderson

MEA GROUP, INC.
CONSULTING ENGINEERS AND PLANNERS
9015 TOWN CENTER PARKWAY, SUITE 105
LAKEWOOD RANCH, FLORIDA 34202
PHONE: 941 342-6321
FAX NO.: 941 379-6474
EB-0006170

DATE		BY	DESCRIPTION	REVISIONS	DATE	BY	DESCRIPTION
4/24/07		JEA	REVISED PER SWFMD COMMENTS 4/13/07				

SCALE	AS SHOWN	CLIENT
DESIGNED	GB 6/25/06	CHARLOTTE COUNTY AIRPORT AUTHORITY
DRAWN	JEA 6/25/06	
CHECKED	GCB 6/25/06	PROJECT NO. 99003.2

PROJECT NAME
SURFACE WATER MANAGEMENT SYSTEM IMPROVEMENTS

SHEET NAME
SURFACE STORMWATER MANAGEMENT PLAN

APPROVAL
[Signature]
DATE 4/26/07
REGISTERED ENGINEER NO. 35151
STATE OF FLORIDA
SHEET NO. 34

STATE OF FLORIDA
DEPARTMENT OF TRANSPORTATION

PLANS OF PROPOSED
STATE HIGHWAY


W.P.I. No. 1141032

FISCAL YEAR	SHEET NO.
92	1

THIS CONTRACT PLAN SET INCLUDES

- SUMMARY OF PAY ITEMS (SHEETS)
- ROADWAY PLANS
- SIGNING AND PAVEMENT MARKING PLANS
- SIGNALIZATION PLANS
- WEIGH IN MOTION PLANS
- ROADWAY LIGHTING PLANS
- BUILDING RENOVATIONS
- LIGHTNING PROTECTION PLANS

A DETAILED INDEX APPEARS ON THE KEY SHEET OF EACH GROUP OF PLANS.

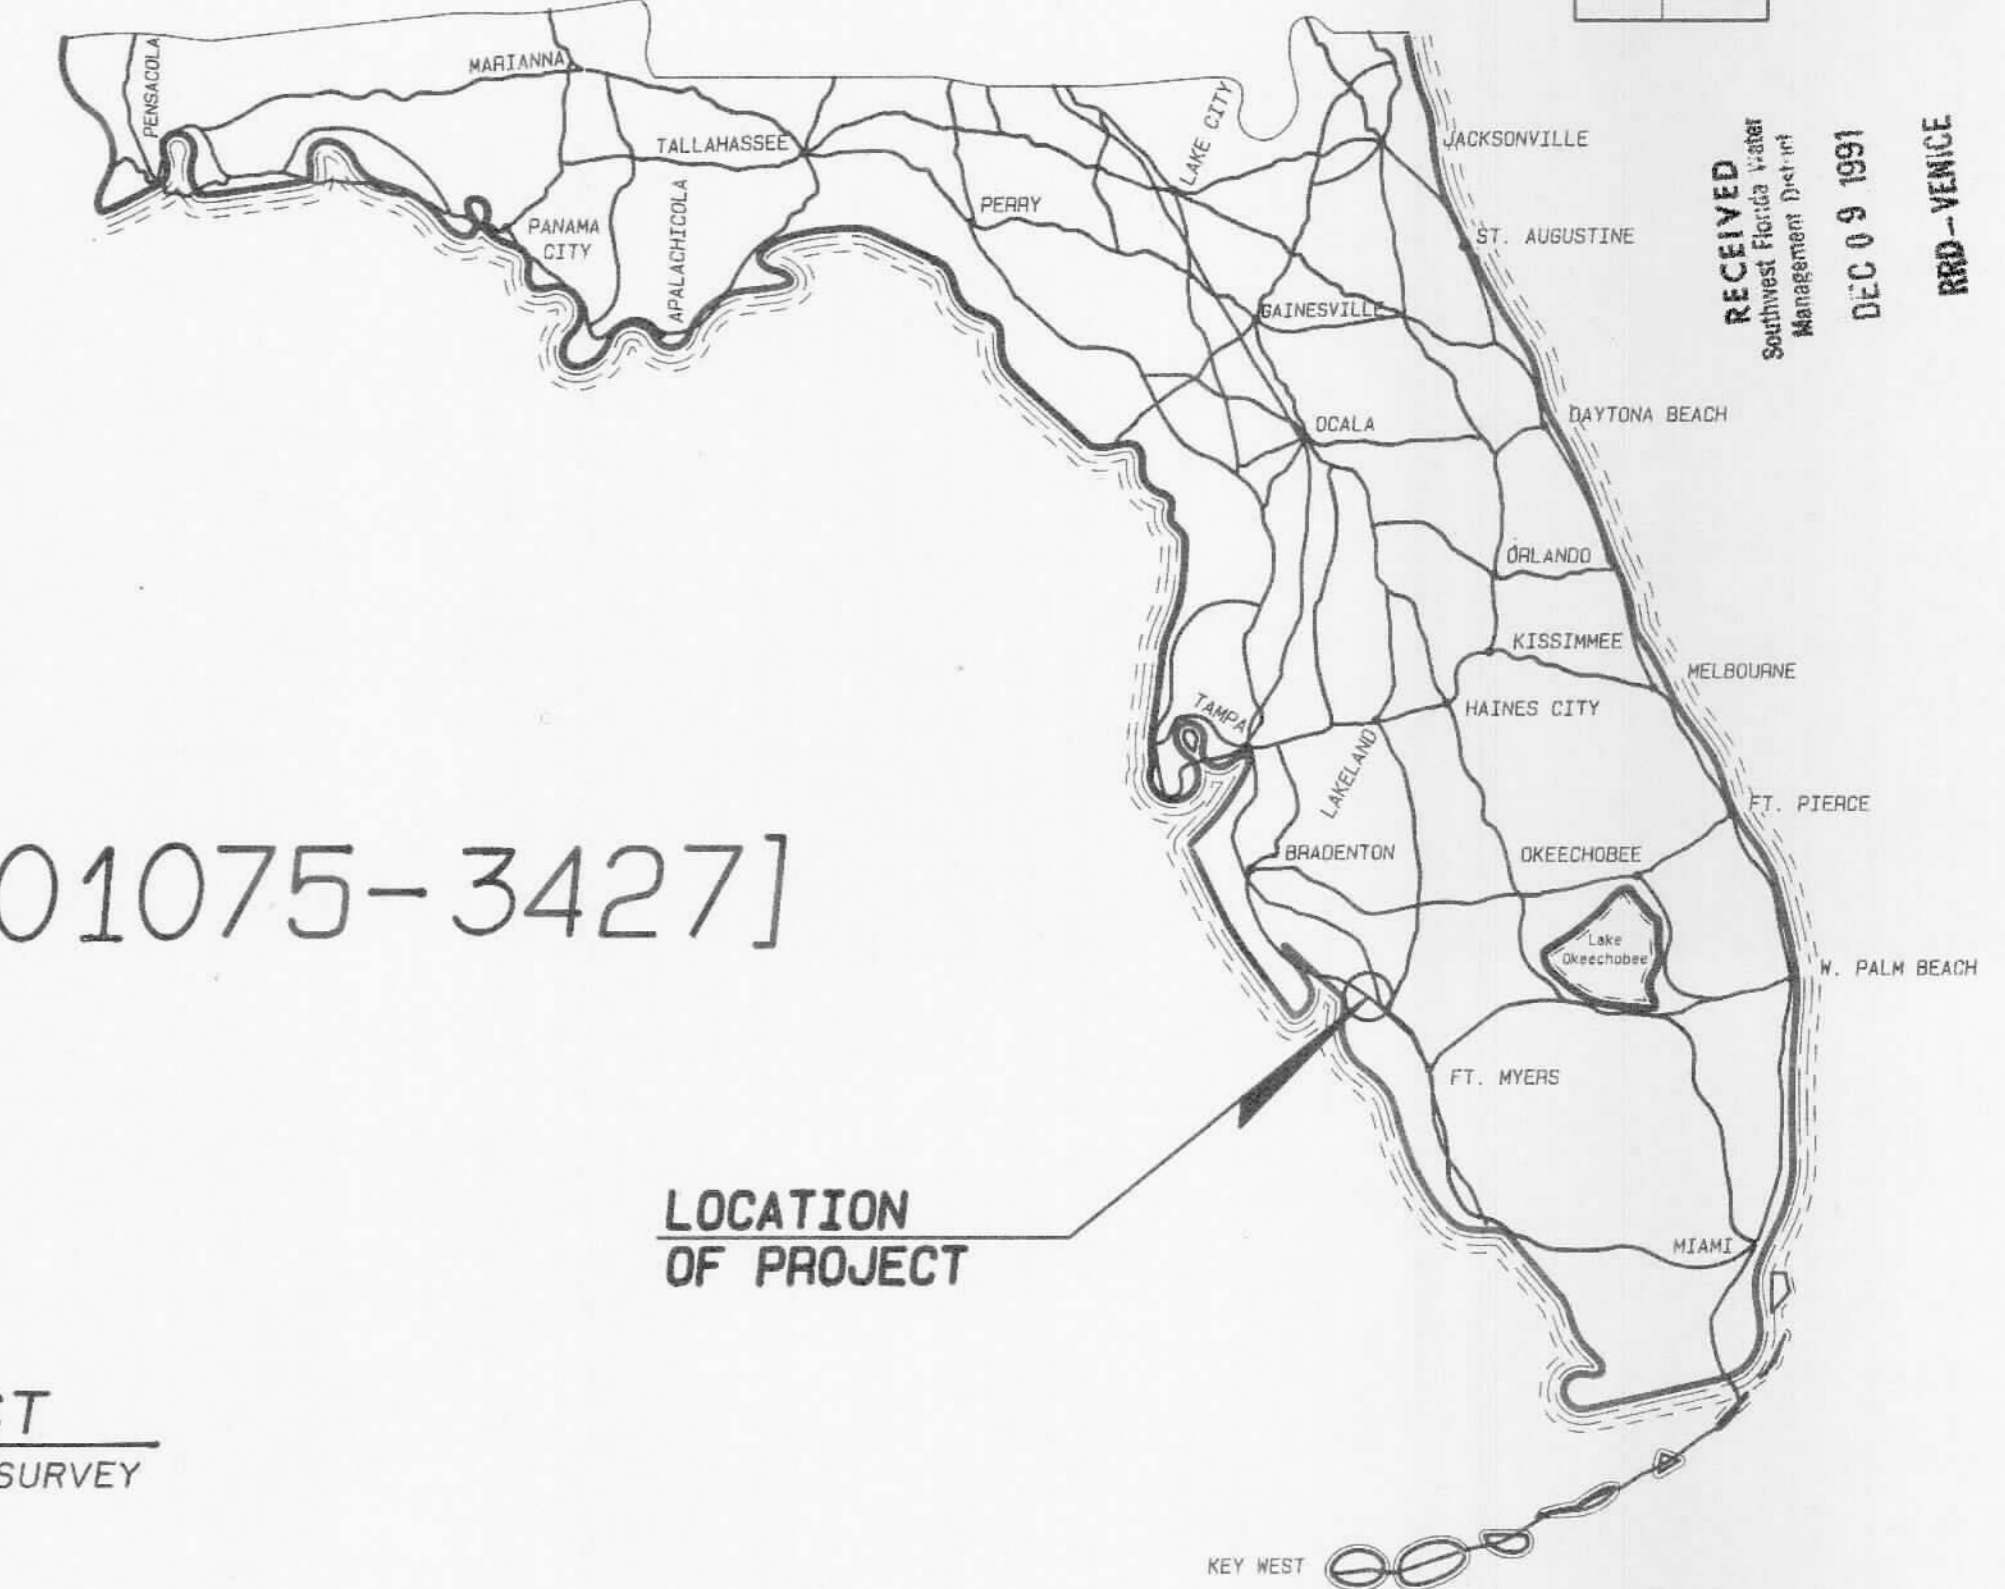

RECEIVED
Southwest Florida Water
Management District
DEC 9 1991
BRD-VENTICE


F.A.PROJ.No. IR-75-5 (56) 159 [STATE PROJ.No. 01075-3427]
CHARLOTTE COUNTY
I-75 PUNTA GORDA WEIGH STATION

INDEX OF ROADWAY PLANS

SHEET NO.	SHEET DESCRIPTION
1	KEY SHEET
2	DRAINAGE MAP
3-5	TYPICAL SECTIONS
-	SUMMARY OF QUANTITIES
-	SUMMARY OF DRAINAGE STRUCTURES
6-15	PLAN AND PROFILES
16-17	SPECIAL PROFILES
18-19	SUPERELEVATION PROFILES
20-25	DRAINAGE STRUCTURES
26-29	JOINT DETAILS
30	DRAINAGE DETAILS
-	ROADWAY DETAILS
-	SOIL SURVEY
31-59	CROSS SECTIONS
-	TRAFFIC CONTROL PLANS
-	UTILITY ADJUSTMENTS

ROADWAY AND TRAFFIC DESIGN STANDARDS
(BOOKLET DATED JANUARY, 1990)

INDEX NO.	
001	300
002	302
102	305
104	400
105	415
200	451
201	500
205	505
211	510
231	511
232	513
272	517
273	525
280	600
281	610
286	611
290	613
630	630

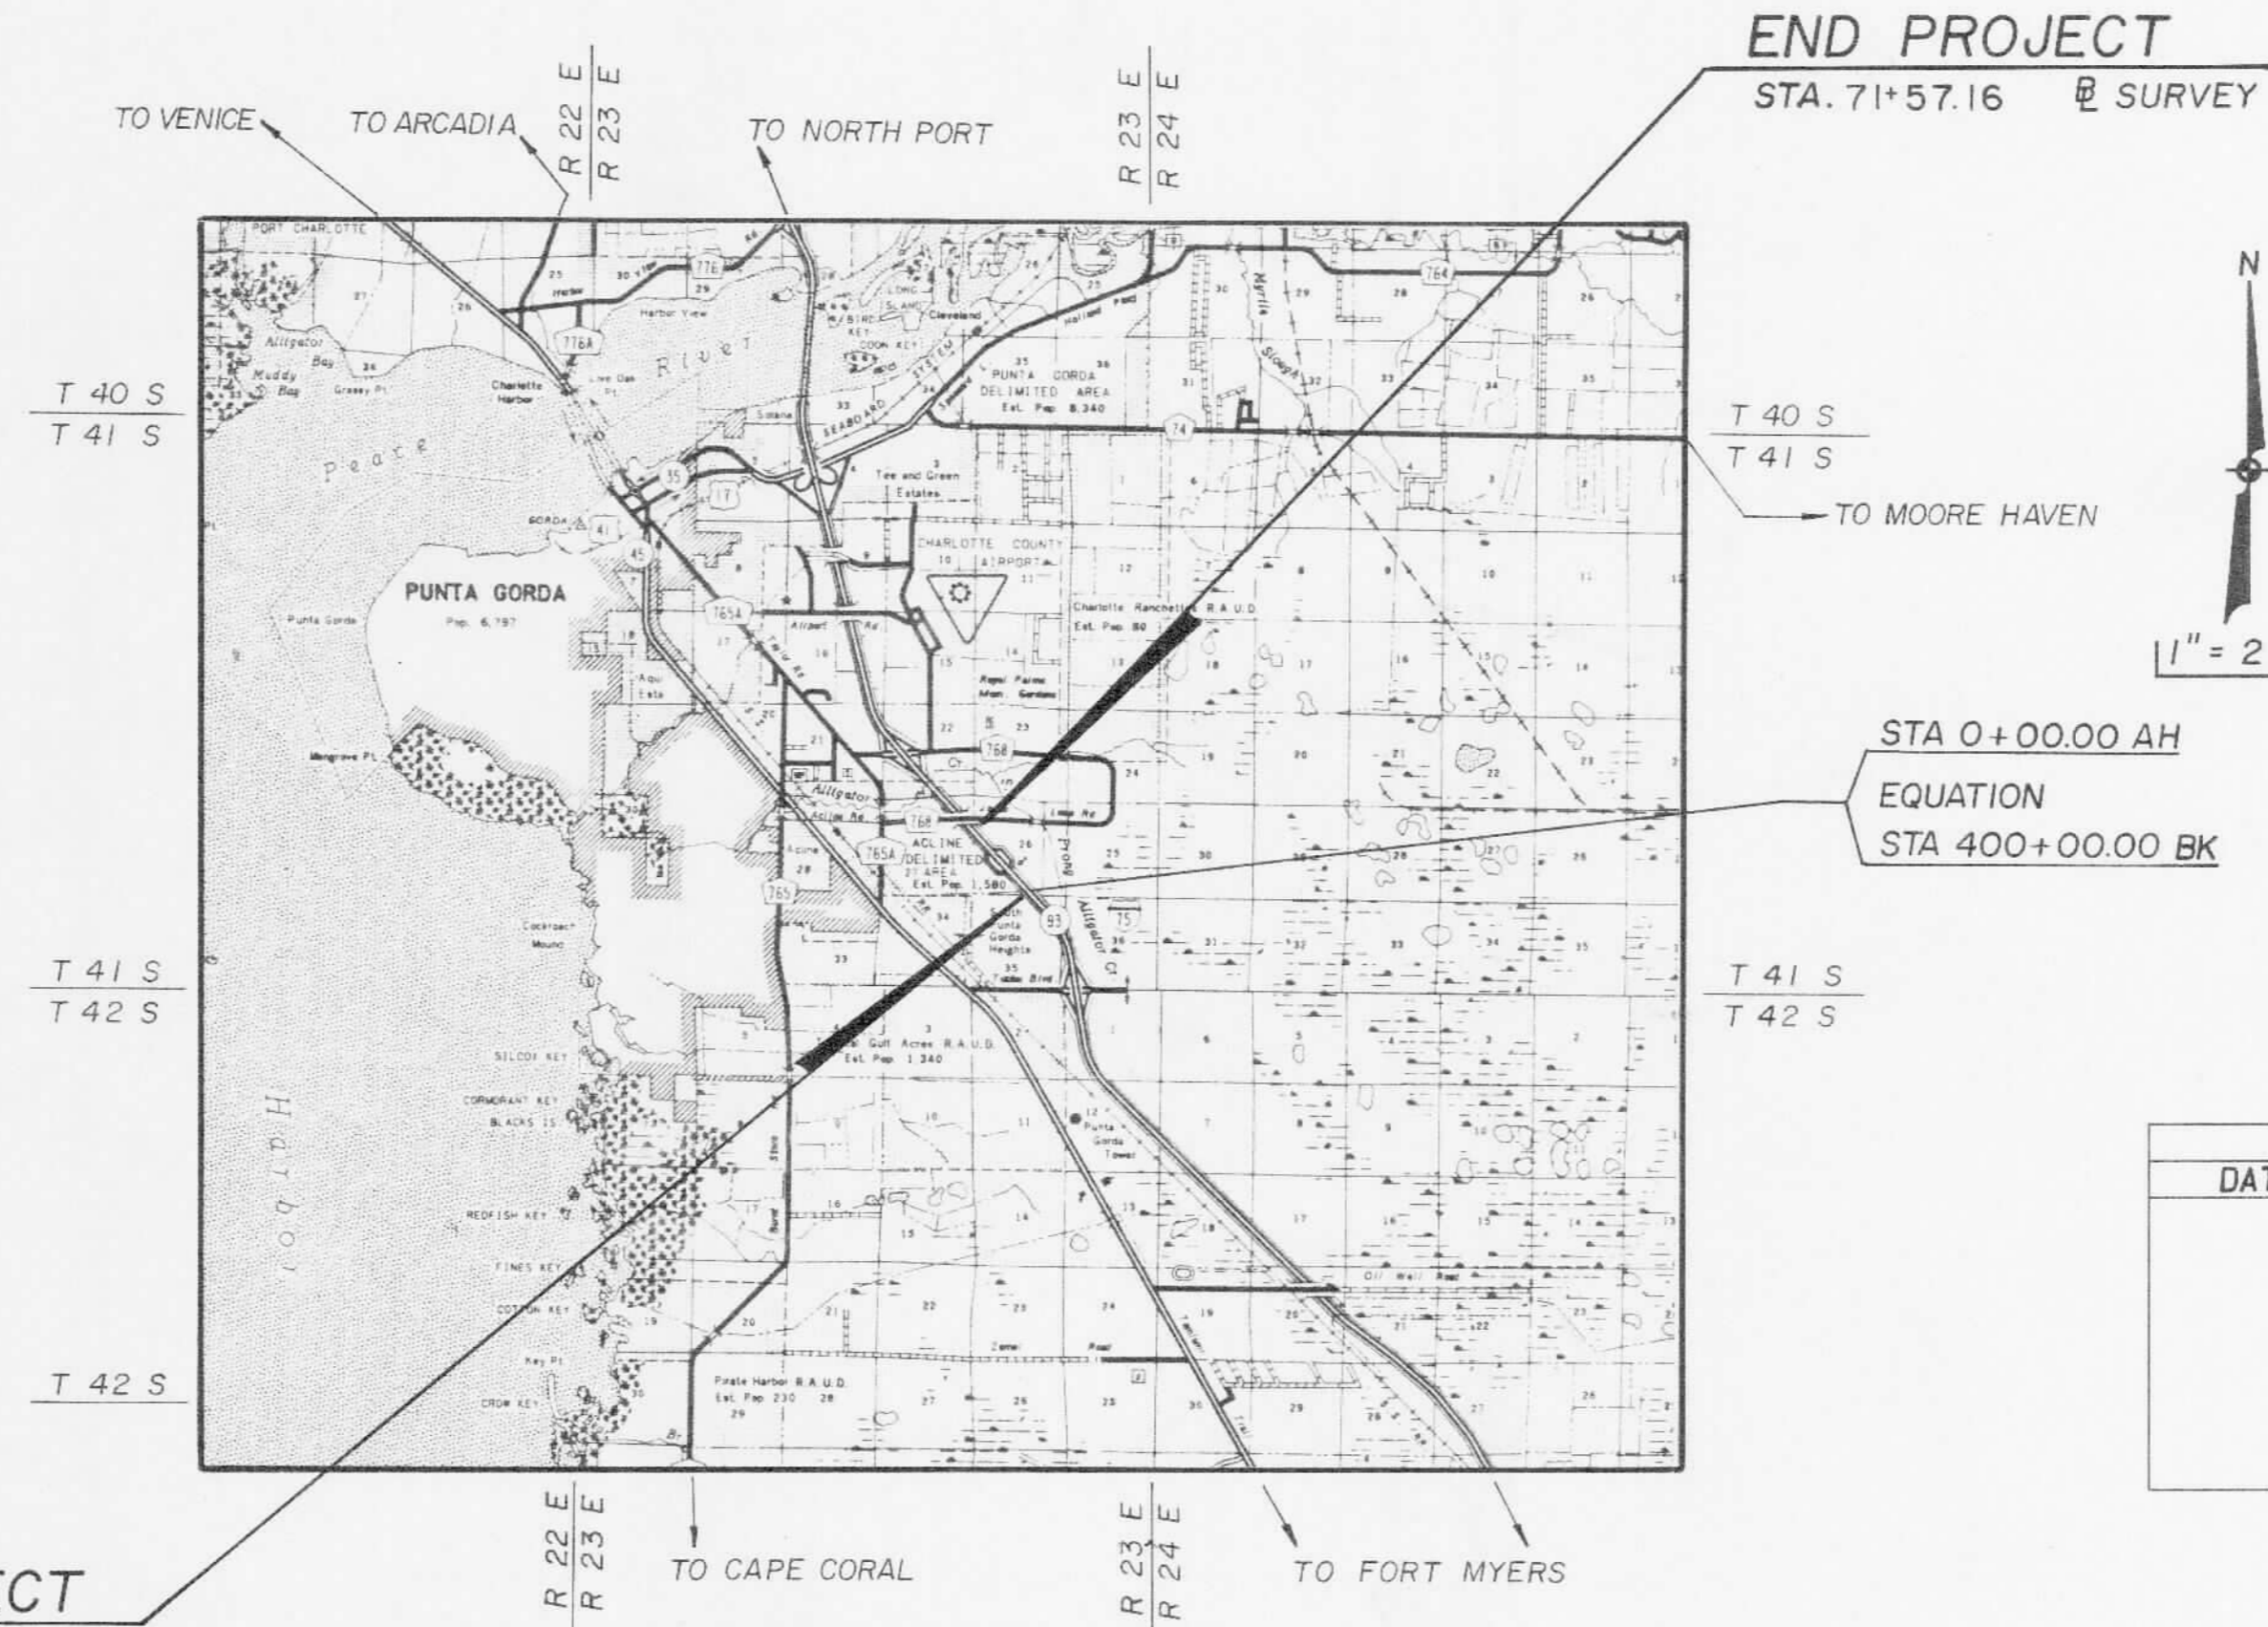

BEGIN PROJECT
STA. 399+38.31 @ SURVEY
M.P. =

END PROJECT
STA. 71+57.16 @ SURVEY

STA 0+00.00 AH
EQUATION
STA 400+00.00 BK

	LENGTH OF PROJECT	
	LIN. FT.	MILES
ROADWAY	7218.85	1.367
BRIDGES	0.00	0.000
NET LENGTH OF PROJECT	7218.85	1.367
EXCEPTIONS	0.00	0.000
GROSS LENGTH OF PROJECT	7218.85	1.367

PROJECT MANAGER H. MICHAEL DOWELL

REVISIONS		
DATE	BY	DESCRIPTION

ROADWAY PLANS APPROVED BY: *[Signature]*
DATE: 2/6/91
P.E. NO: 39406

PLANS ENGINEER OF RECORD
WILLIAM F. BIGGS, P.E.
BOYLE ENGINEERING
CORPORATION OF FLORIDA
5912-A BRECKENRIDGE PARKWAY
TAMPA, FLORIDA 33610
(813) 621-7900

ATTENTION IS DIRECTED TO THE FACT THAT THESE PLANS MAY HAVE BEEN REDUCED IN SIZE BY REPRODUCTION. THIS MUST BE CONSIDERED WHEN OBTAINING SCALED DATA.

GOVERNING SPECIFICATIONS: STATE OF FLORIDA, DEPARTMENT OF TRANSPORTATION, STANDARD SPECIFICATIONS, DATED 1991 AND SUPPLEMENTS THERETO IF NOTED IN THE SPECIAL PROVISIONS FOR THIS PROJECT.

PERMITTEE SHALL NOTIFY IN WRITING THE VENUE PERMITTING DEPARTMENT, SOUTHWEST FLORIDA WATER MANAGEMENT DISTRICT, WHEN CONSTRUCTION BEGINS.


SOUTHWEST FLORIDA WATER MANAGEMENT DISTRICT
PERMITTED CONSTRUCTION

FILE OF RECORD
PERMIT NO. 409592-00




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409592 - 00

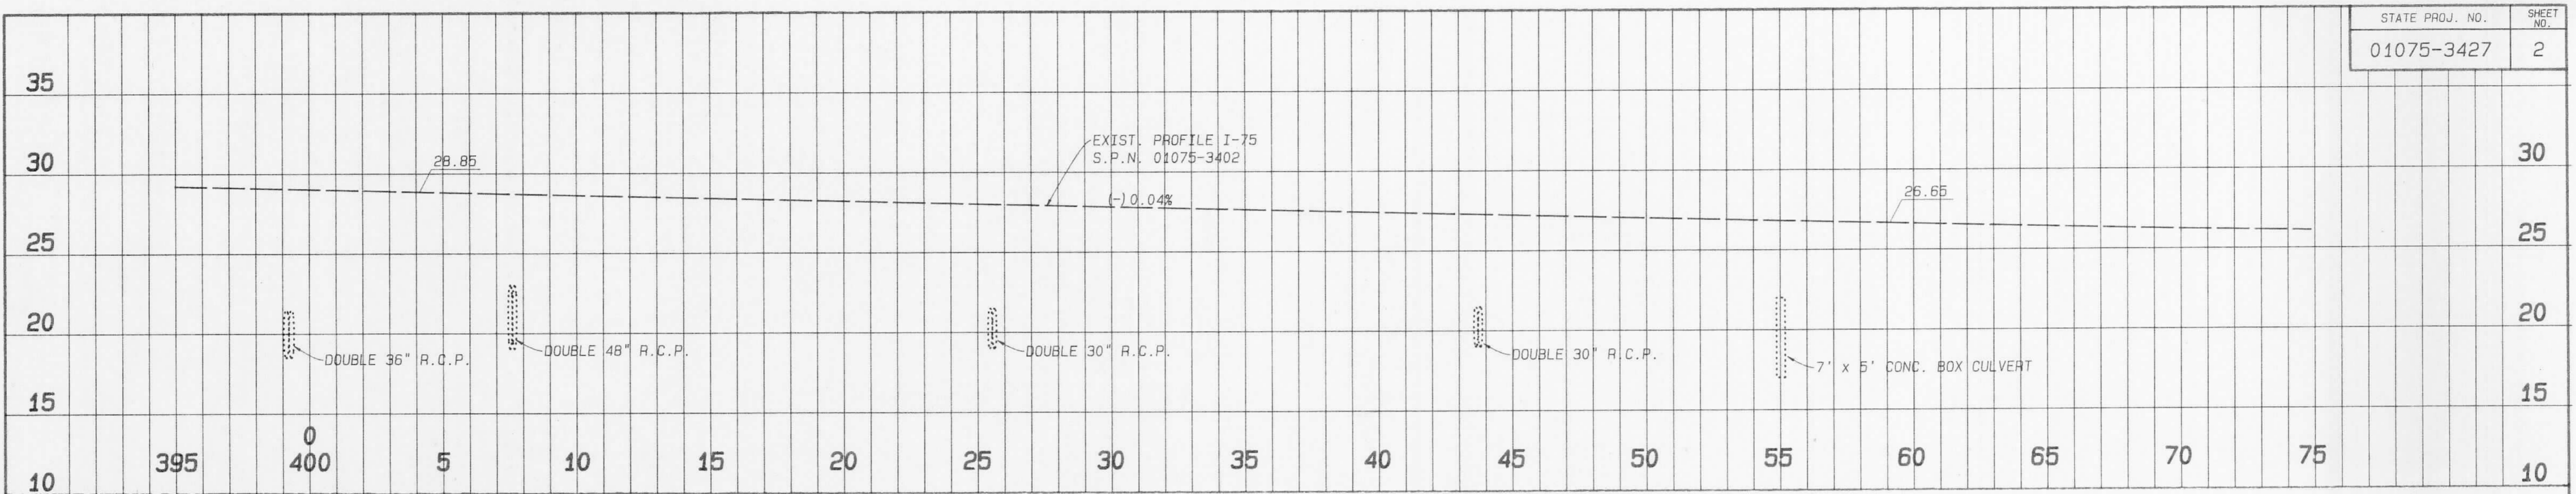

SCALE: 1" = 300'

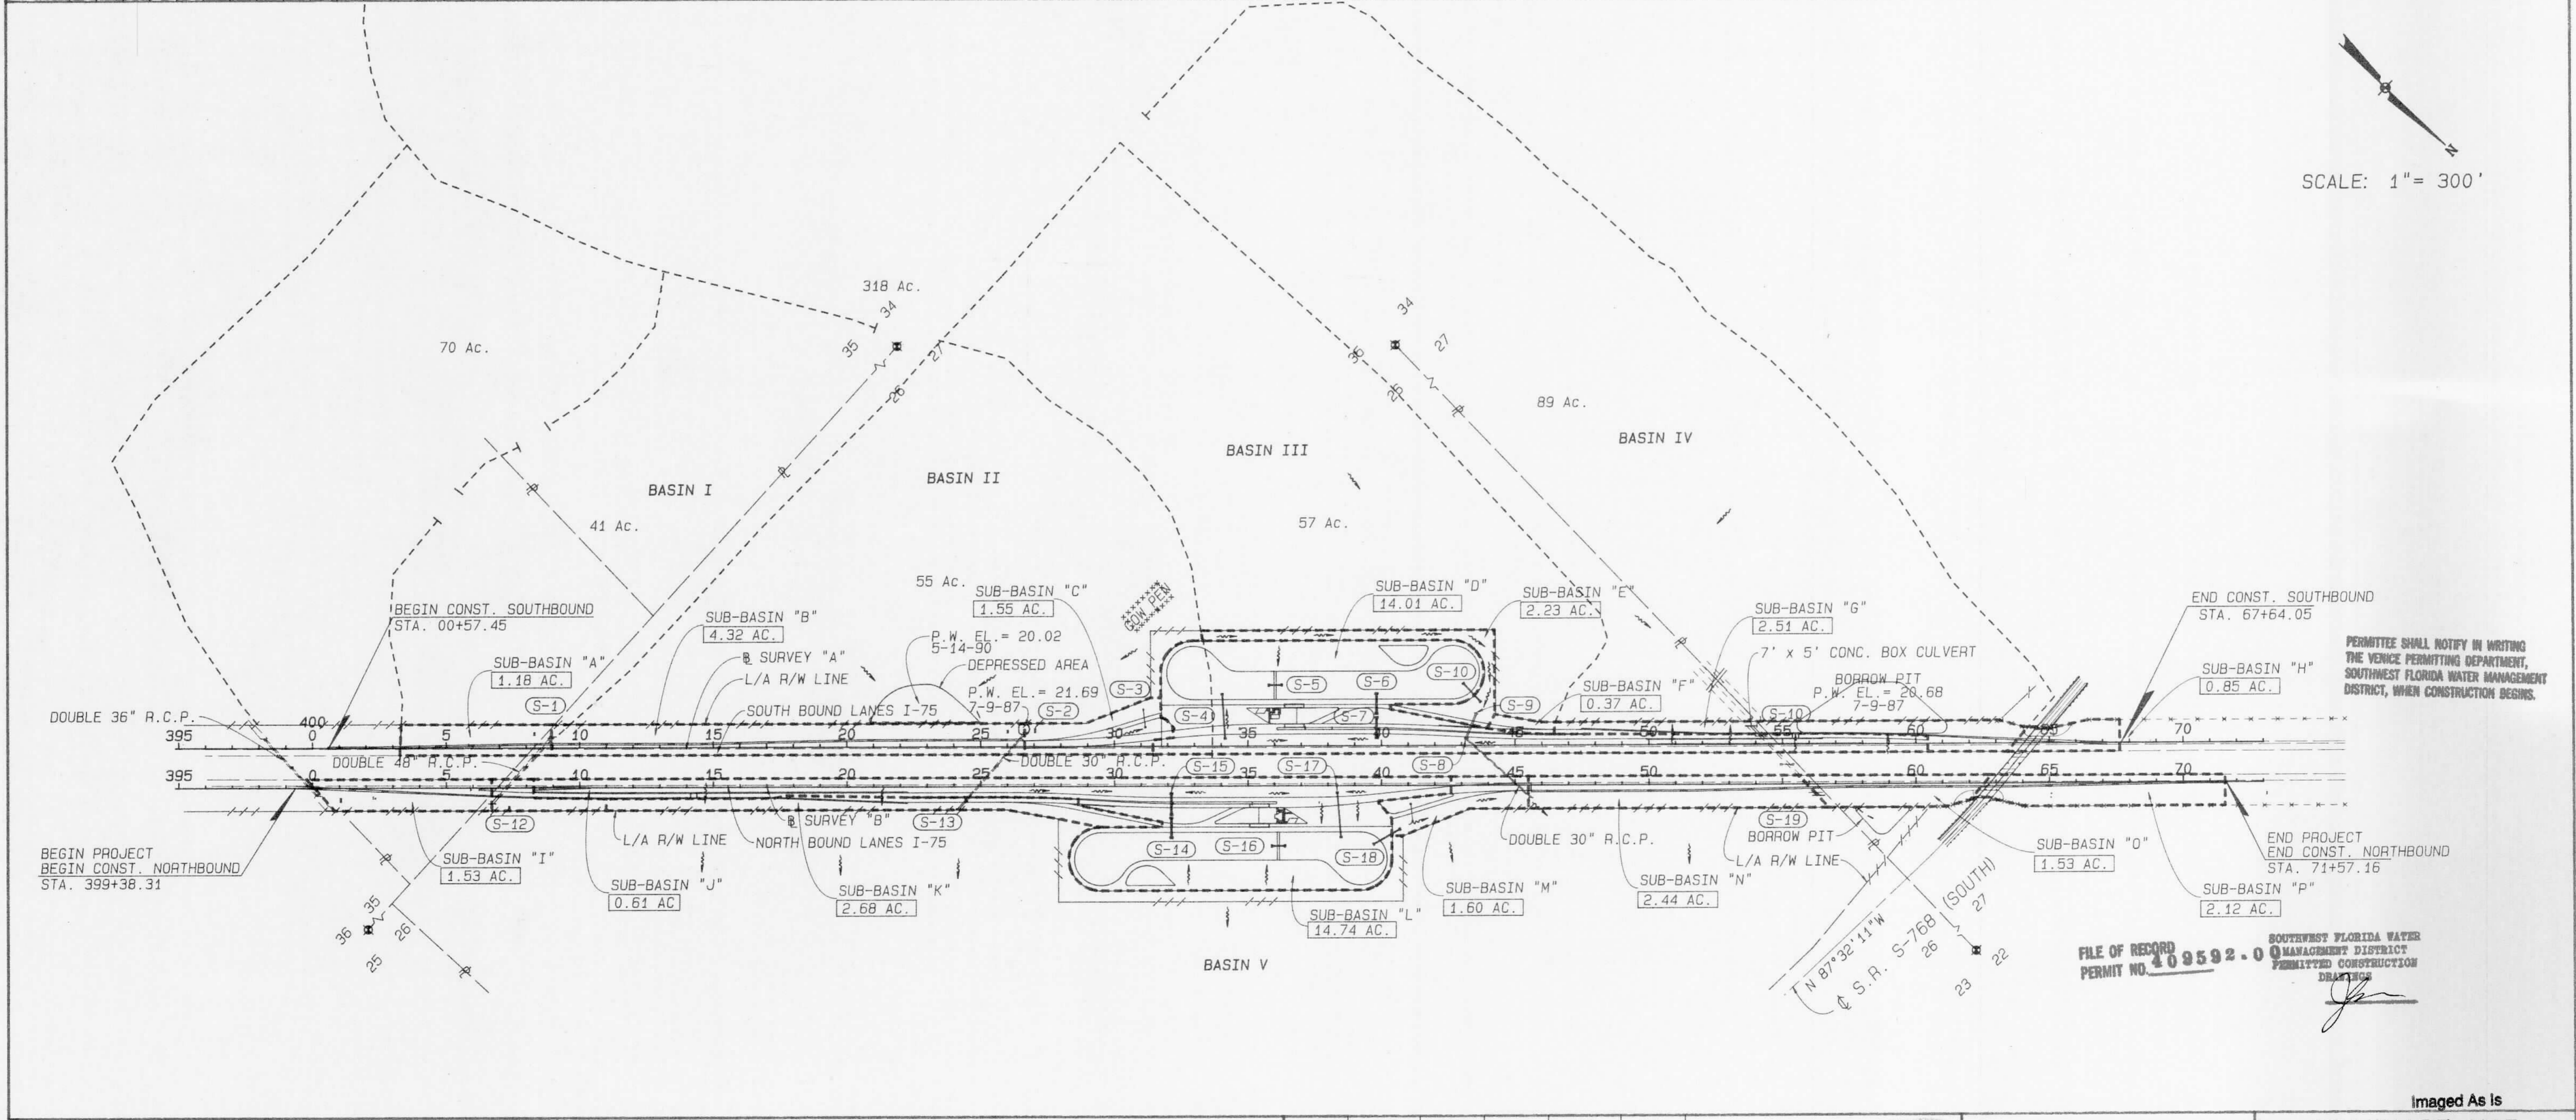

PERMITTEE SHALL NOTIFY IN WRITING THE VENICE PERMITTING DEPARTMENT, SOUTHWEST FLORIDA WATER MANAGEMENT DISTRICT, WHEN CONSTRUCTION BEGINS.

FILE OF RECORD PERMIT NO. 409592-00 SOUTHWEST FLORIDA WATER MANAGEMENT DISTRICT PERMITTED CONSTRUCTION DRAINAGE

REVISIONS							
DATE	BY	DESCRIPTION	DATE	BY	DESCRIPTION	DATE	BY


DR-MAP.DP	NAME	DATE	NAME	DATE
DESIGNED BY	L. CLEGG	9-91	DRAWN BY	S. WEBSTER
CHECKED BY	W.F. BIGGS	9-91	CHECKED BY	L. CLEGG
SUPERVISED BY	WILLIAM F. BIGGS, P.E.			

FLORIDA DEPARTMENT OF TRANSPORTATION
 APPROVED BY: *[Signature]*
 DATE: 9/11/91

Boyle Engineering Corporation
 of Florida
 5512-A Breckinridge Parkway, Tampa, FL 33610-4251 813/621-7900

Imaged As Is
DRAINAGE MAP
 I-75

C:\JUMBLE\TASK\M.BIGGS\WEIGH\PUNTA\S_DR-MAP_DP_SPOOLED ON 04 DEC 1991 AT 16:55:13

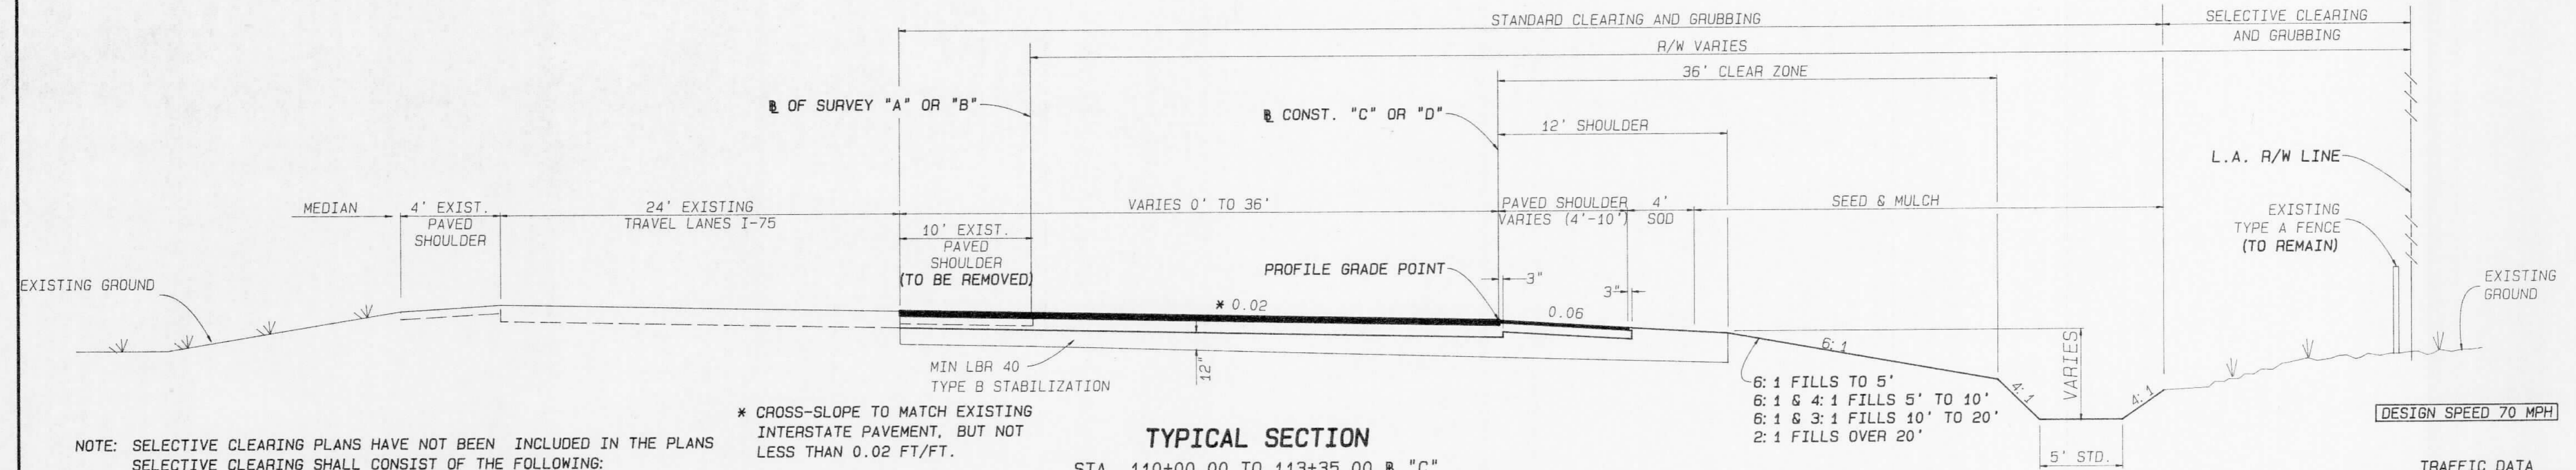

- NOTE: SELECTIVE CLEARING PLANS HAVE NOT BEEN INCLUDED IN THE PLANS. SELECTIVE CLEARING SHALL CONSIST OF THE FOLLOWING:
1. ALL AREAS OUTSIDE OF THE LIMITS OF CONSTRUCTION SHALL REMAIN NATURAL. NO CLEARING OR GRUBBING WILL BE ALLOWED. NO EQUIPMENT SHALL ENTER THESE AREAS.
 2. AS AN EXCEPTION TO THE ABOVE, A TEN FOOT STRIP MAY BE CLEARED FOR FENCE CONSTRUCTION, AND AT A MINIMUM OF 500' INTERVALS A DIAGONAL PATH MAY BE CLEARED TO ALLOW ACCESS FOR FENCE CONSTRUCTION.
 3. WHERE UNFORESEEN SITE CONDITIONS EXIST, ADJUSTMENTS OR OTHER EXCEPTIONS MAY BE MADE, BUT ONLY AT THE DIRECTION OF THE ENGINEER.

* CROSS-SLOPE TO MATCH EXISTING INTERSTATE PAVEMENT, BUT NOT LESS THAN 0.02 FT/FT.

TYPICAL SECTION

STA. 110+00.00 TO 113+35.00	CONST. "C" OR "D"
STA. 110+00.00 TO 150+53.99	CONST. "C" OR "D"
STA. 110+00.00 TO 119+00.00	CONST. "D"
STA. 153+30.00 TO 156+19.42	CONST. "D"
STA. 00+57.45 TO 26+62.64	CONST. "A"
STA. 45+53.15 TO 71+57.16	CONST. "B"

OPTIONAL BASE GROUP 9 (FOR THICKNESS SEE BELOW) WITH TYPE S STRUCTURAL COURSE (4") AND FRICTION COURSE FC-2 (5/8")

BASE GROUP 9

OPTIONAL BASE COURSES PERMITTED	OPTION CODE
10" LIMEROCK BASE COURSE	990
6" ASPHALT BASE COURSE (TYPE 3)	327

PAVED SHOULDER
OPTIONAL BASE GROUP 1 (FOR THICKNESS SEE BELOW) WITH TYPE S STRUCTURAL COURSE (2") AND FRICTION COURSE FC-2 (5/8")


BASE GROUP 1

OPTIONAL BASE COURSES PERMITTED	OPTION CODE
4" LIMEROCK	001
4" ASPHALT BASE COURSE (TYPE 1)	005
4" ASPHALT BASE COURSE (TYPE 2)	006
4" ASPHALT BASE COURSE (TYPE 3)	007

TRAFFIC DATA

1990 ADT = 31593
1994 ADT = 34385
2003 ADT = 40667
2013 ADT = 47647
K = 12% D = 50% T = 14%

FOR ADDITIONAL DETAILS SEE INDEX NOS. 105, 281, 500, 505, 513 & 525

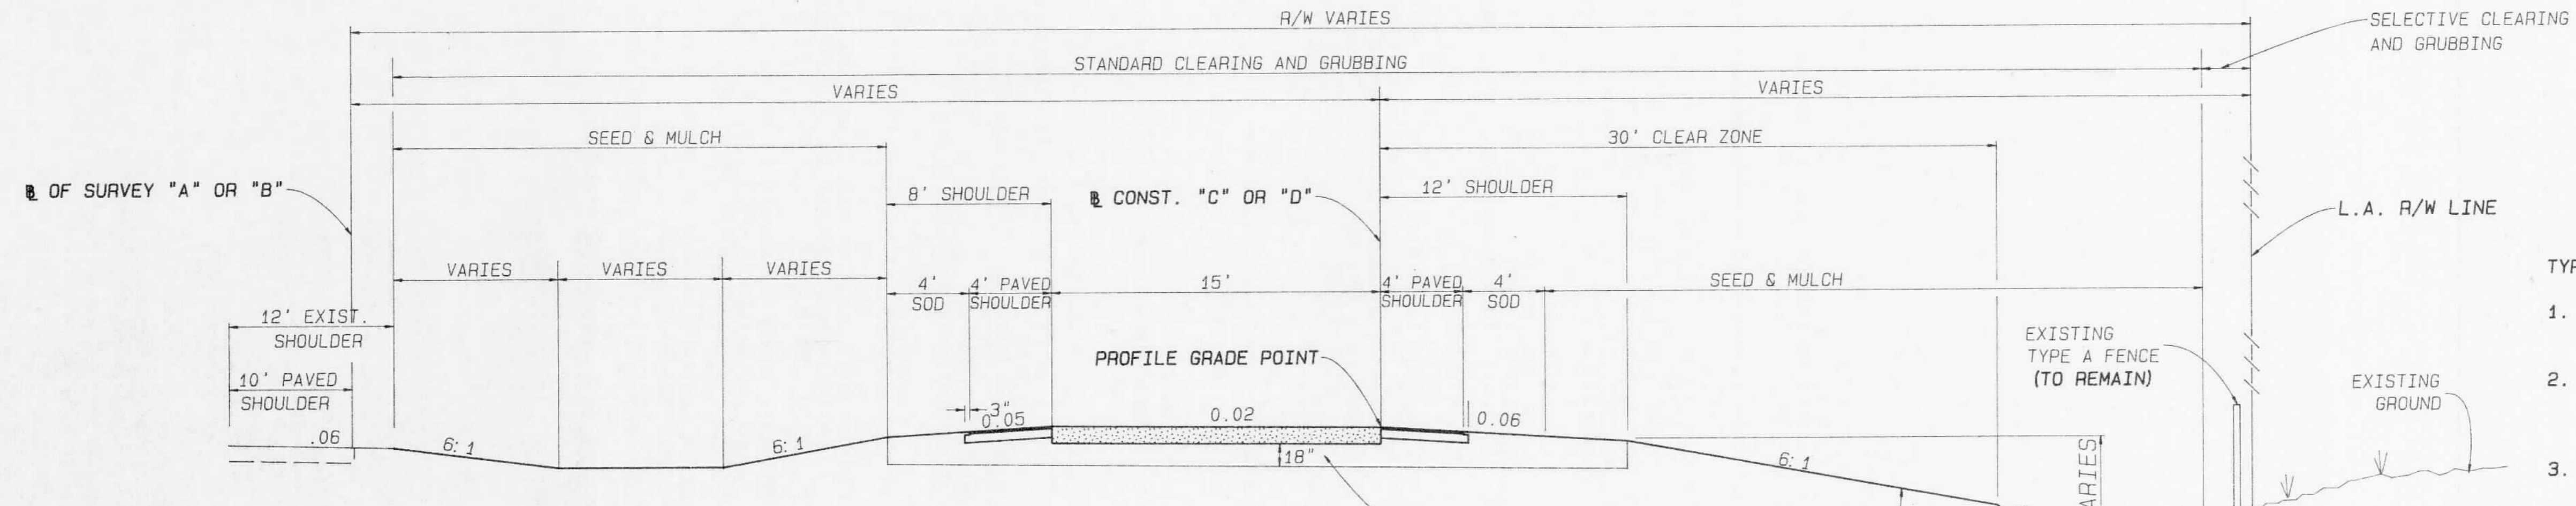

TYPICAL SECTION

STA. 130+86.16 TO 142+00.00	CONST. "C"
STA. 119+00.00 TO 132+88.92	CONST. "D"

PLAIN CEMENT CONCRETE PAVEMENT (13.5")
FOR JOINT LOCATIONS AND EDGE DRAIN DETAILS SEE SHEET

PAVED SHOULDER
OPTIONAL BASE GROUP 1 (FOR THICKNESS SEE ABOVE) WITH TYPE S STRUCTURAL COURSE (2") AND FRICTION COURSE FC-2 (5/8")

FOR ADDITIONAL DETAILS SEE INDEX NOS. 105, 281, 305, 500, 505 & 513

- TYPICAL SECTION NOTES:
1. ALL GRASS AREAS ARE TO RECEIVE A 6" MUCK BLANKET OR TOPSOIL TREATMENT.
 2. NONE OF THE EXISTING LIMEROCK BASE THAT IS REMOVED IS TO BE USED IN THE CONSTRUCTION OF THE NEW LIMEROCK BASE.
 3. ALL OF THE EXISTING LIMEROCK BASE THAT IS REMOVED IS TO BE INCORPORATED IN THE STABILIZED PORTION OF THE SUBGRADE, UNDER THE ASPHALT PAVEMENT ONLY.
 4. THE CONTRACTOR SHOULD IDENTIFY THE 'PROPOSED' OPTION ON WHICH HIS INITIAL BID IS BASED BY ENTERING THE THREE DIGIT OPTION CODE TO THE RIGHT SIDE OF THE ITEM NUMBER OF EACH OF THE OPTIONAL BASE ITEMS ON THE SUBMITTED BID PROPOSAL.
 5. ACTUAL WIDTH OF BASE WIDENING MAY VARY DUE TO ACTUAL EXISTING PAVEMENT WIDTH. CONTRACTOR MAY ELECT TO PLACE UNIFORM WIDTH BASE WIDENING STRIP AT NO ADDITIONAL COST.
 6. TRAFFIC SHALL BE MAINTAINED IN ACCORDANCE WITH THE FDOT ROADWAY AND TRAFFIC DESIGN STANDARDS CURRENT EDITION. ATTENTION IS DIRECTED TO THE INDEX 600 SERIES

PERMITTEE SHALL NOTIFY IN WRITING THE VENICE PERMITTING DEPARTMENT, SOUTHWEST FLORIDA WATER MANAGEMENT DISTRICT, WHEN CONSTRUCTION BEGINS.

SOUTHWEST FLORIDA WATER MANAGEMENT DISTRICT
PERMITTED CONSTRUCTION
DRAWING

FILE OF RECORD
PERMIT NO. 409592.00

Imaged As Is

REVISIONS			
DATE	BY	DESCRIPTION	


TYP-1	NAME	DATE	NAME	DATE
DESIGNED BY	L. CLEGG	9-91	DRAWN BY	S. WEBSTER
CHECKED BY	W. F. BIGGS	9-91	CHECKED BY	L. CLEGG
SUPERVISED BY	WILLIAM F. BIGGS, P.E.			

FLORIDA DEPARTMENT OF TRANSPORTATION
APPROVED BY: [Signature]
DATE: 12/6/91


Boyle Engineering Corporation of Florida
5812-A Breckenridge Parkway, Tampa, FL 33610-4251 813/601-7900

TYPICAL SECTION I-75

C:\JUMBLE\TASK\M-BIGGS\WEIGH\PI\TA\A*.LVP-1 SPOOLED BY CLEGG ON 17 SEP 1991 AT 10:41:01

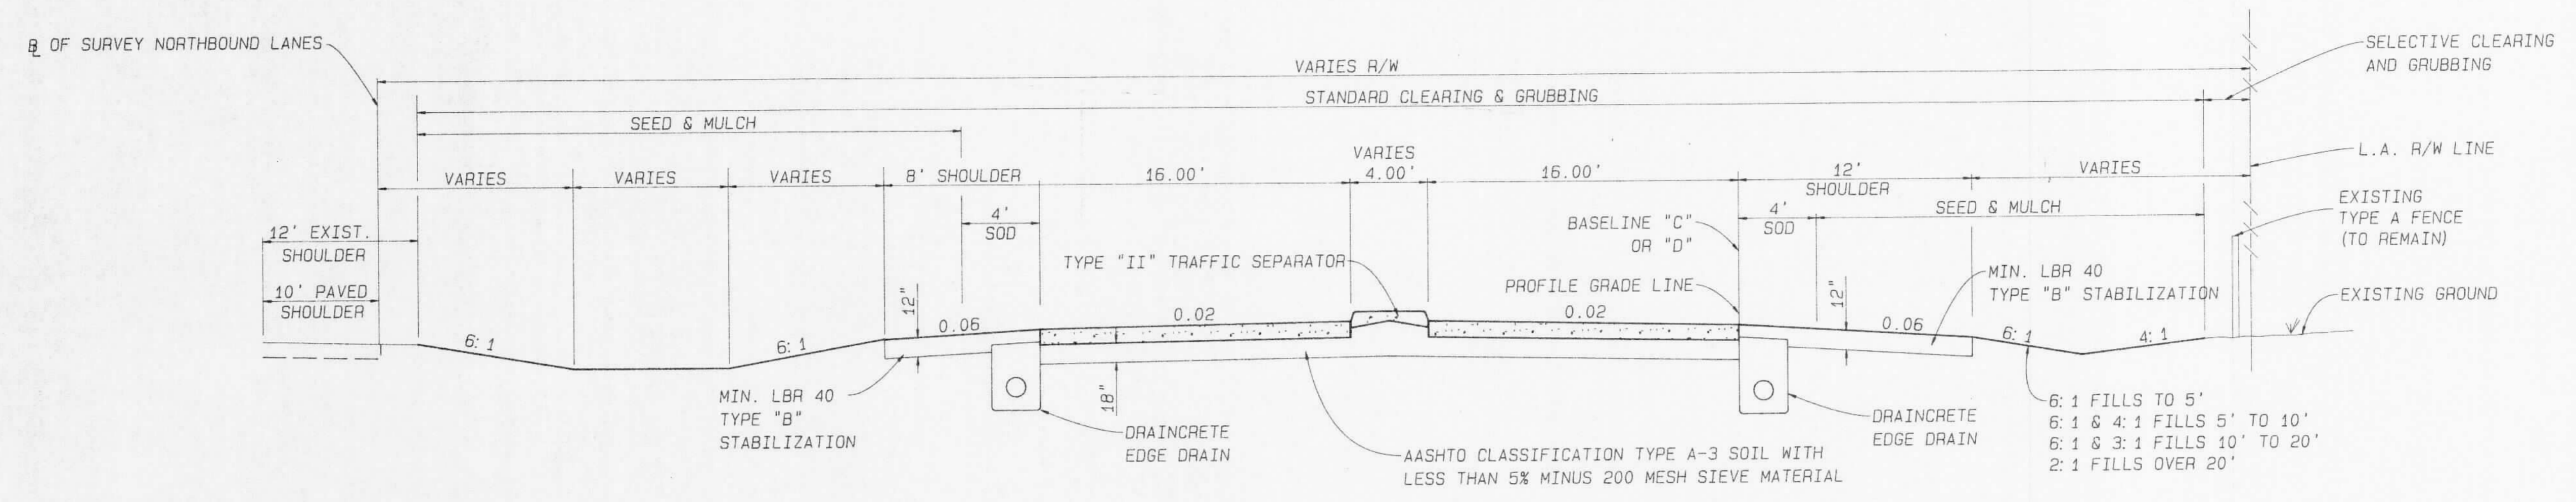

TYPICAL SECTION
 STA 119+45.00 TO 130+86.16 BASELINE "A"
 STA 132+88.92 TO 146+70.00 BASELINE "B"
DESIGN SPEED 50 MPH
 PLAIN CEMENT CONCRETE PAVEMENT (11")
 FOR JOINT LOCATIONS AND EDGE DRAIN DETAILS SEE SHEET
 FOR ADDITIONAL DETAILS SEE INDEX NOS. 105, 281, 305, 500, & 505

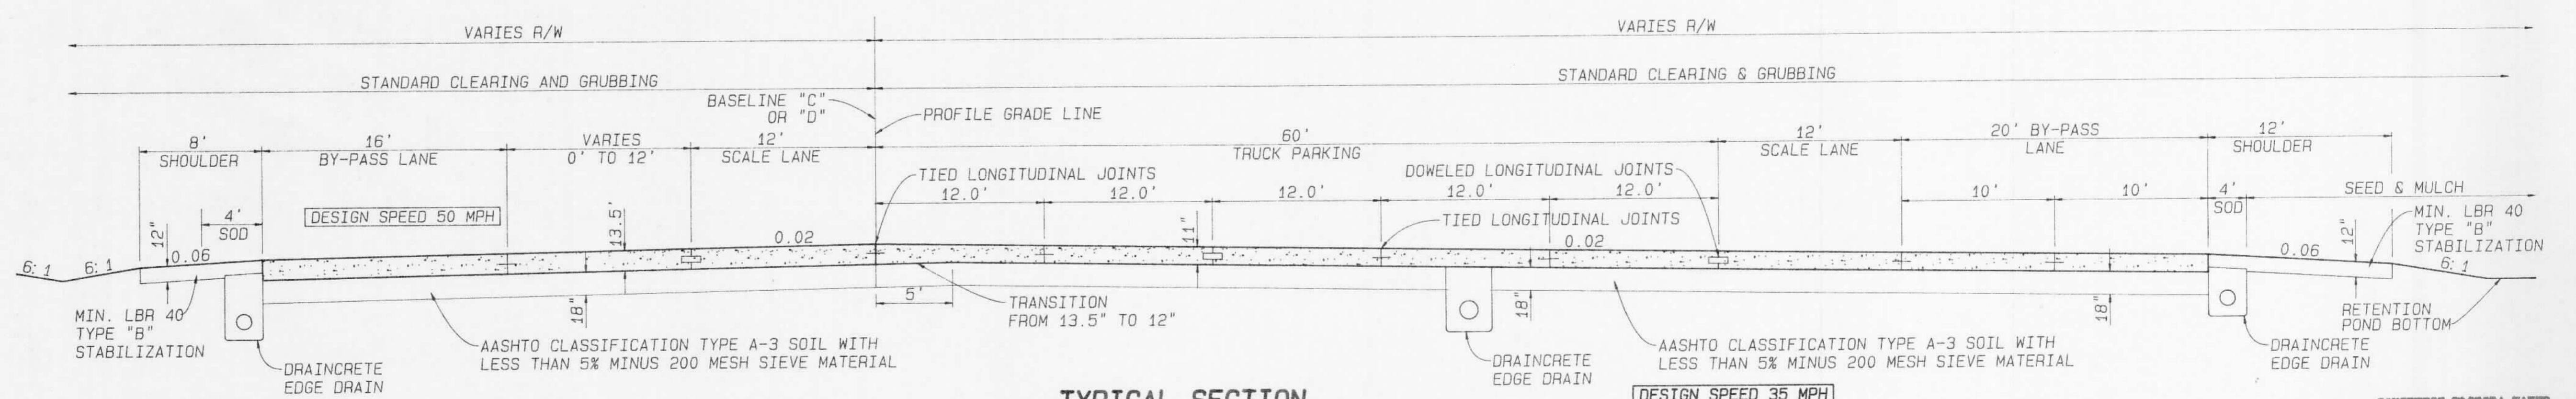

TYPICAL SECTION
 STA 113+35.00 TO 119+45.00 BASELINE "A"
 STA 146+70.00 TO 153+30.00 BASELINE "B"
DESIGN SPEED 35 MPH
 PLAIN CEMENT CONCRETE PAVEMENT (11")
 FOR JOINT LOCATIONS AND EDGE DRAIN DETAILS SEE SHEET
 FOR ADDITIONAL DETAILS SEE INDEX NOS. 105, 281, 305, 500, & 505

SOUTHWEST FLORIDA WATER MANAGEMENT DISTRICT PERMITTED CONSTRUCTION

PERMITTEE SHALL NOTIFY IN WRITING THE VENICE PERMITTING DEPARTMENT, SOUTHWEST FLORIDA WATER MANAGEMENT DISTRICT, WHEN CONSTRUCTION BEGINS.

FILE OF RECORD PERMIT NO. 409592.00

Imaged As Is

REVISIONS			
DATE	BY	DESCRIPTION	


TYP-2	NAME	DATE	NAME	DATE
DESIGNED BY	L. CLEGG	9-91	DRAWN BY	S. WEBSTER
CHECKED BY	W.F. BIGGS	9-91	CHECKED BY	L. CLEGG
SUPERVISED BY WILLIAM F. BIGGS, P.E.				

FLORIDA DEPARTMENT OF TRANSPORTATION
 APPROVED BY *Will [Signature]* DATE 10/17

Bouje Engineering Corporation of Florida
 5910-A Greentree Parkway, Tampa, FL 33610-4251 813/921-7300

TYPICAL SECTION
I-75


<JUMBLE-TASKCH-BIGGS-WEIGH-PUNTA>S-TYP-2 SPOOLED BY WEBSTER ON 26 SEP 1991 AT 15:32:12

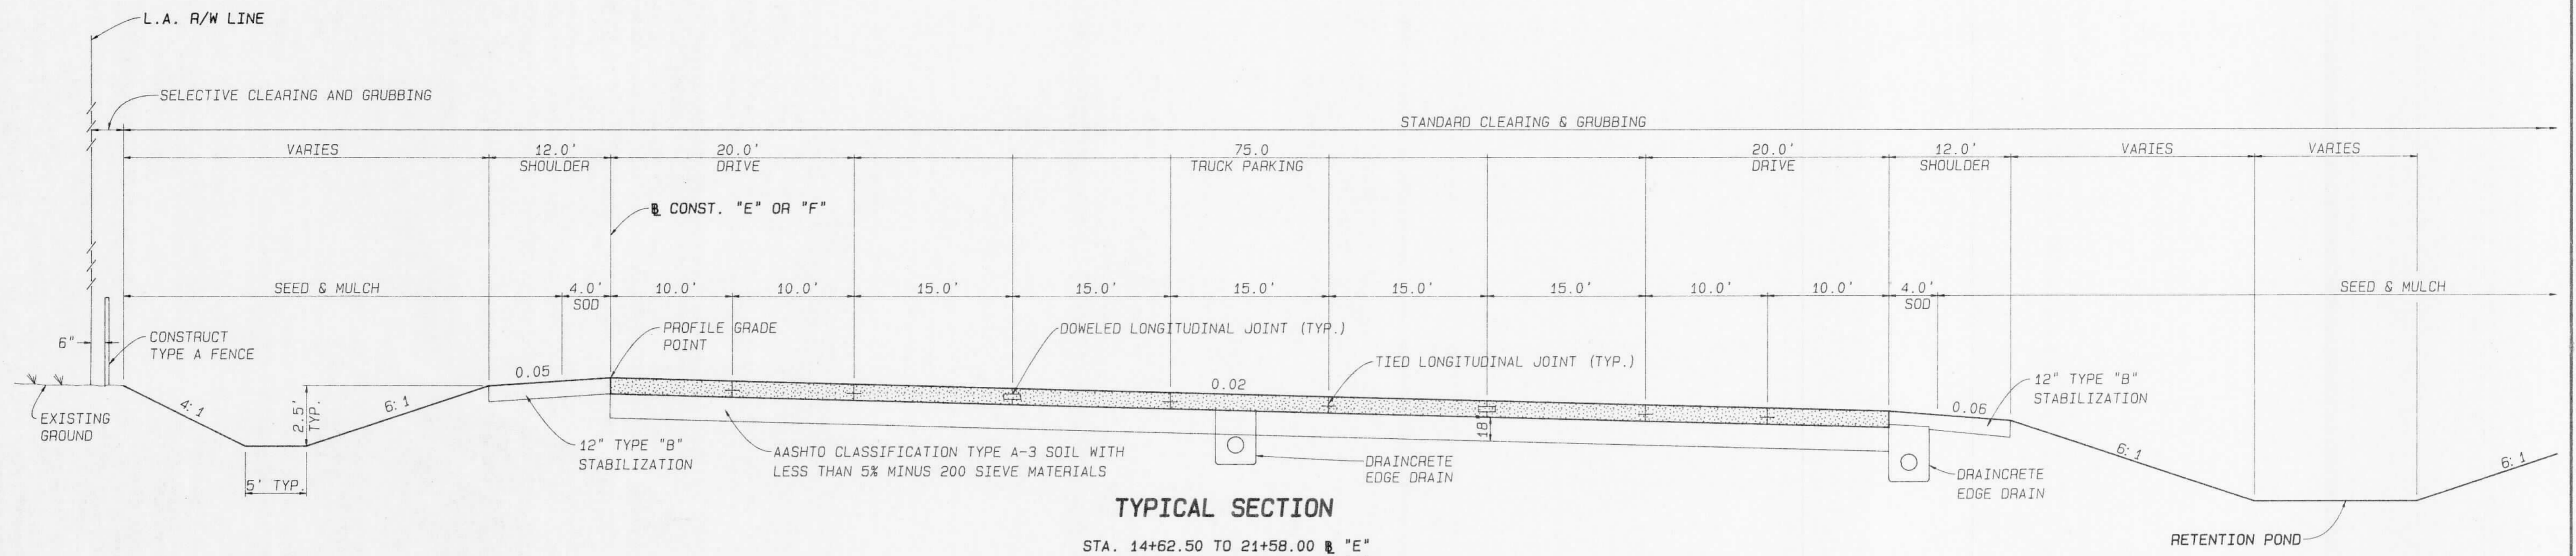

TYPICAL SECTION

STA. 14+62.50 TO 21+58.00 BASELINE "E"
 STA. 14+62.50 TO 21+58.00 BASELINE "F"
 PLAIN CEMENT CONCRETE PAVEMENT (11")
 FOR JOINT LOCATIONS AND EDGE DRAIN DETAILS SEE SHEET
 FOR ADDITIONAL DETAILS SEE INDEX NOS. 105, 281, 305, 500, & 505

DESIGN SPEED 25 MPH

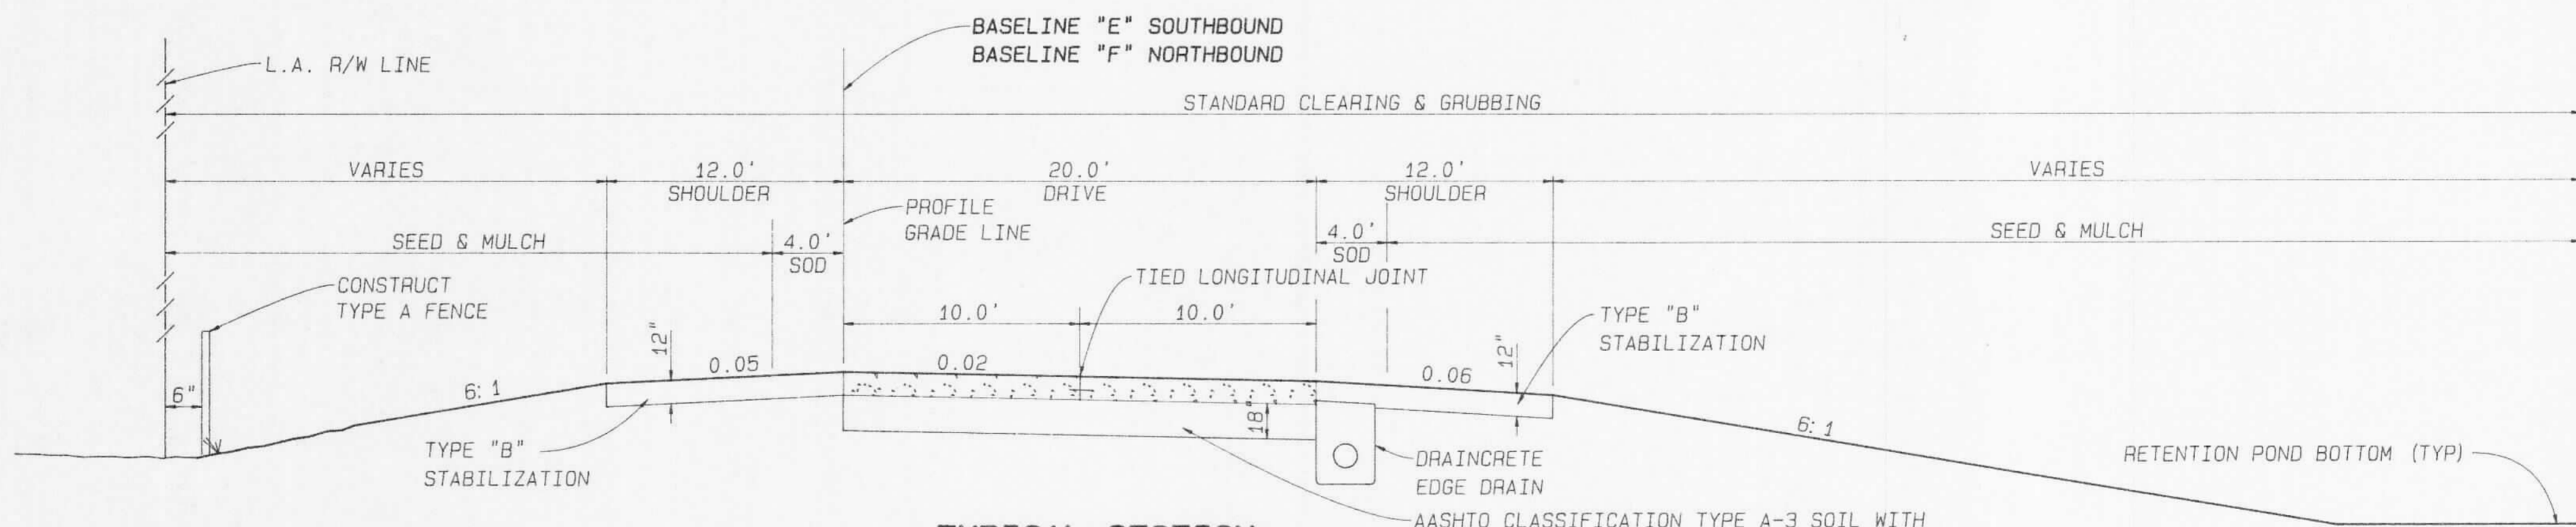

TYPICAL SECTION

REAR PARKING AREA

STA 11+93.00 TO 14+62.50 BASELINE "E"
 STA 21+58.00 TO 30+40.00 BASELINE "E"
 STA 11+93.00 TO 14+62.50 BASELINE "F"
 STA 21+58.00 TO 30+40.00 BASELINE "F"

DESIGN SPEED 25 MPH

PLAIN CEMENT CONCRETE PAVEMENT (11")
 FOR JOINT LOCATIONS AND EDGE DRAIN DETAILS SEE SHEET
 FOR ADDITIONAL DETAILS SEE INDEX NOS. 105, 281, 305, 500, & 505

SOUTHWEST FLORIDA WATER
 MANAGEMENT DISTRICT
 PERMITTED CONSTRUCTION
 DRAWING

PERMITTEE SHALL NOTIFY IN WRITING
 THE VENICE PERMITTING DEPARTMENT,
 SOUTHWEST FLORIDA WATER MANAGEMENT
 DISTRICT, WHEN CONSTRUCTION BEGINS.

FILE OF RECORD
 PERMIT NO. 409592-00

Imaged As Is

REVISIONS							
DATE	BY	DESCRIPTION	DATE	BY	DESCRIPTION	DATE	BY



DESIGNED BY	L. CLEGG	DATE	9-91	DRAWN BY	S. WEBSTER	DATE	9-91
CHECKED BY	W. F. BIGGS	DATE	9-91	CHECKED BY	L. CLEGG	DATE	9-91
SUPERVISED BY	WILLIAM F. BIGGS, P.E.						

FLORIDA DEPARTMENT OF TRANSPORTATION
 APPROVED BY
 Will [Signature] DATE 12/6/91

Boyle Engineering Corporation
 of Florida
 5512-A Brackenridge Parkway, Tampa, FL 33610-4251 813/921-7900

TYPICAL SECTION
 I-75

C:\JUMBLE-TASKS\W.F.BIGGS-WFH\TYP-3.S. TYP-3 SPOOLED BY WEBSTER ON 26 SEP 1991 AT 15:37:32

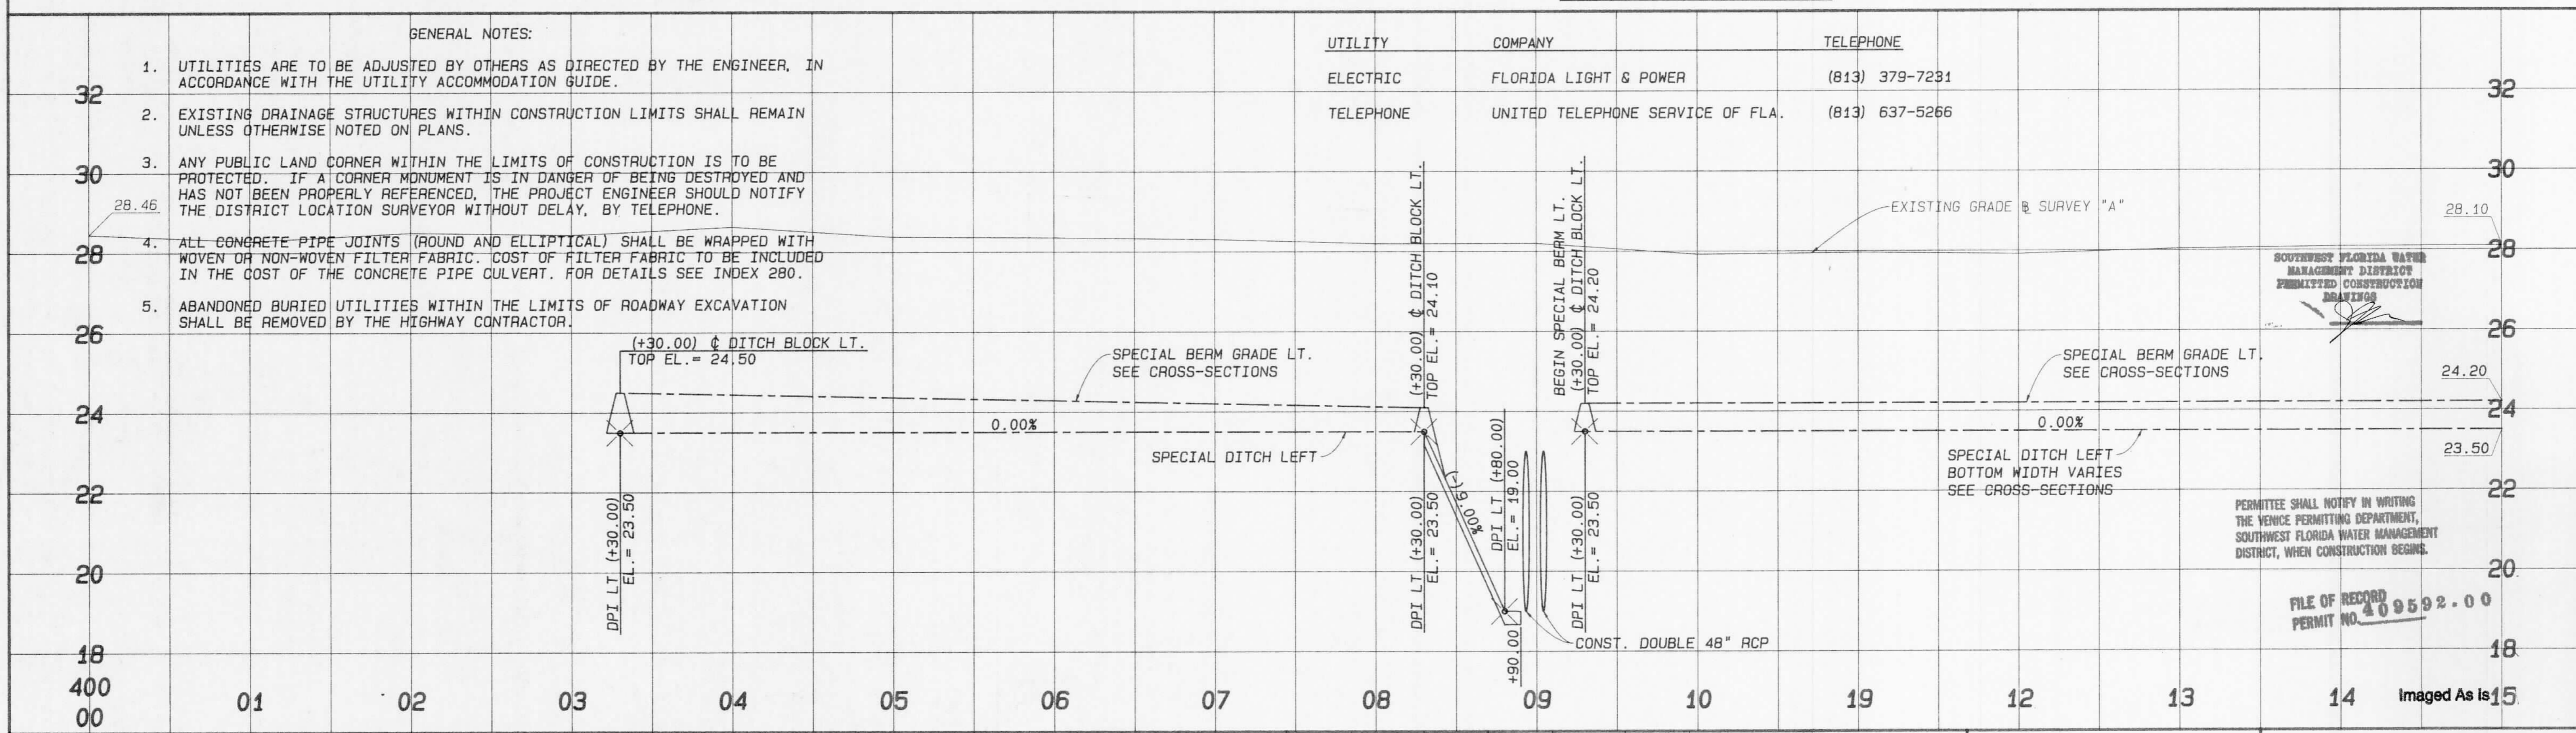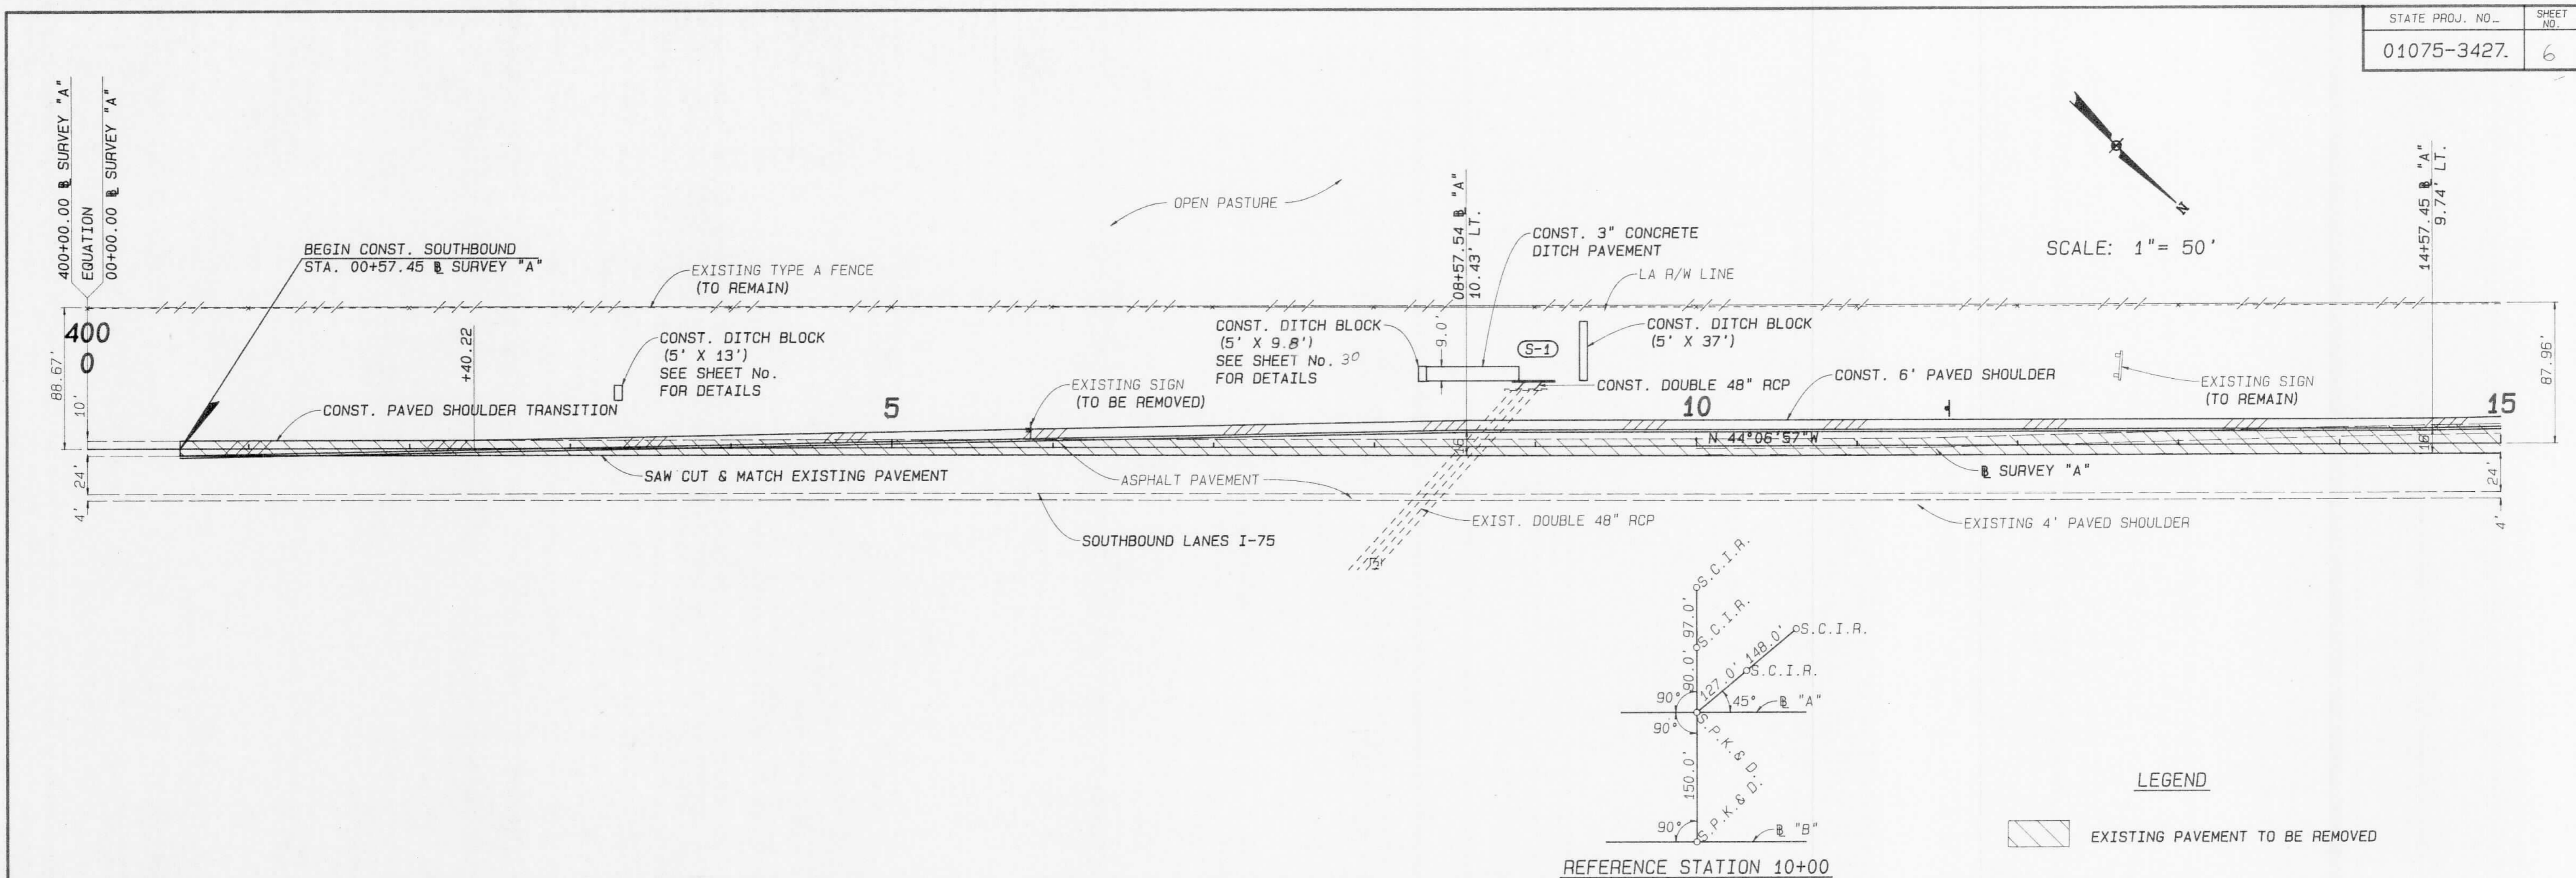

REVISIONS							
DATE	BY	DESCRIPTION	DATE	BY	DESCRIPTION	DATE	BY

SB1	NAME	DATE	NAME	DATE
DESIGNED BY	L. CLEGG	8-91	DRAWN BY	S. WEBSTER
CHECKED BY	W.F. BIGGS	8-91	CHECKED BY	L. CLEGG

FLORIDA DEPARTMENT OF TRANSPORTATION
 APPROVED BY: [Signature]
 DATE: 12/6/91

Boyle Engineering Corporation
 5912-A Breckenridge Parkway, Tampa, FL 33610-4251 813/821-7900

PLAN AND PROFILE
 SOUTHBOUND I-75



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LEGEND



EXISTING PAVEMENT TO BE REMOVED

SCALE: 1" = 50'

BORROW PIT
PRESENT WATER EL. = 19.78
(5-14-90)

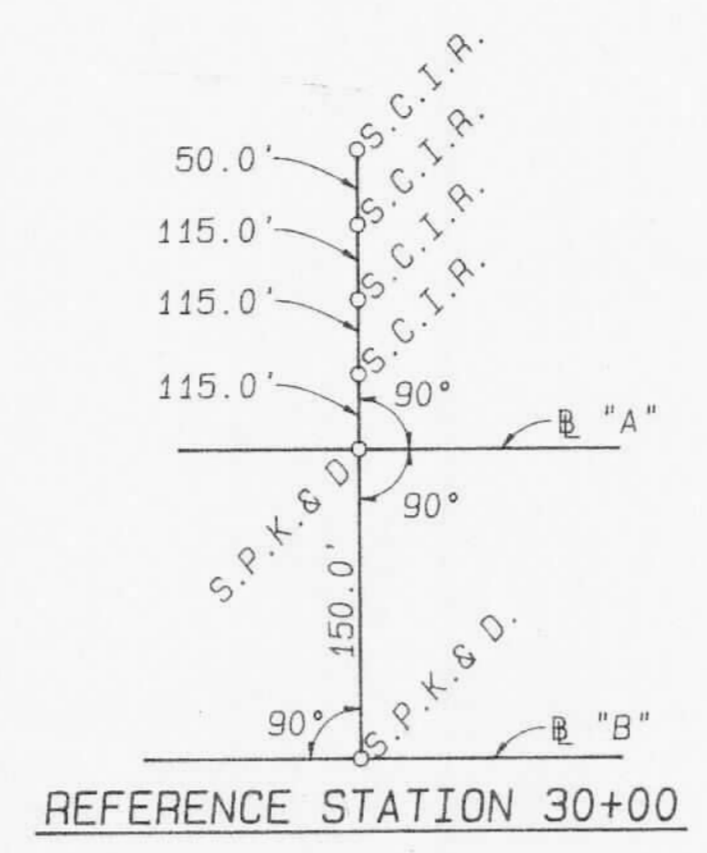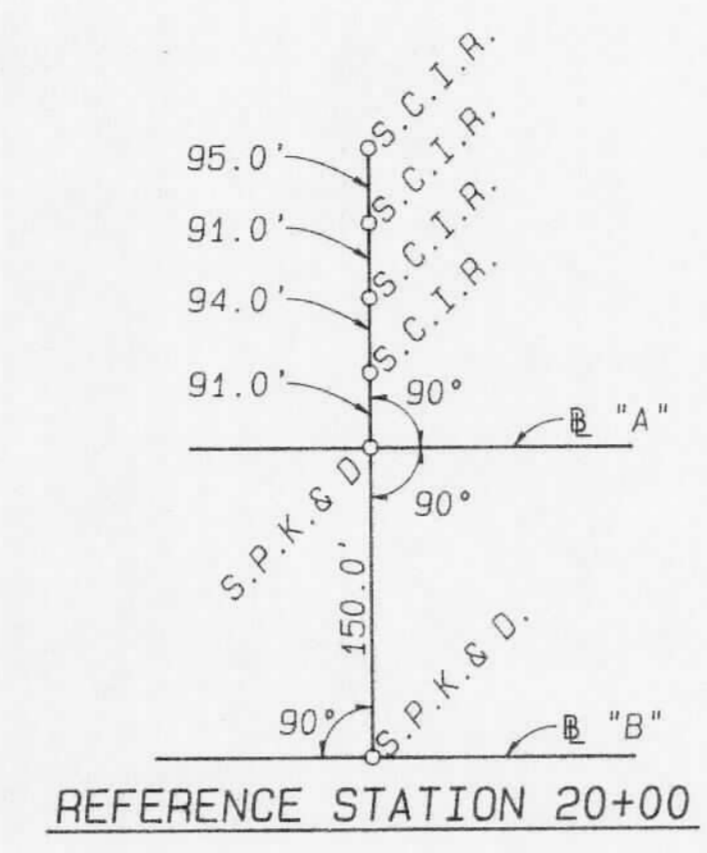

CONST. "C"
PI STA. 112+00.76
Δ = 06°01'02"
D = 01°30'00"
T = 200.76'
L = 401.15'
R = 3819.72'
e = 0.032%
PC STA. 110+00.00
PT STA. 114+01.15

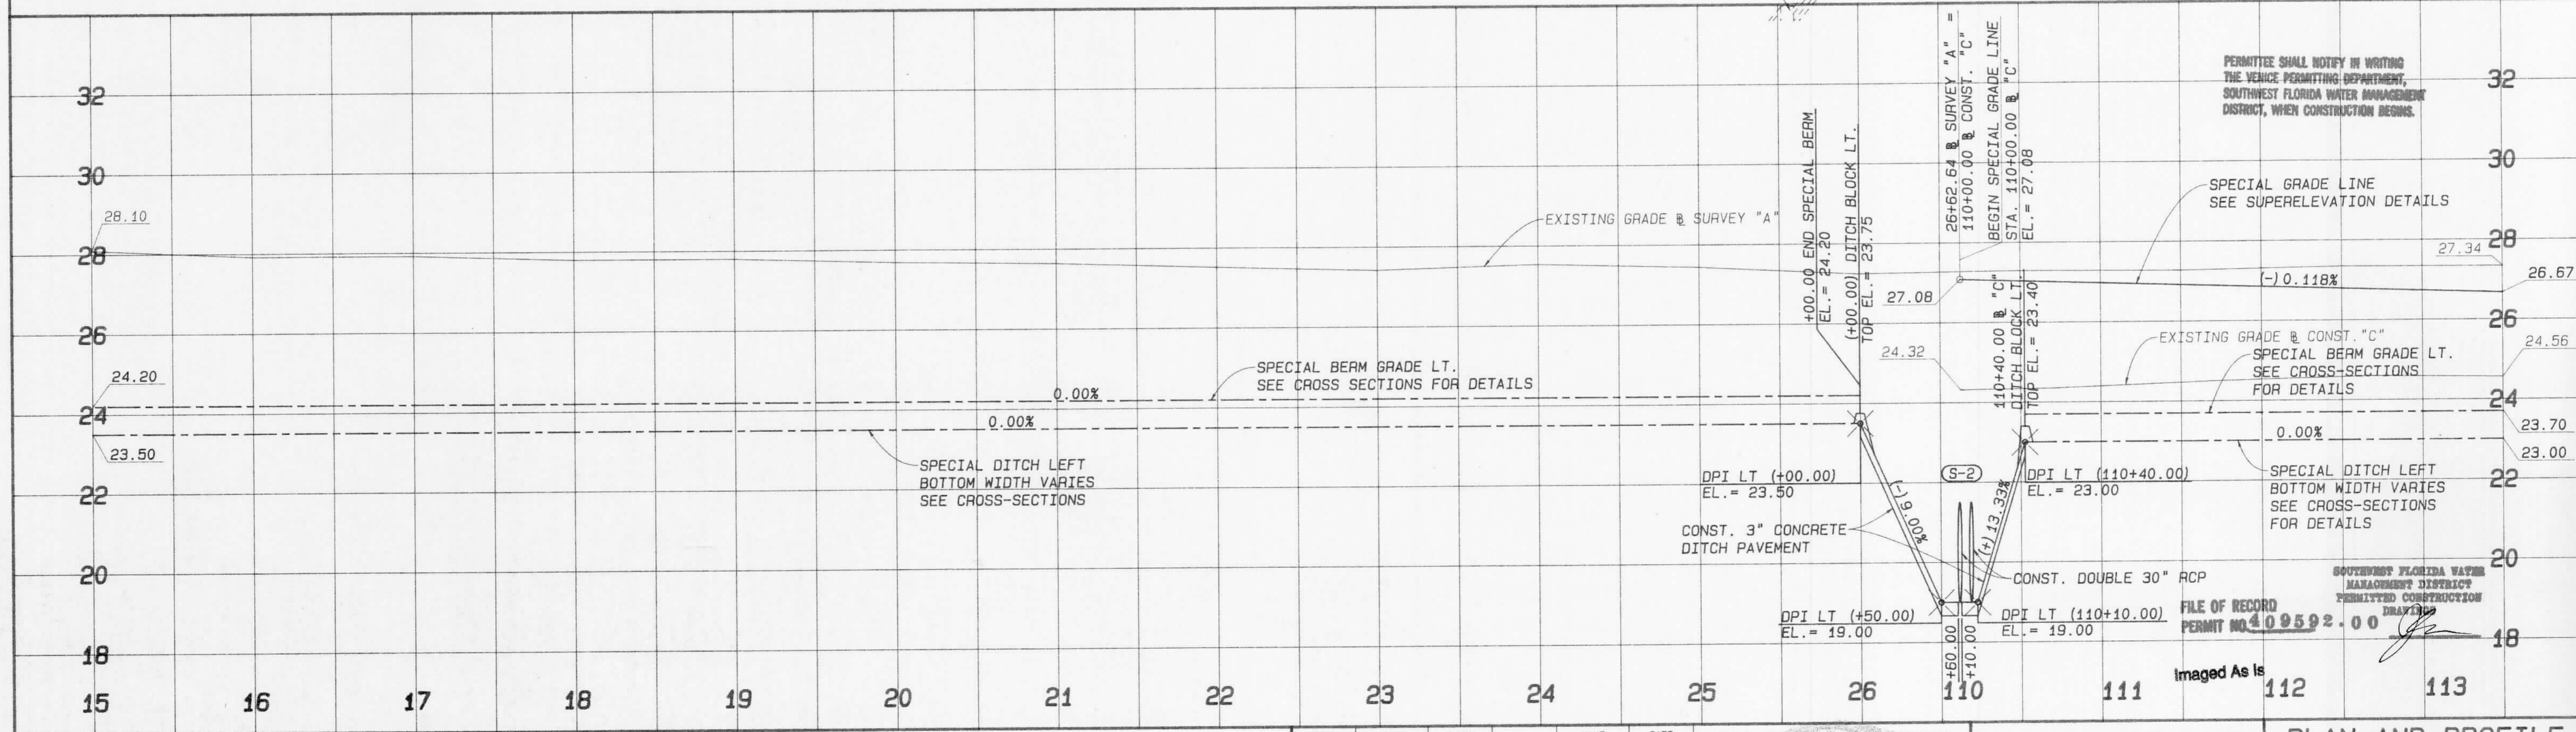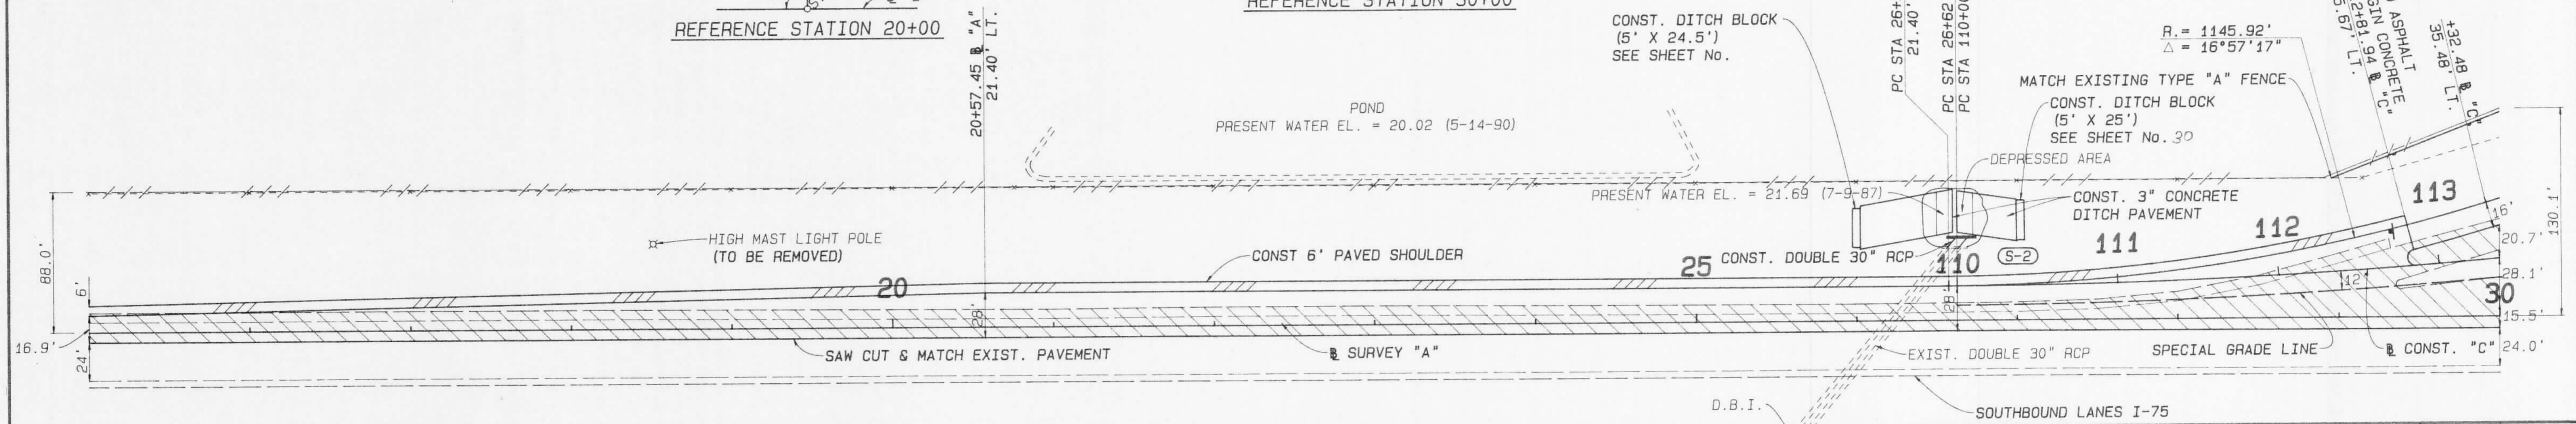

REVISIONS							
DATE	BY	DESCRIPTION	DATE	BY	DESCRIPTION	DATE	BY

SB2	NAME	DATE	NAME	DATE
DESIGNED BY	L. CLEGG	9-91	DRAWN BY	S. WEBSTER
CHECKED BY	W.F. BIGGS	9-91	CHECKED BY	L. CLEGG
SUPERVISED BY	WILLIAM F. BIGGS, P.E.			



FLORIDA DEPARTMENT OF TRANSPORTATION
APPROVED BY:
DATE: 12/16/91

Baile Engineering Corporation
of Florida
15512-A Breckenridge Parkway, Tampa, FL 33610-4251 813/921-7900

PLAN AND PROFILE
SOUTHBOUND I-75

FILE OF RECORD
PERMIT NO. 409592-00

C:\JUMBLE\TASK\M.BIGGS\WEIGH\PUNTA\S_SB2_SPOOLED BY COE ON 86 NOV 1991 AT 09:34:45

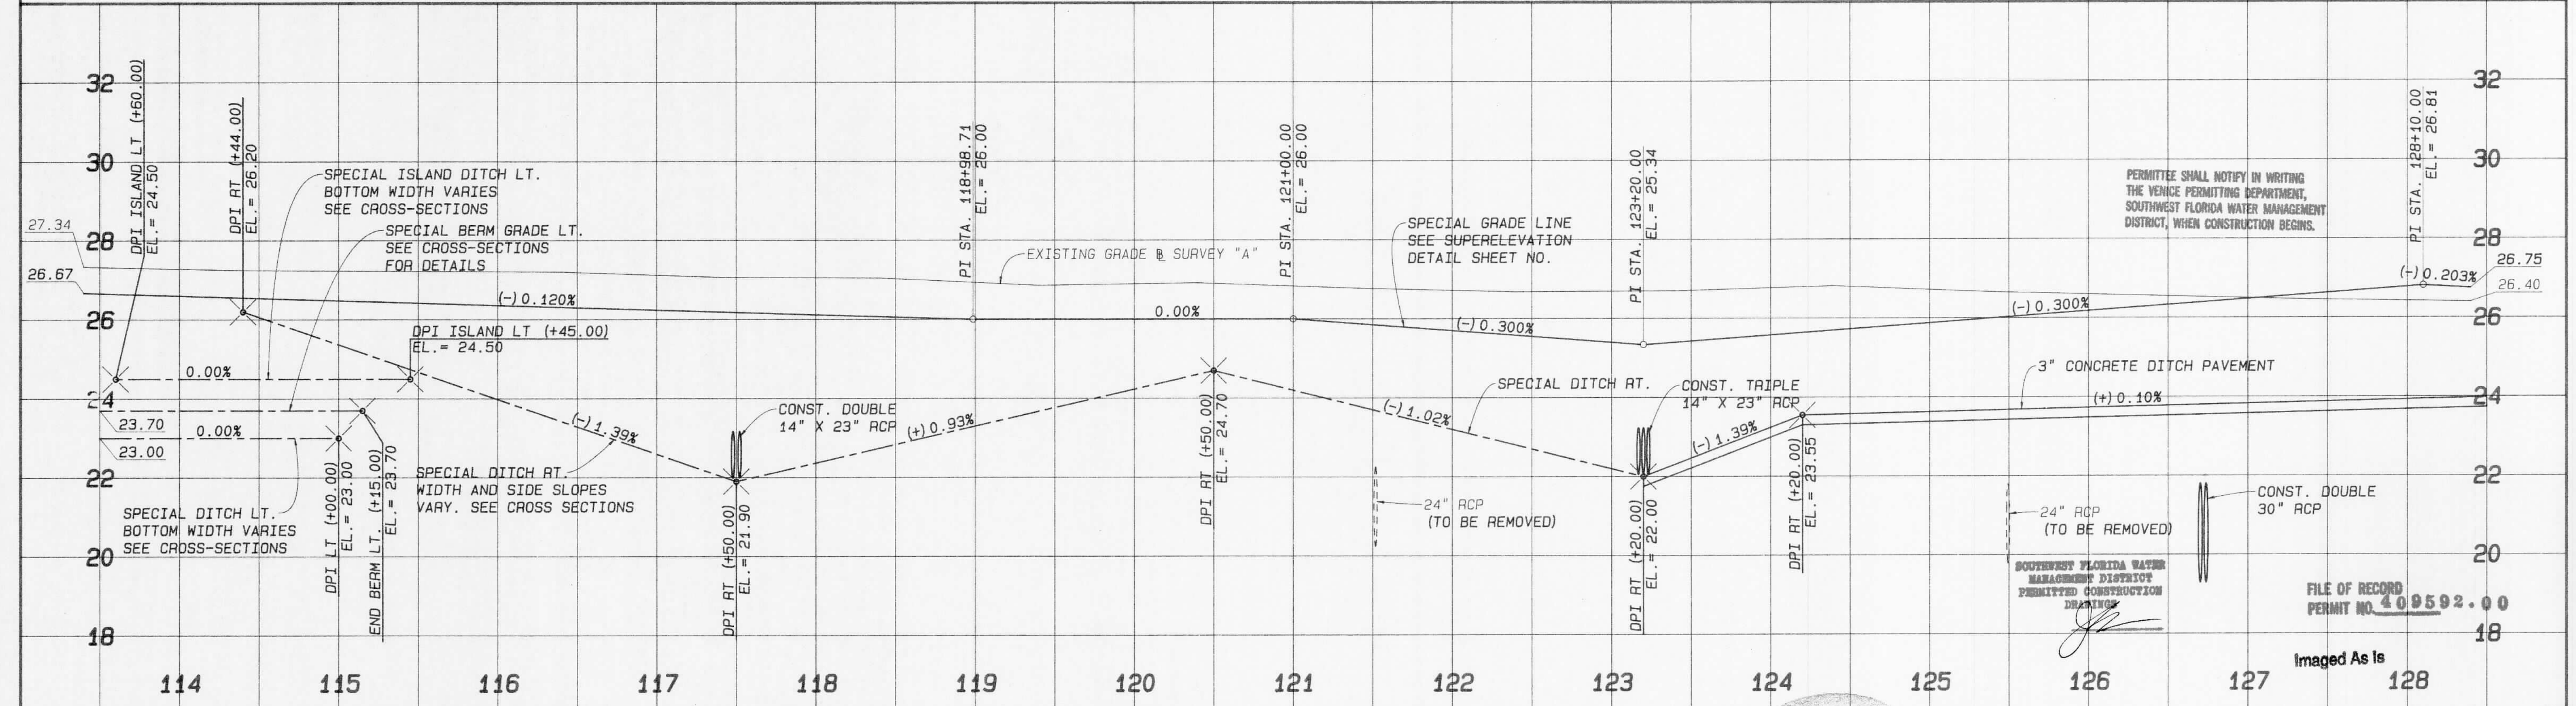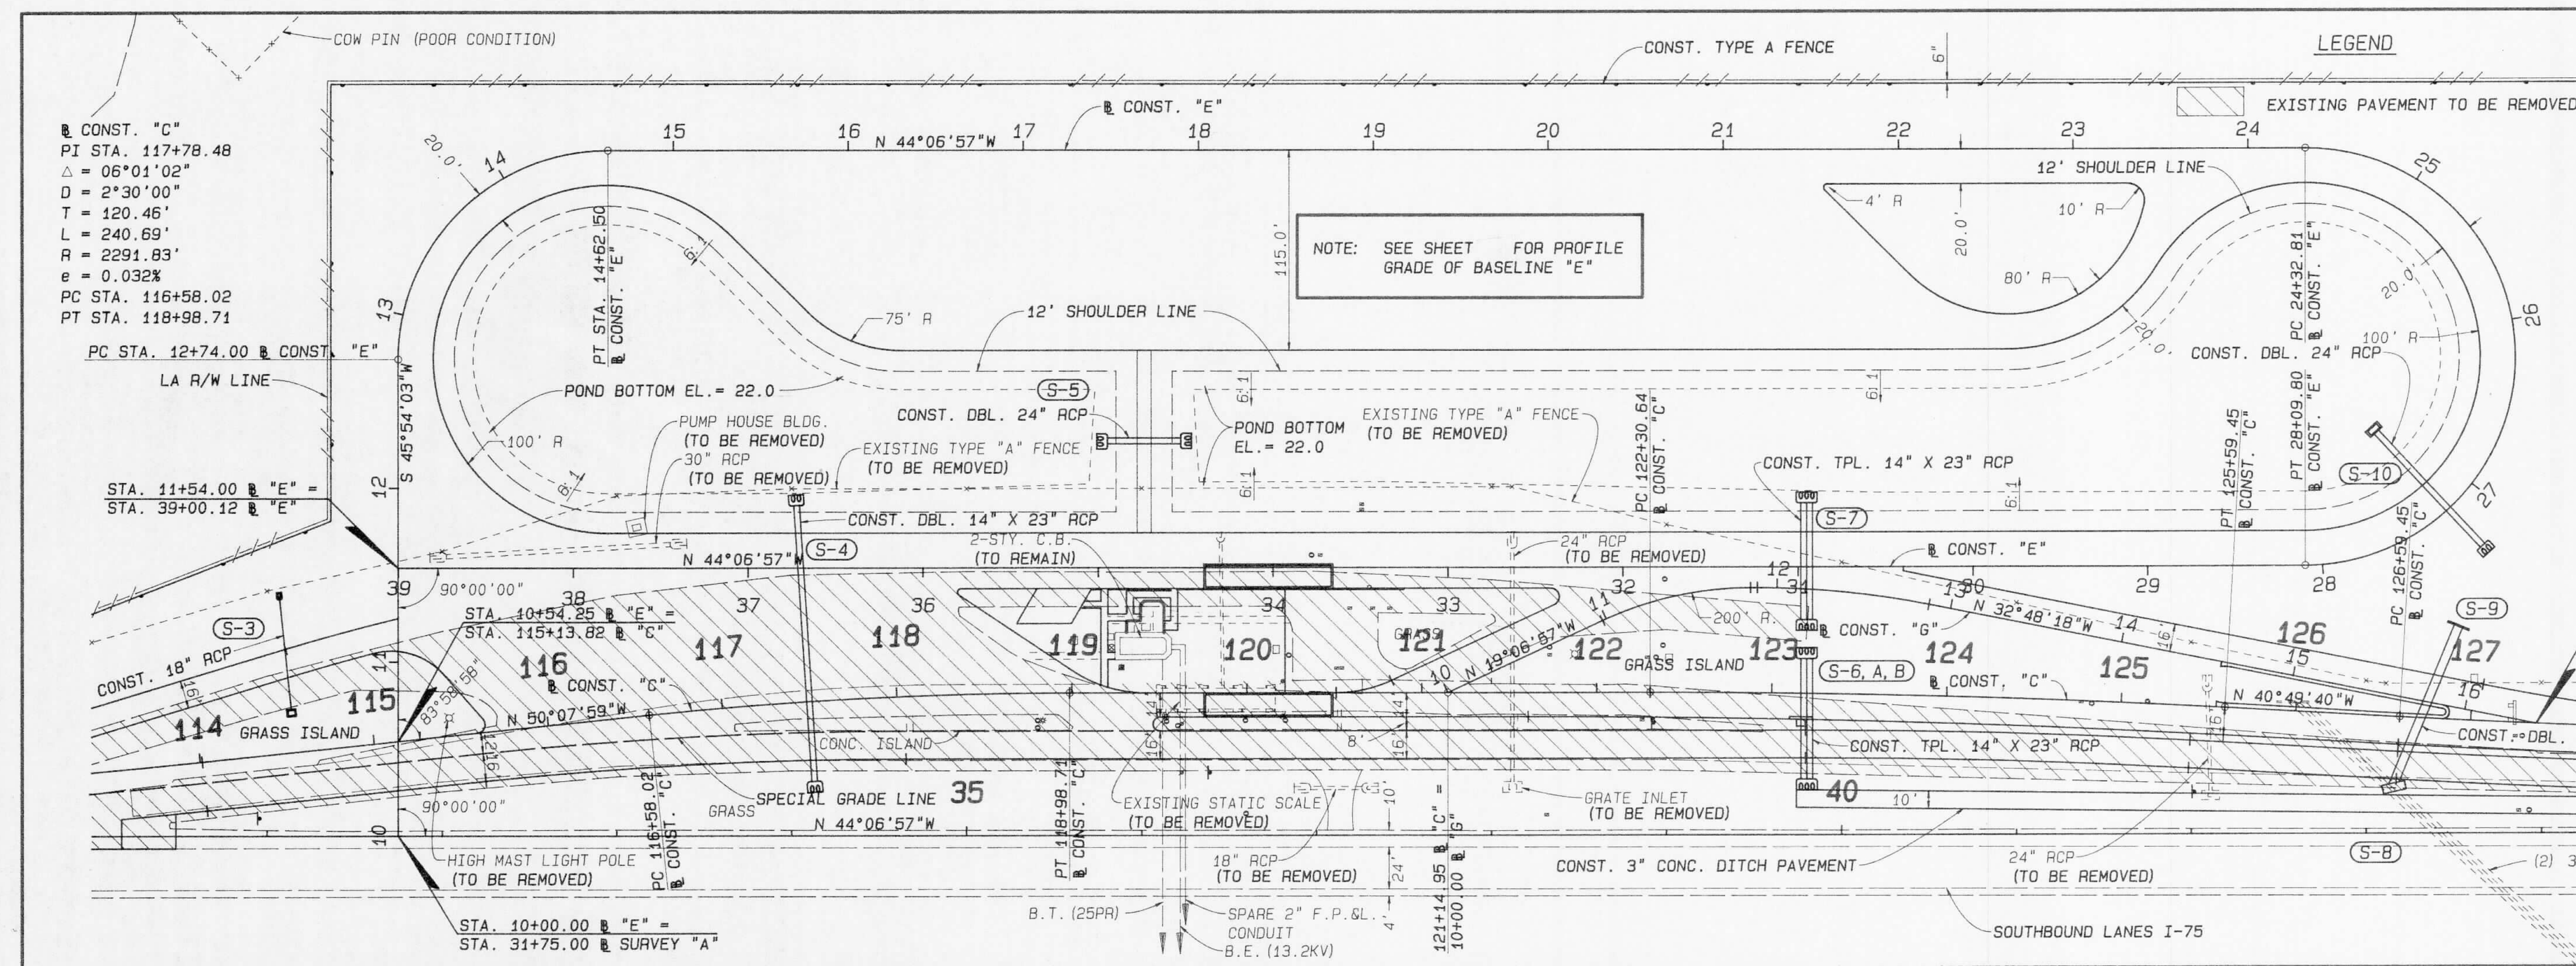

REVISIONS							
DATE	BY	DESCRIPTION	DATE	BY	DESCRIPTION	DATE	BY



SB3	NAME	DATE	NAME	DATE
DESIGNED BY	L. CLEGG	8-91	DRAWN BY	S. WEBSTER
CHECKED BY	W.F. BIGGS	8-91	CHECKED BY	L. CLEGG
SUPERVISED BY		WILLIAM F. BIGGS, P.E.		

FLORIDA DEPARTMENT OF TRANSPORTATION
 APPROVED BY: *[Signature]*
 DATE: *[Date]*

Boyle Engineering Corporation
 of Florida
 5912-A Breckenridge Parkway, Tampa, FL 33610-4251 813/621-7800

PLAN AND PROFILE
SOUTHBOUND I-75



RECEIVED
 Southwest Florida Water Management District
 DEC 09 1991
 SCALE: 1" = 50'
 BRD - VENICE

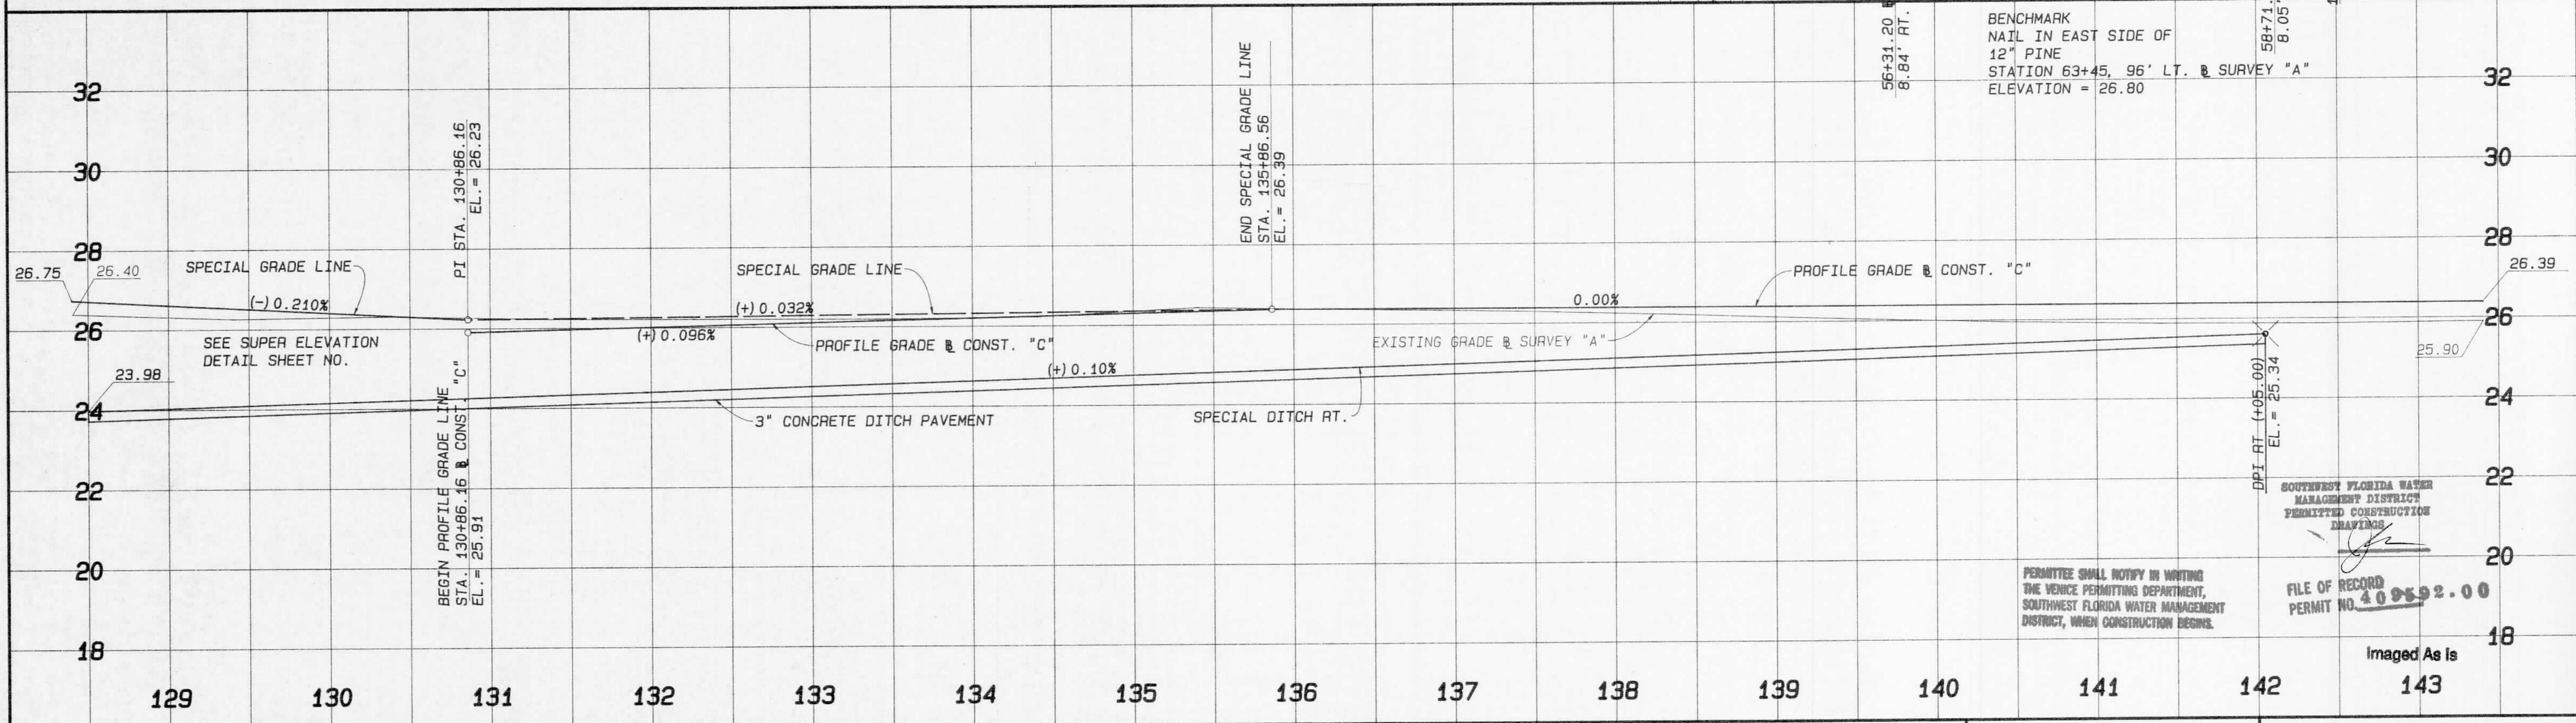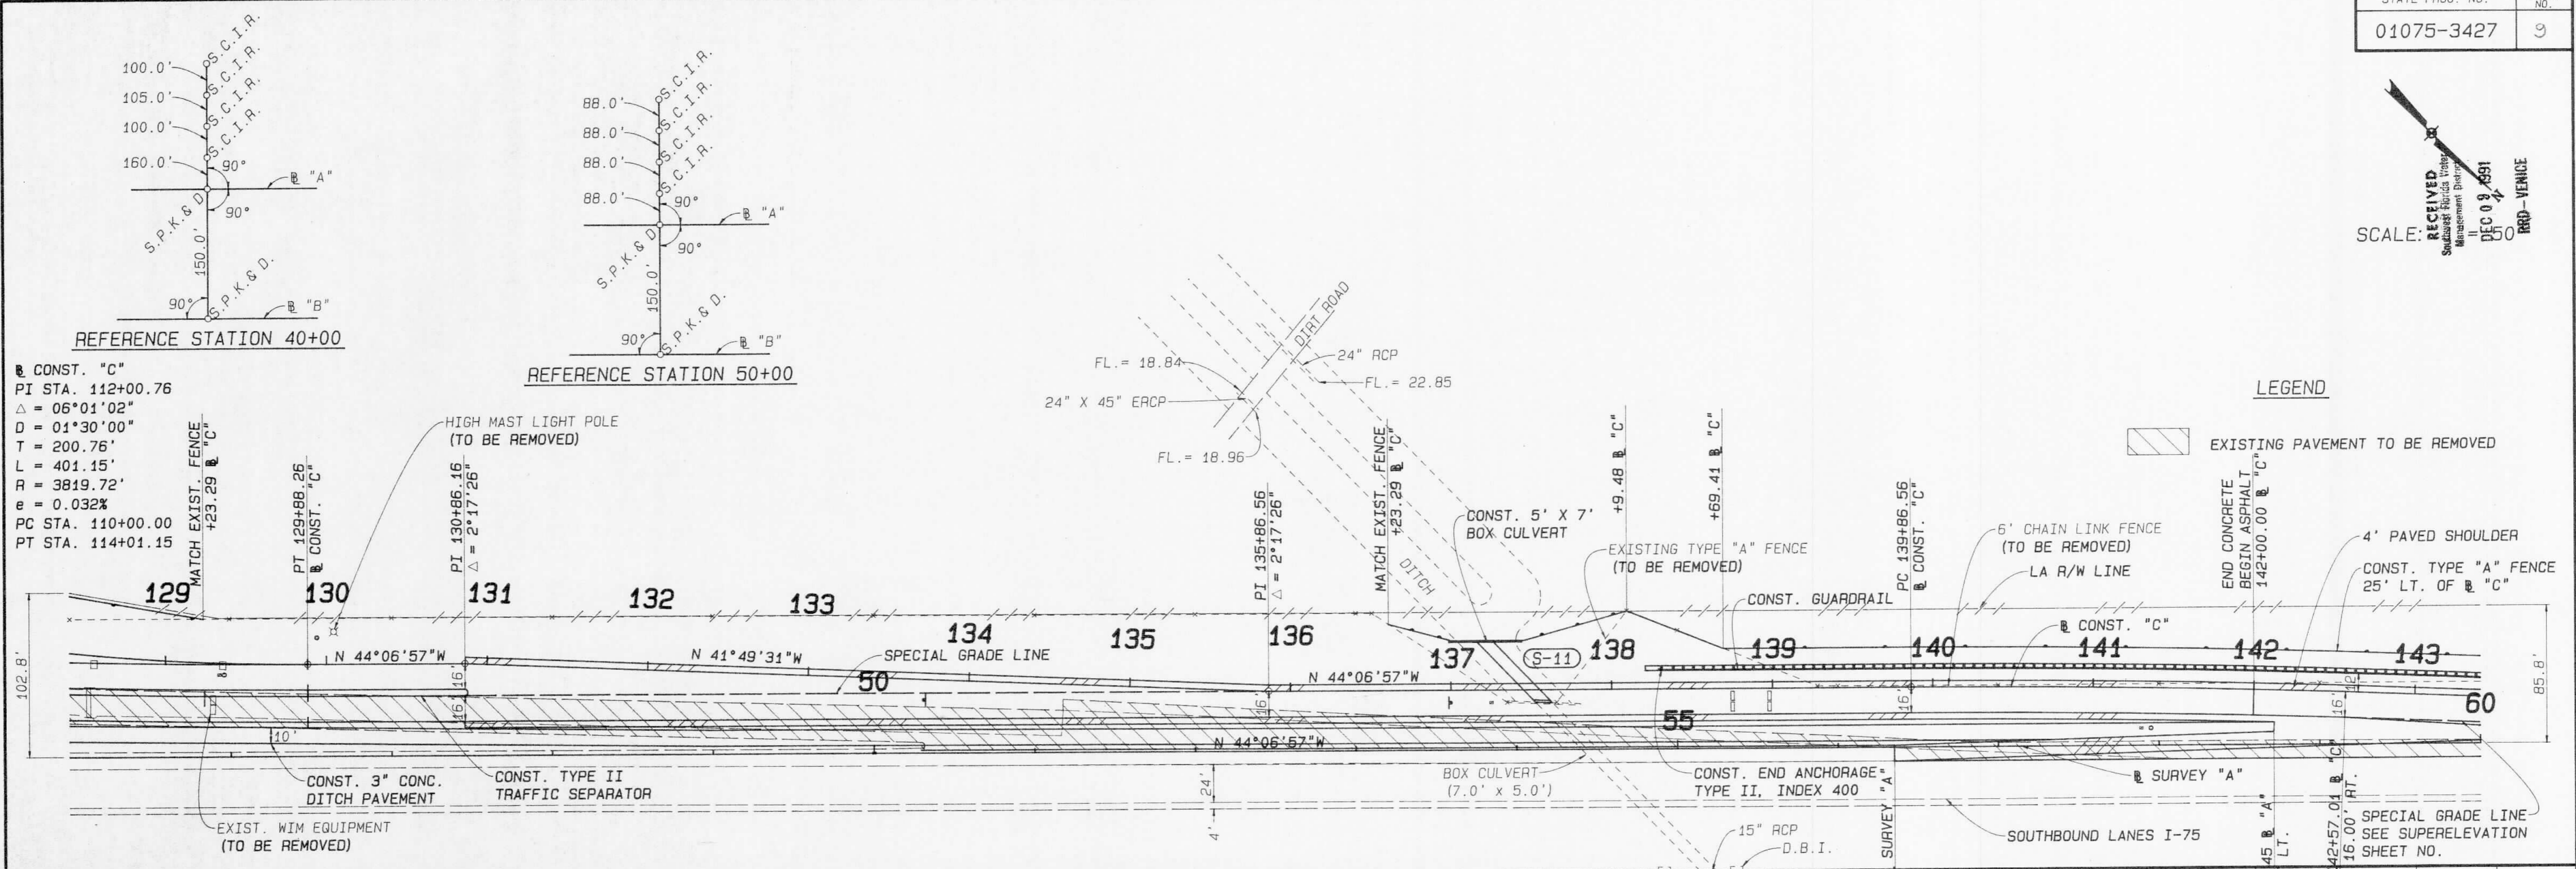

REVISIONS				SB4				FLORIDA DEPARTMENT OF TRANSPORTATION		Boyle Engineering Corporation of Florida		PLAN AND PROFILE SOUTHBOUND I-75
DATE	BY	DESCRIPTION	DATE	BY	DESCRIPTION	NAME	DATE	NAME	DATE	PERMIT NO.		
						L. CLEGG	8-91	S. WEBSTER	8-91	409592.00		
						W.F. BIGGS	8-91	L. CLEGG	8-91			
						SUPERVISED BY WILLIAM F. BIGGS, P.E.						


C:\JUNBLE\TASK\M-BIGGS\MEIGH-PUNTA\S.S.B4 SPOOLED BY WEBSTER ON 17 SEP 1991 AT 13:51:31

RECEIVED
Southwest Florida Water Management District
DES. 0 8 1991
RD - VENICE

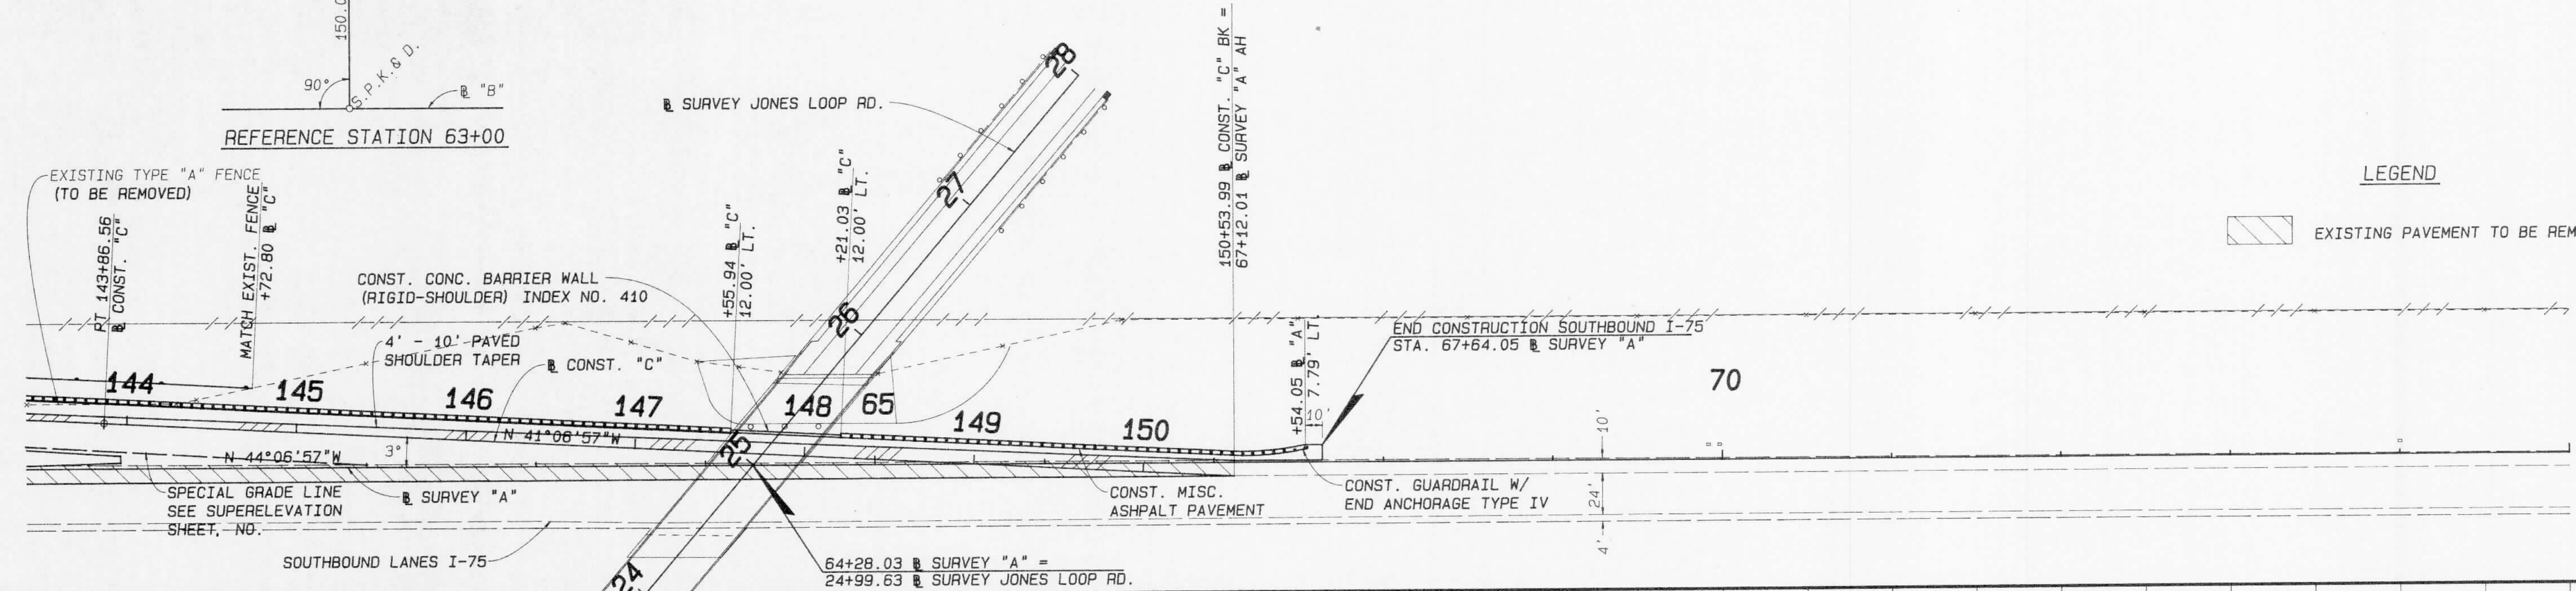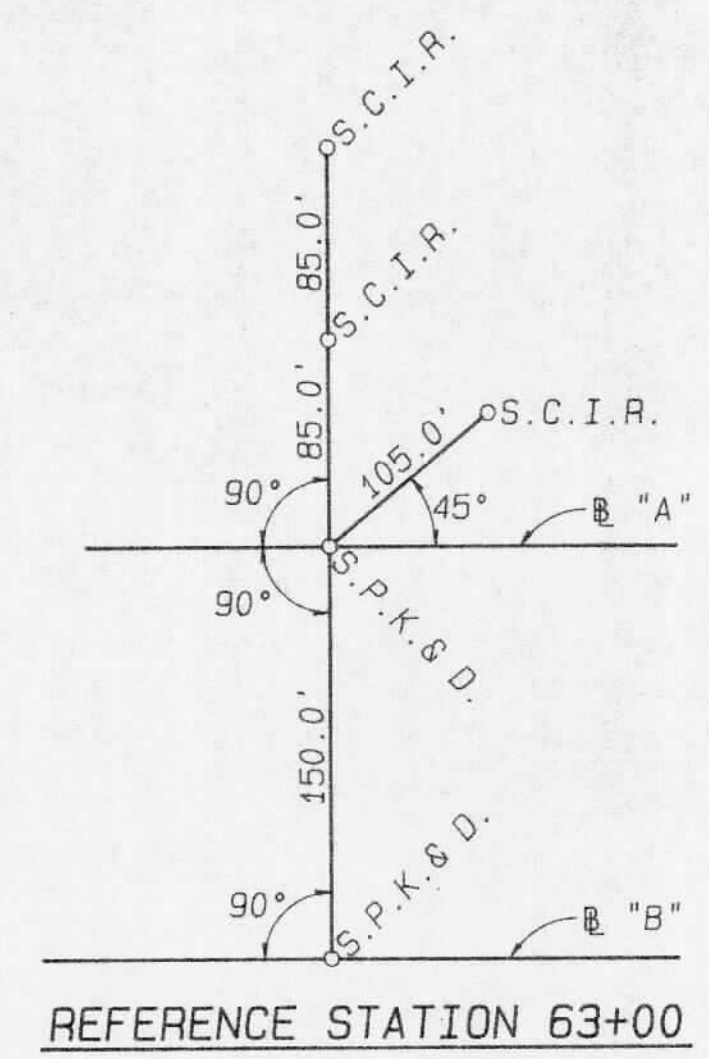

LEGEND

EXISTING PAVEMENT TO BE REMOVED

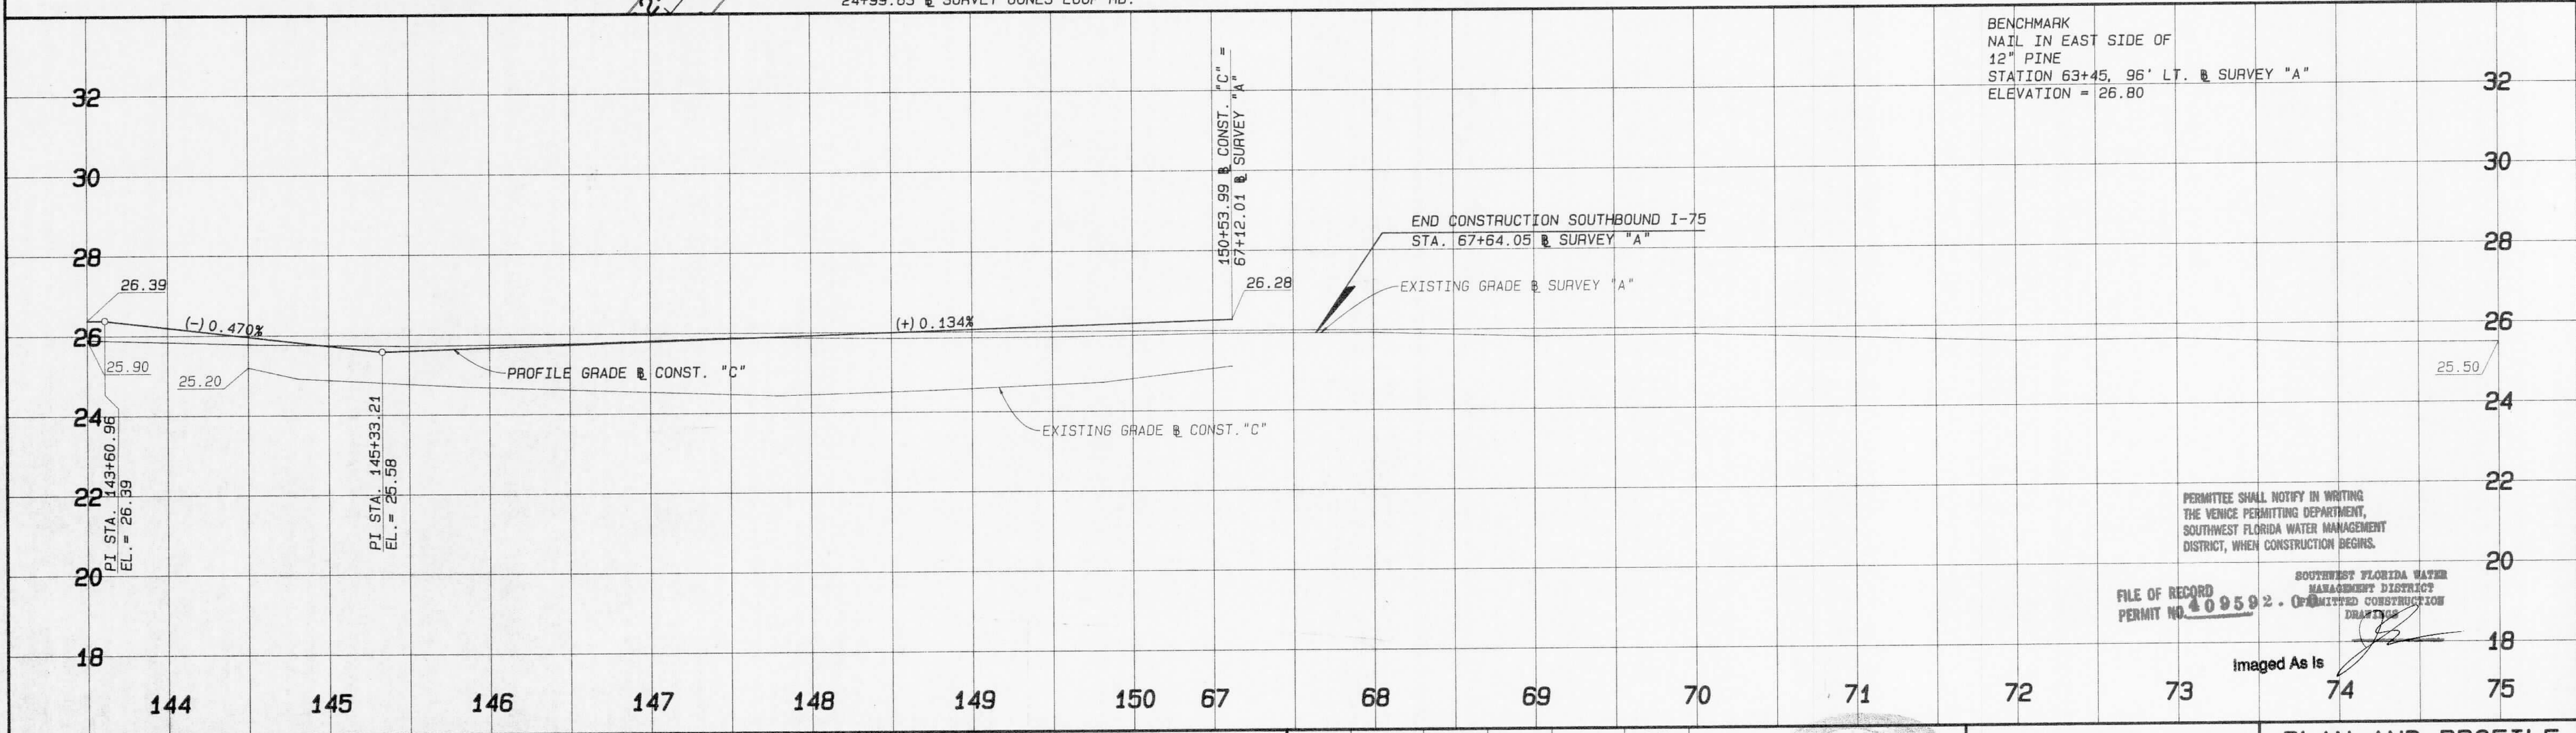

PERMITEE SHALL NOTIFY IN WRITING THE VENICE PERMITTING DEPARTMENT, SOUTHWEST FLORIDA WATER MANAGEMENT DISTRICT, WHEN CONSTRUCTION BEGINS.

SOUTHWEST FLORIDA WATER MANAGEMENT DISTRICT

FILE OF RECORD PERMIT NO. 409592 - LIMITED CONSTRUCTION DRAFTER

Imaged As Is

REVISIONS							
DATE	BY	DESCRIPTION	DATE	BY	DESCRIPTION	DATE	BY

SB5	NAME	DATE	NAME	DATE
DESIGNED BY	L. CLEGG	9-91	DRAWN BY	S. WEBSTER
CHECKED BY	W.F. BIGGS	9-91	CHECKED BY	L. CLEGG
SUPERVISED BY	WILLIAM F. BIGGS, P.E.			

FLORIDA DEPARTMENT OF TRANSPORTATION



Boyle Engineering Corporation of Florida

5810-A Greencastle Parkway, Tampa, FL 33610-4251 813/621-7900

PLAN AND PROFILE SOUTHBOUND I-75

C:\JUMBLE\TASK\M-BIGGS\WEIGH\PUNTA\S.SBS SPOOLED ON 17 SEP 1991 AT 14:52:16

RECEIVED
 Southwest Florida Water Management District
 DEC 09 1991
 RRD-VENICE

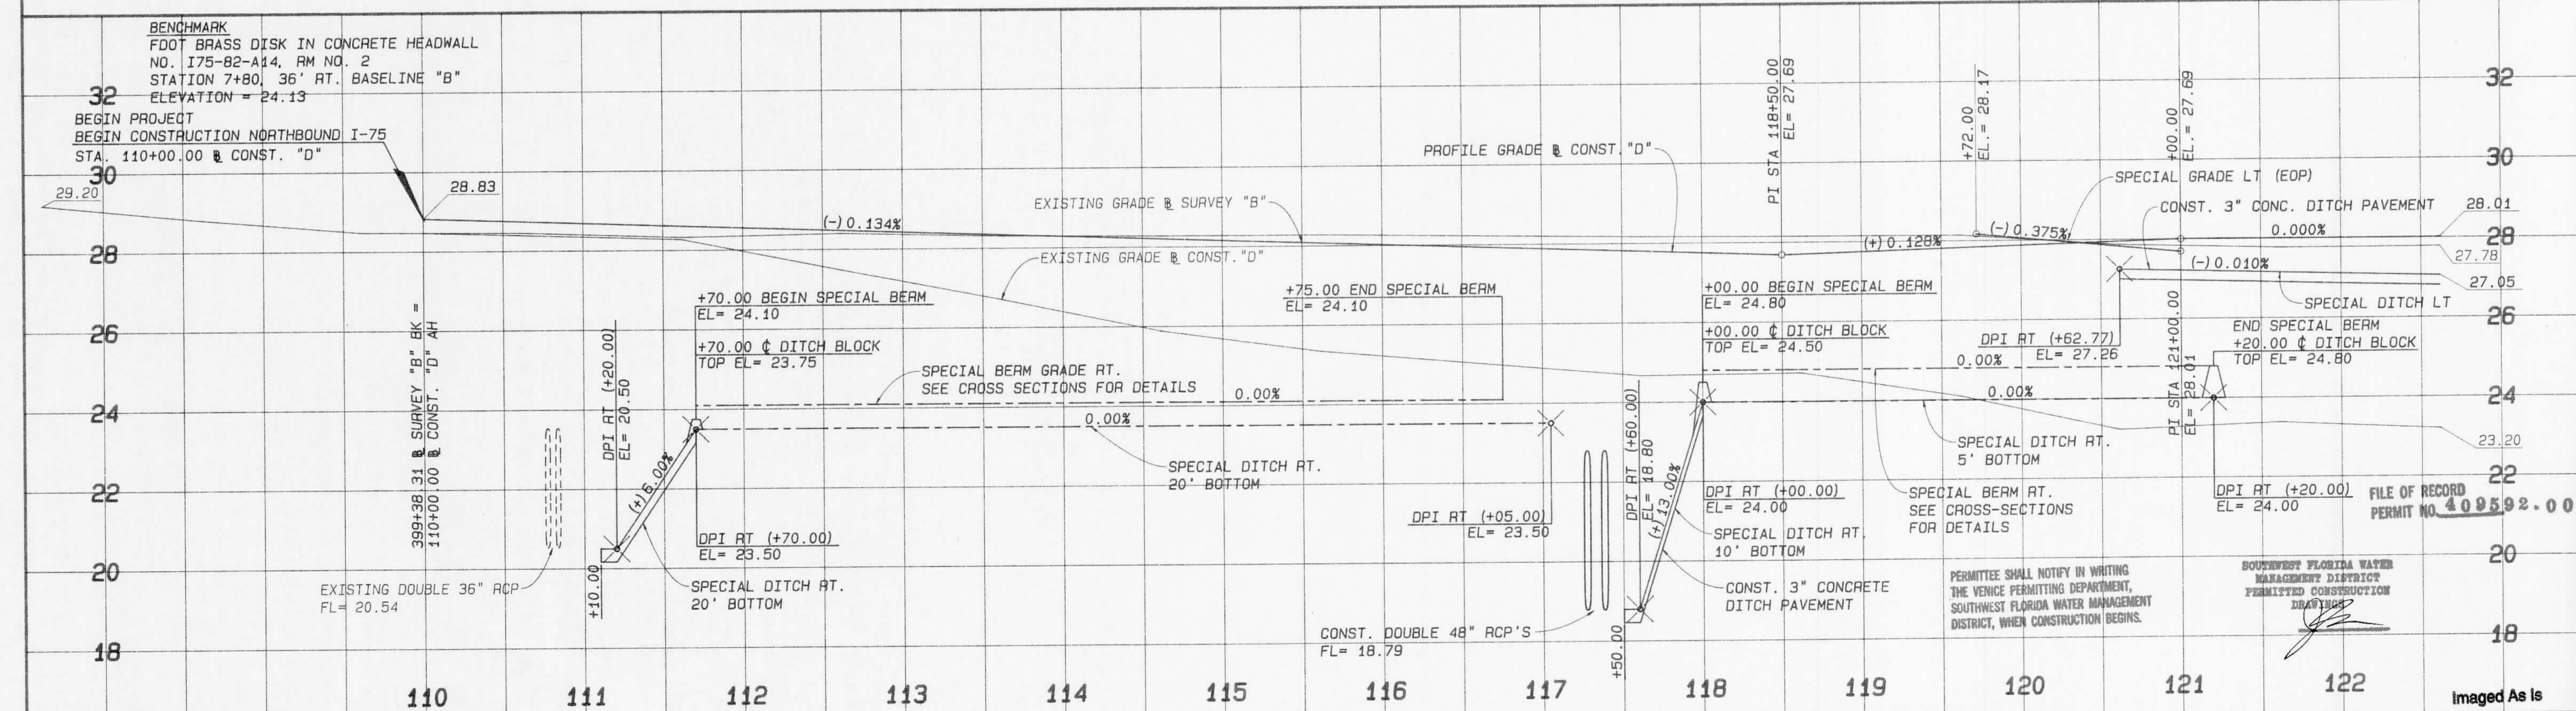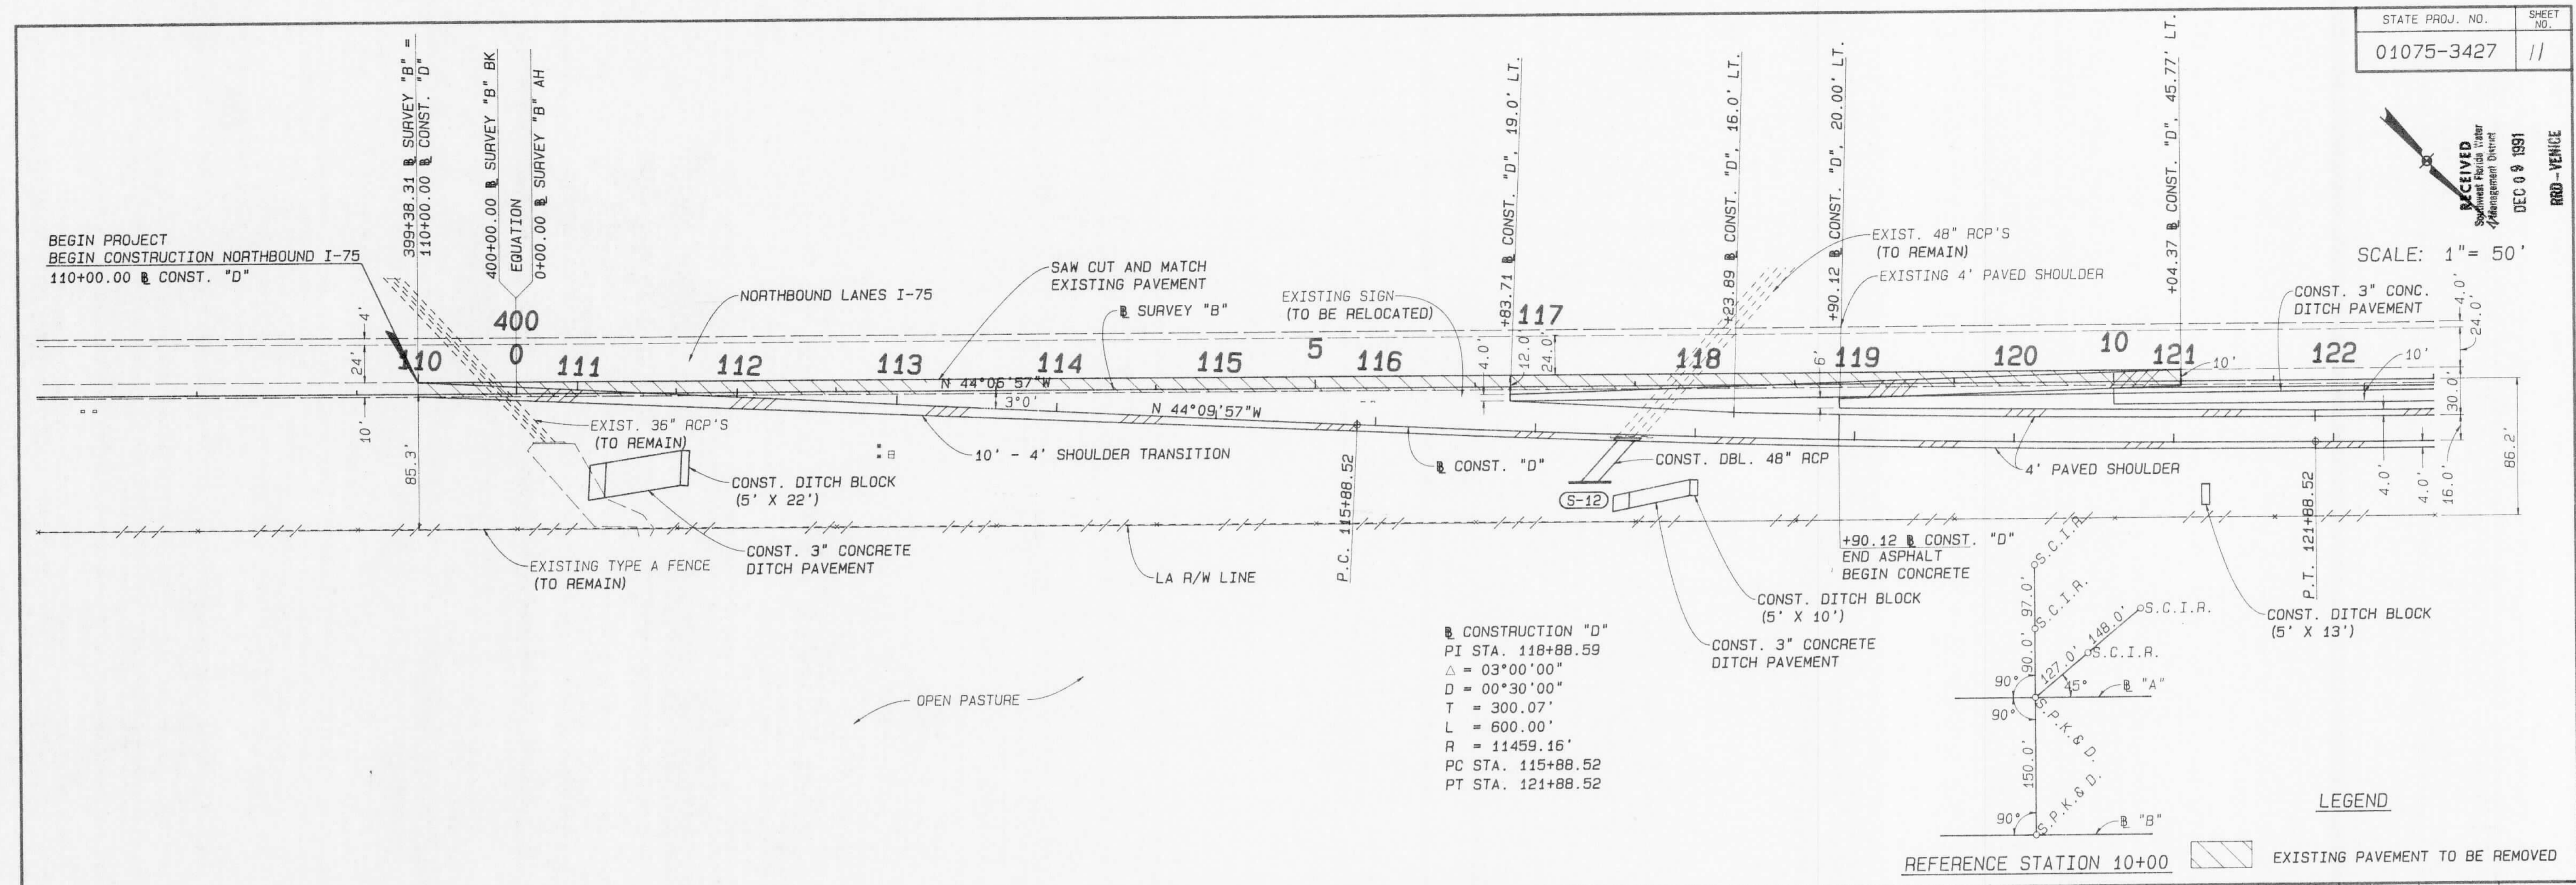



REVISIONS								DESIGNED BY		DRAWN BY		APPROVED BY		DATE	
DATE	BY	DESCRIPTION	DATE	BY	DESCRIPTION	DATE	BY	DESCRIPTION	DATE	BY	DESCRIPTION	DATE	BY	DESCRIPTION	

FLORIDA DEPARTMENT OF TRANSPORTATION
 Bojle Engineering Corporation of Florida
 PLAN AND PROFILE NORTHBOUND I-75
 409592.00

C:\JUMBLE-TASK\M.BIGGS\WEIGH\PUNTA\S.NB1 SPOOLED BY GDE ON 05 DEC 1991 AT 11:48:38

RECEIVED
Southwest Florida Water
Management District
DEC 09 1991
ROAD-VEHICLE

SCALE: 1" = 50'

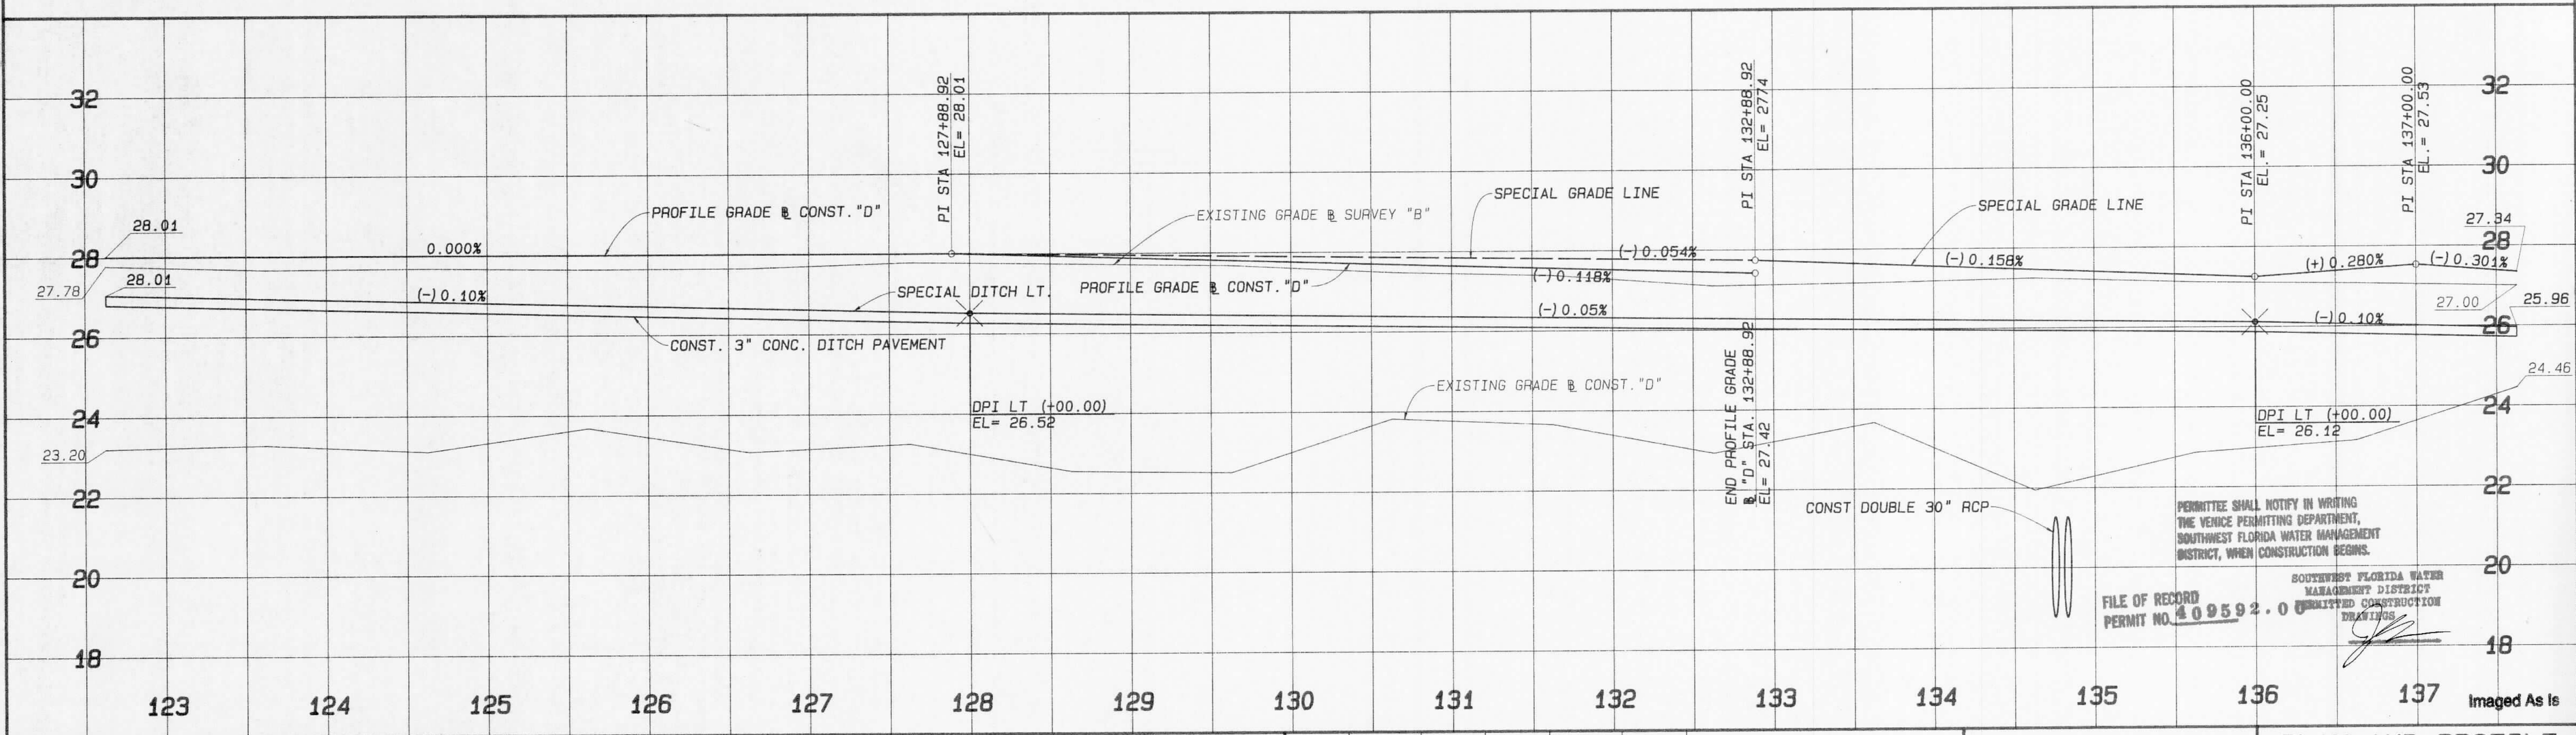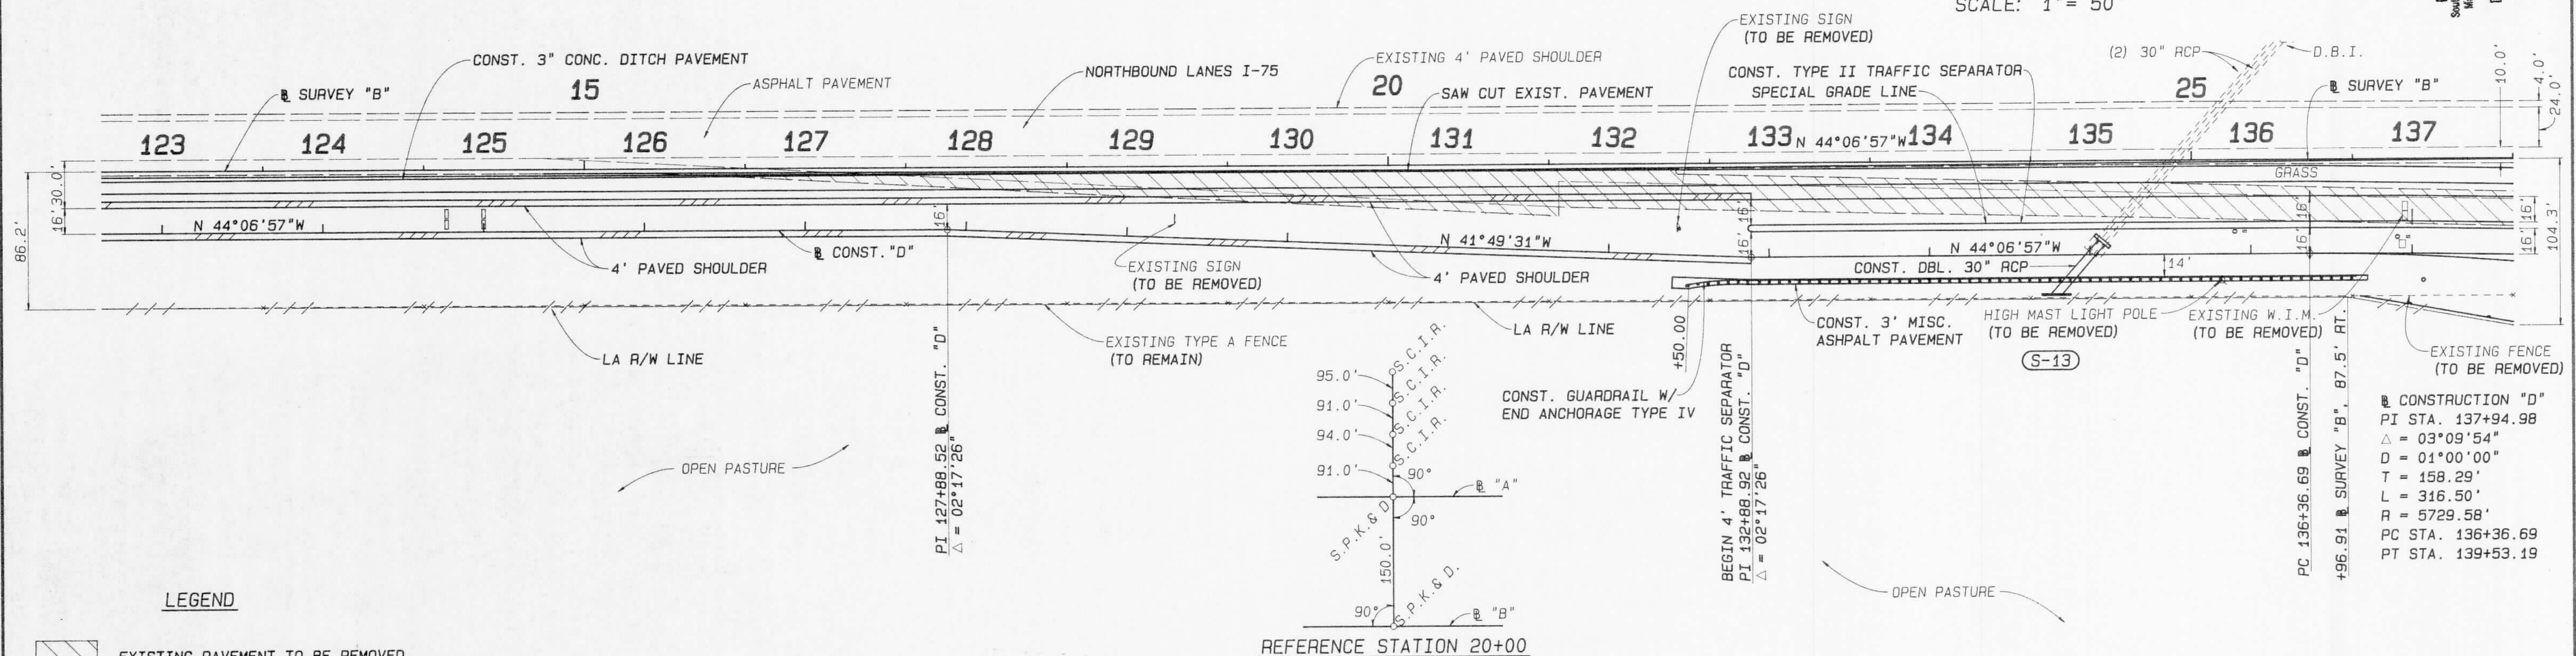



REVISIONS				DESIGNED BY				DRAWN BY				CHECKED BY				SUPERVISED BY			
DATE	BY	DESCRIPTION		NAME	DATE	NAME	DATE	NAME	DATE	NAME	DATE	NAME	DATE	NAME	DATE				
				L. CLEGG	9-91	S. WEBSTER	9-91	W.F. BIGGS	9-91	L. CLEGG	9-91	WILLIAM F. BIGGS, P.E.							

PERMITTEE SHALL NOTIFY IN WRITING THE VEHICLE PERMITTING DEPARTMENT, SOUTHWEST FLORIDA WATER MANAGEMENT DISTRICT, WHEN CONSTRUCTION BEGINS.

FILE OF RECORD PERMIT NO. 09592.0

SOUTHWEST FLORIDA WATER MANAGEMENT DISTRICT
 DISTRICT ENGINEER
 DATE 12/1/91



PLAN AND PROFILE NORTHBOUND I-75

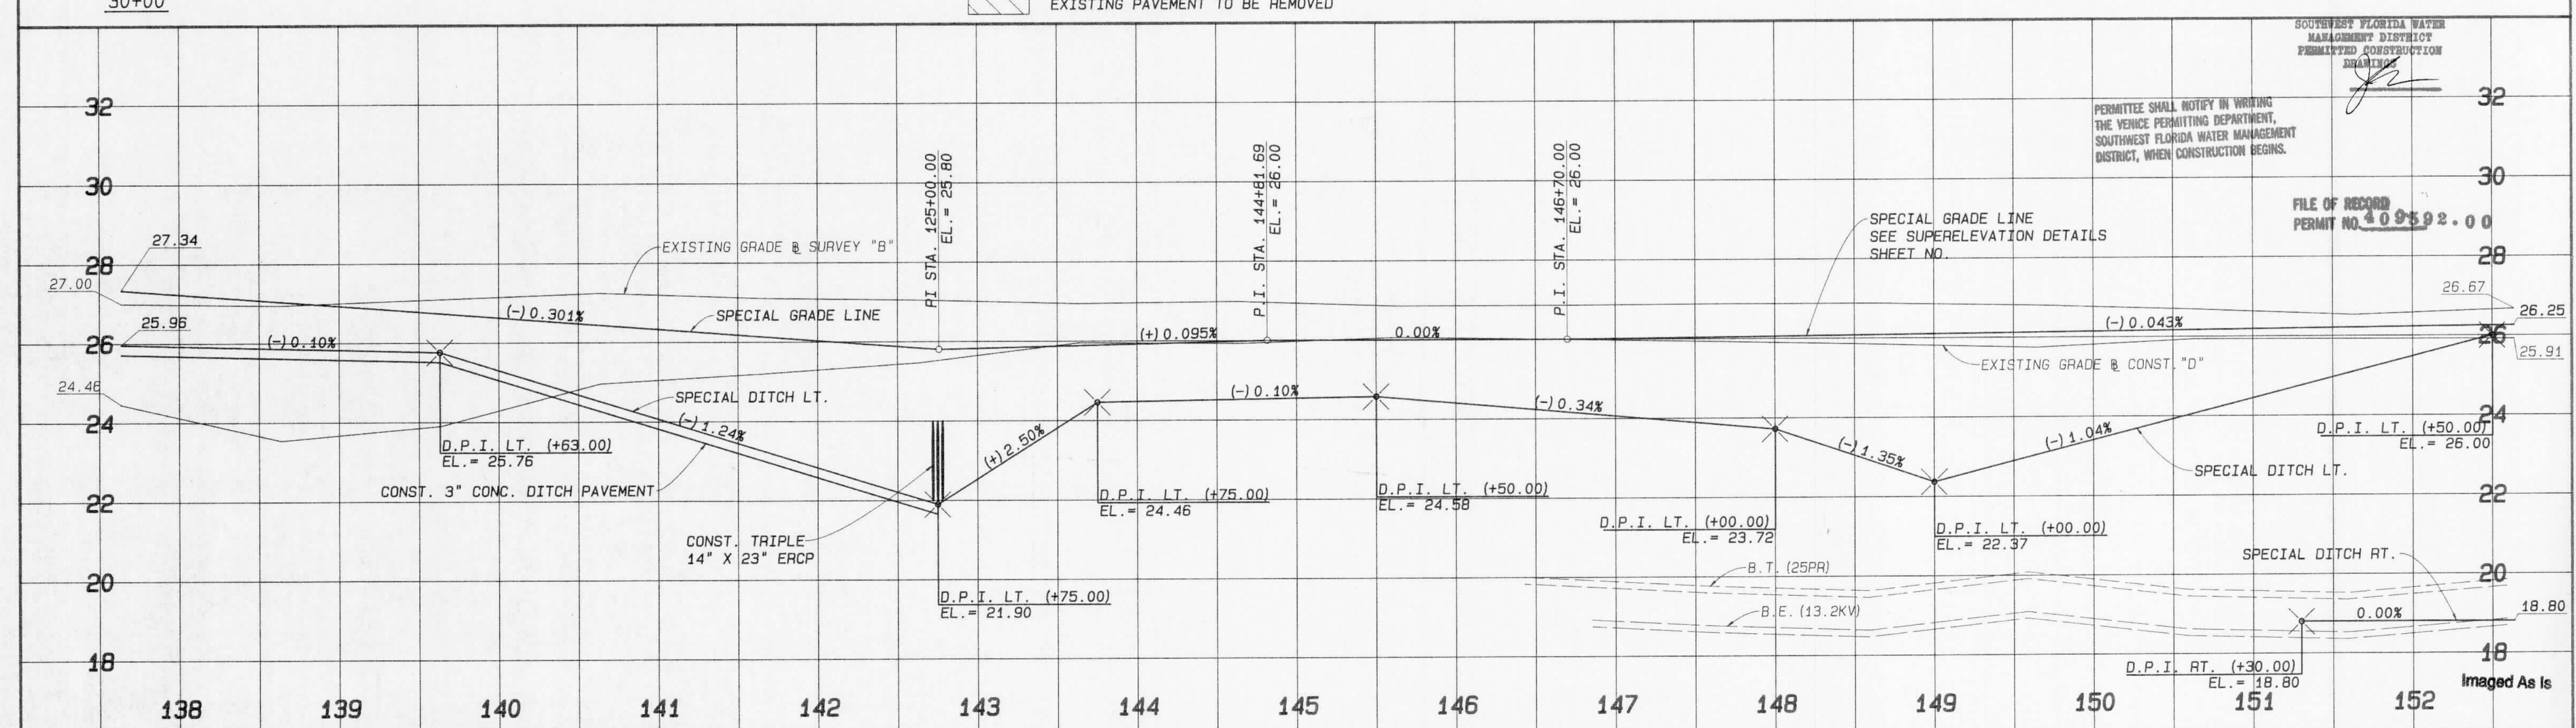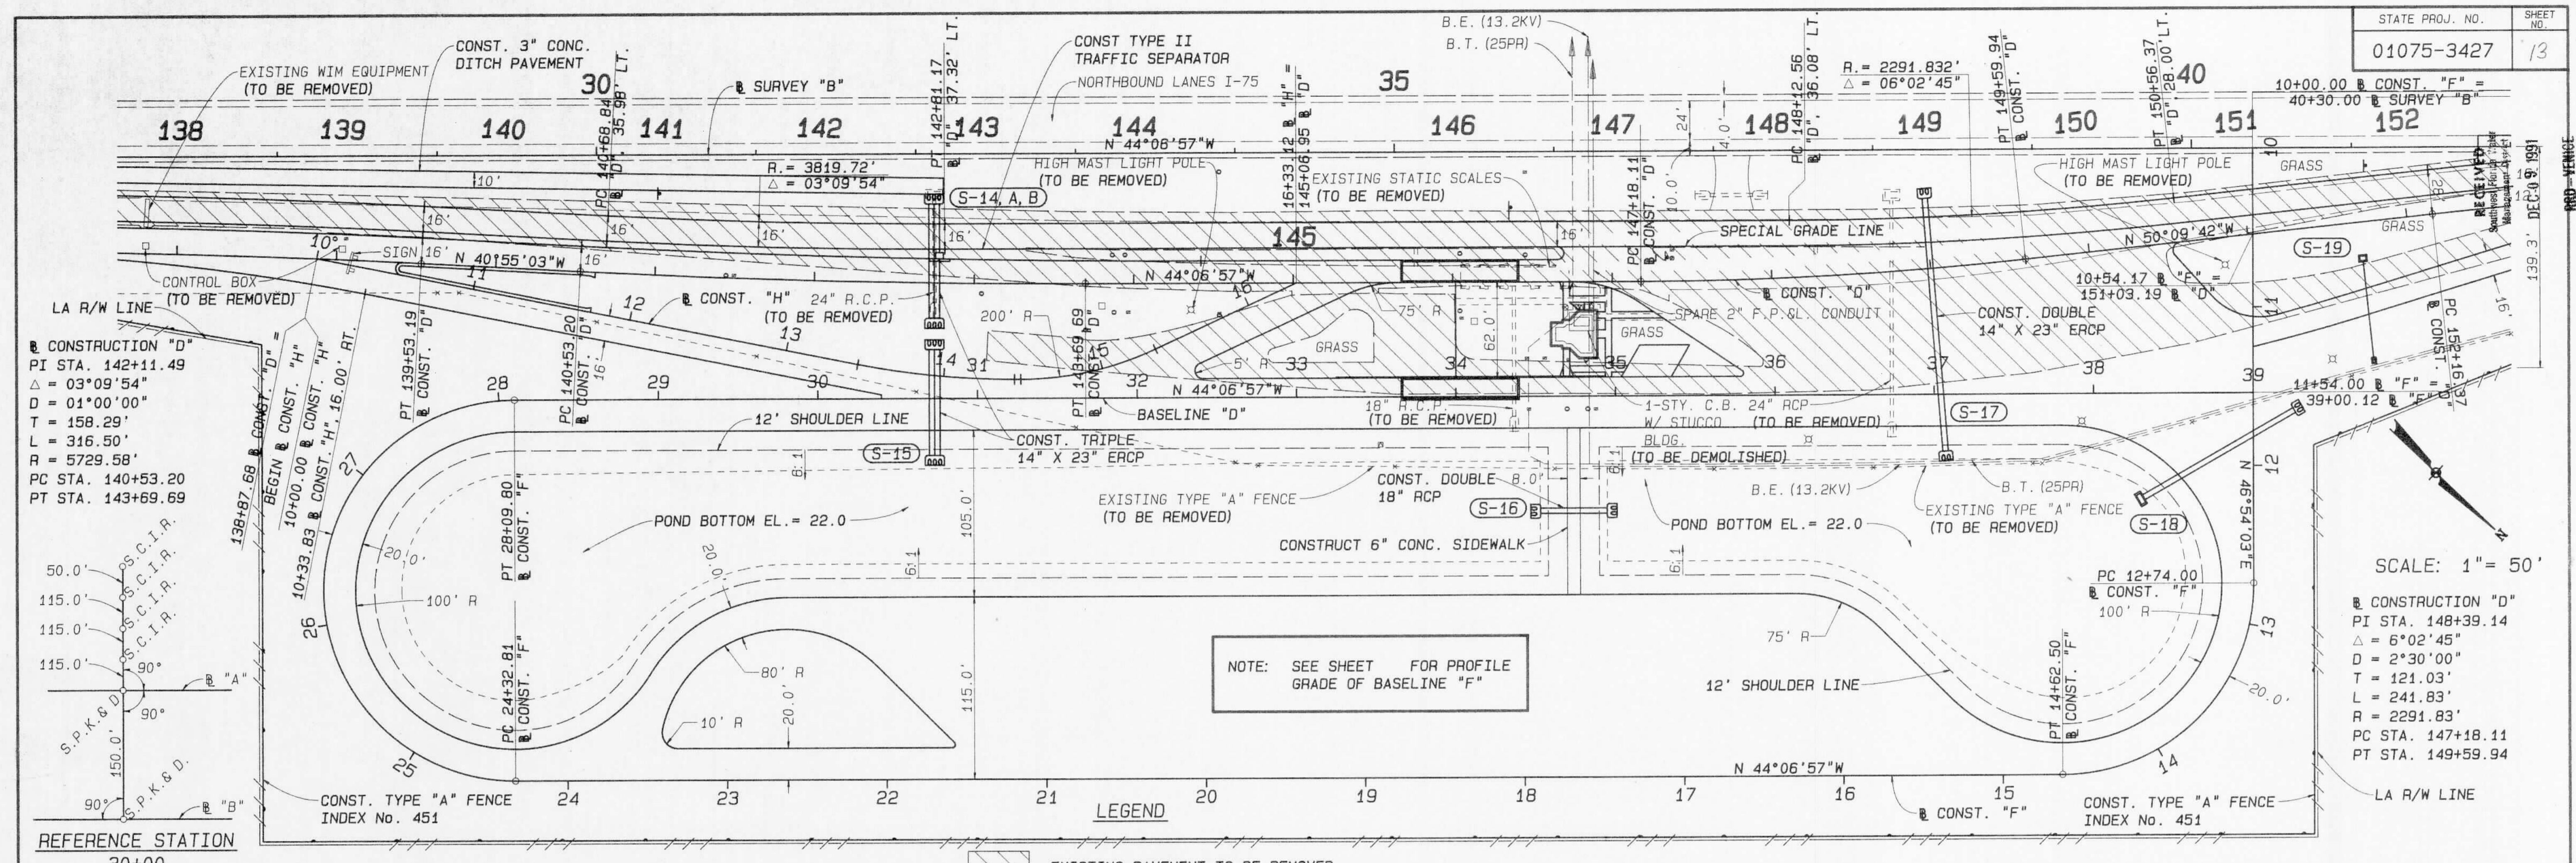

REVISIONS				DESIGNED BY				DRAWN BY				APPROVED BY			
DATE	BY	DESCRIPTION		NAME	DATE	NAME	DATE	NAME	DATE	NAME	DATE	NAME	DATE		
				L. CLEGG	10-90	S. WEBSTER	10-90	WILLIAM F. BIGGS, P.E.							
				W.F. BIGGS	10-90	L. CLEGG	10-90								

FLORIDA DEPARTMENT OF TRANSPORTATION
Boyle Engineering Corporation
 8512-A Breckenridge Parkway, Tampa, FL 33610-4251 813/621-7900
PLAN AND PROFILE NORTHBOUND I-75

C:\JUMBLE\TASK\M_BIGGS\METHP-FUNTA\S_NBS_BROILED BY DCE ON 23 SEP 1991 AT 13:51:13

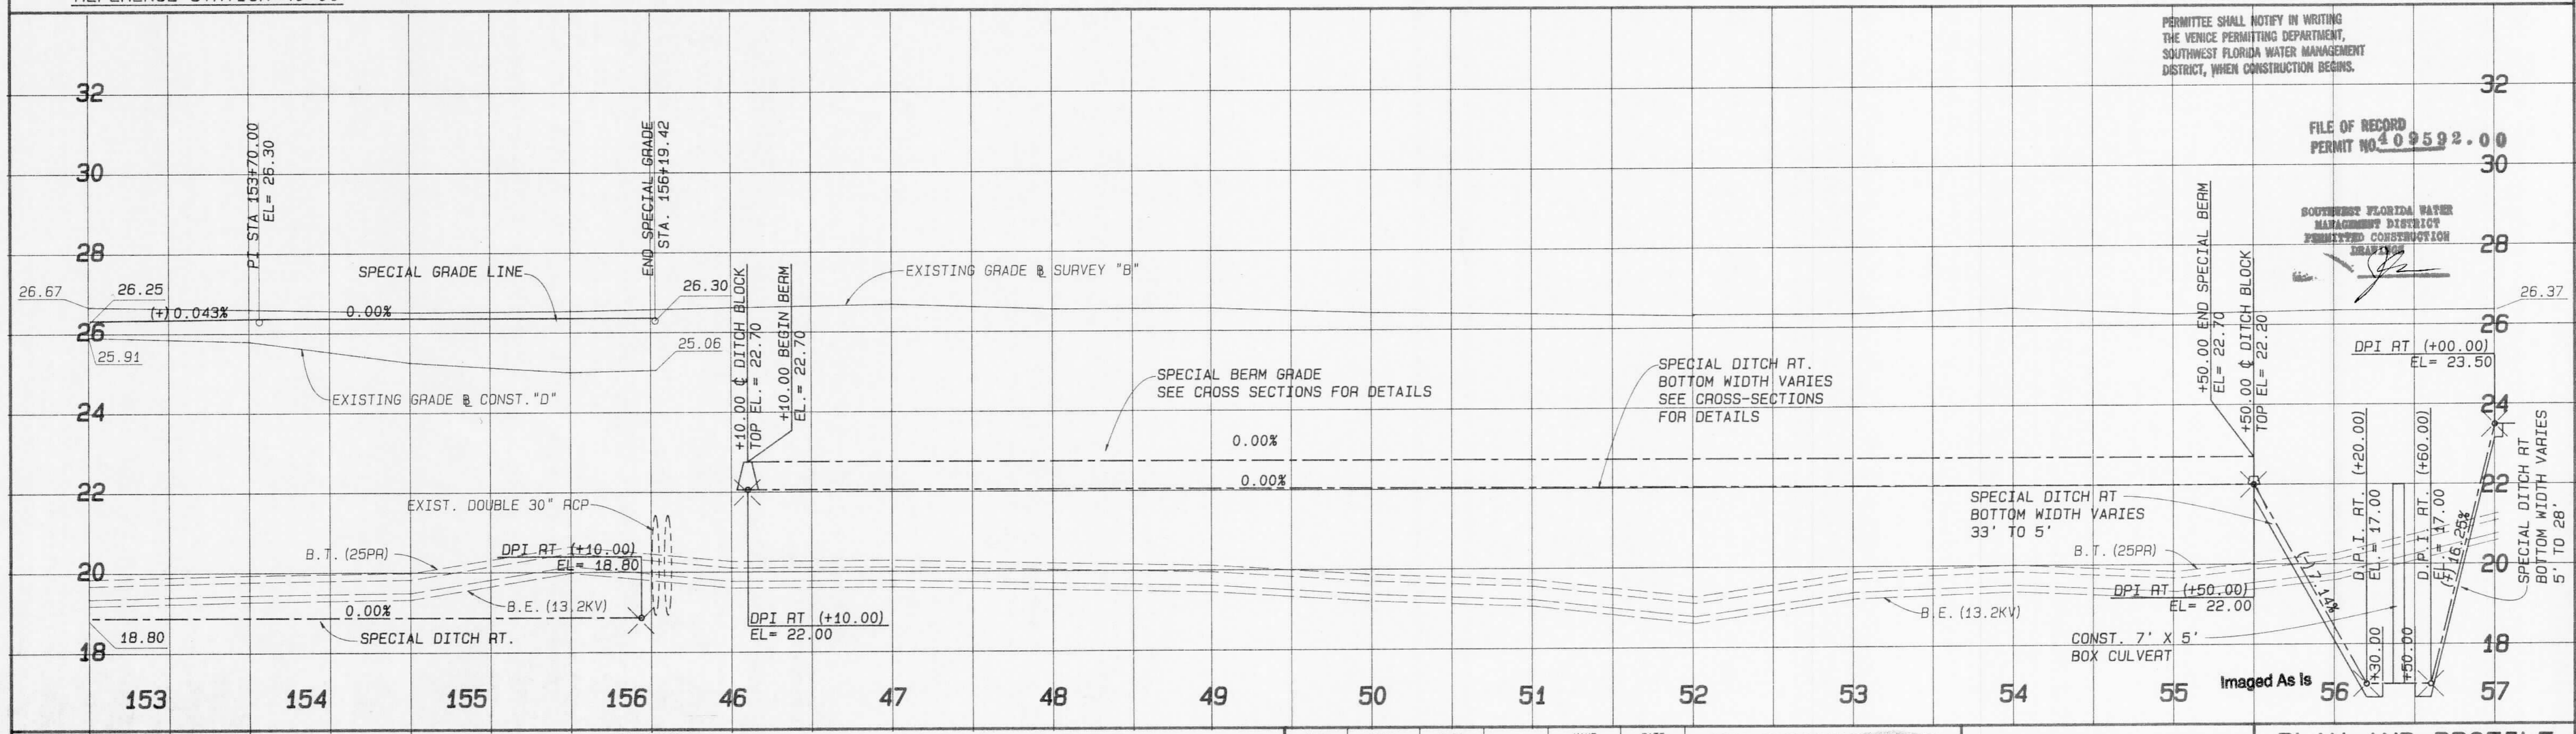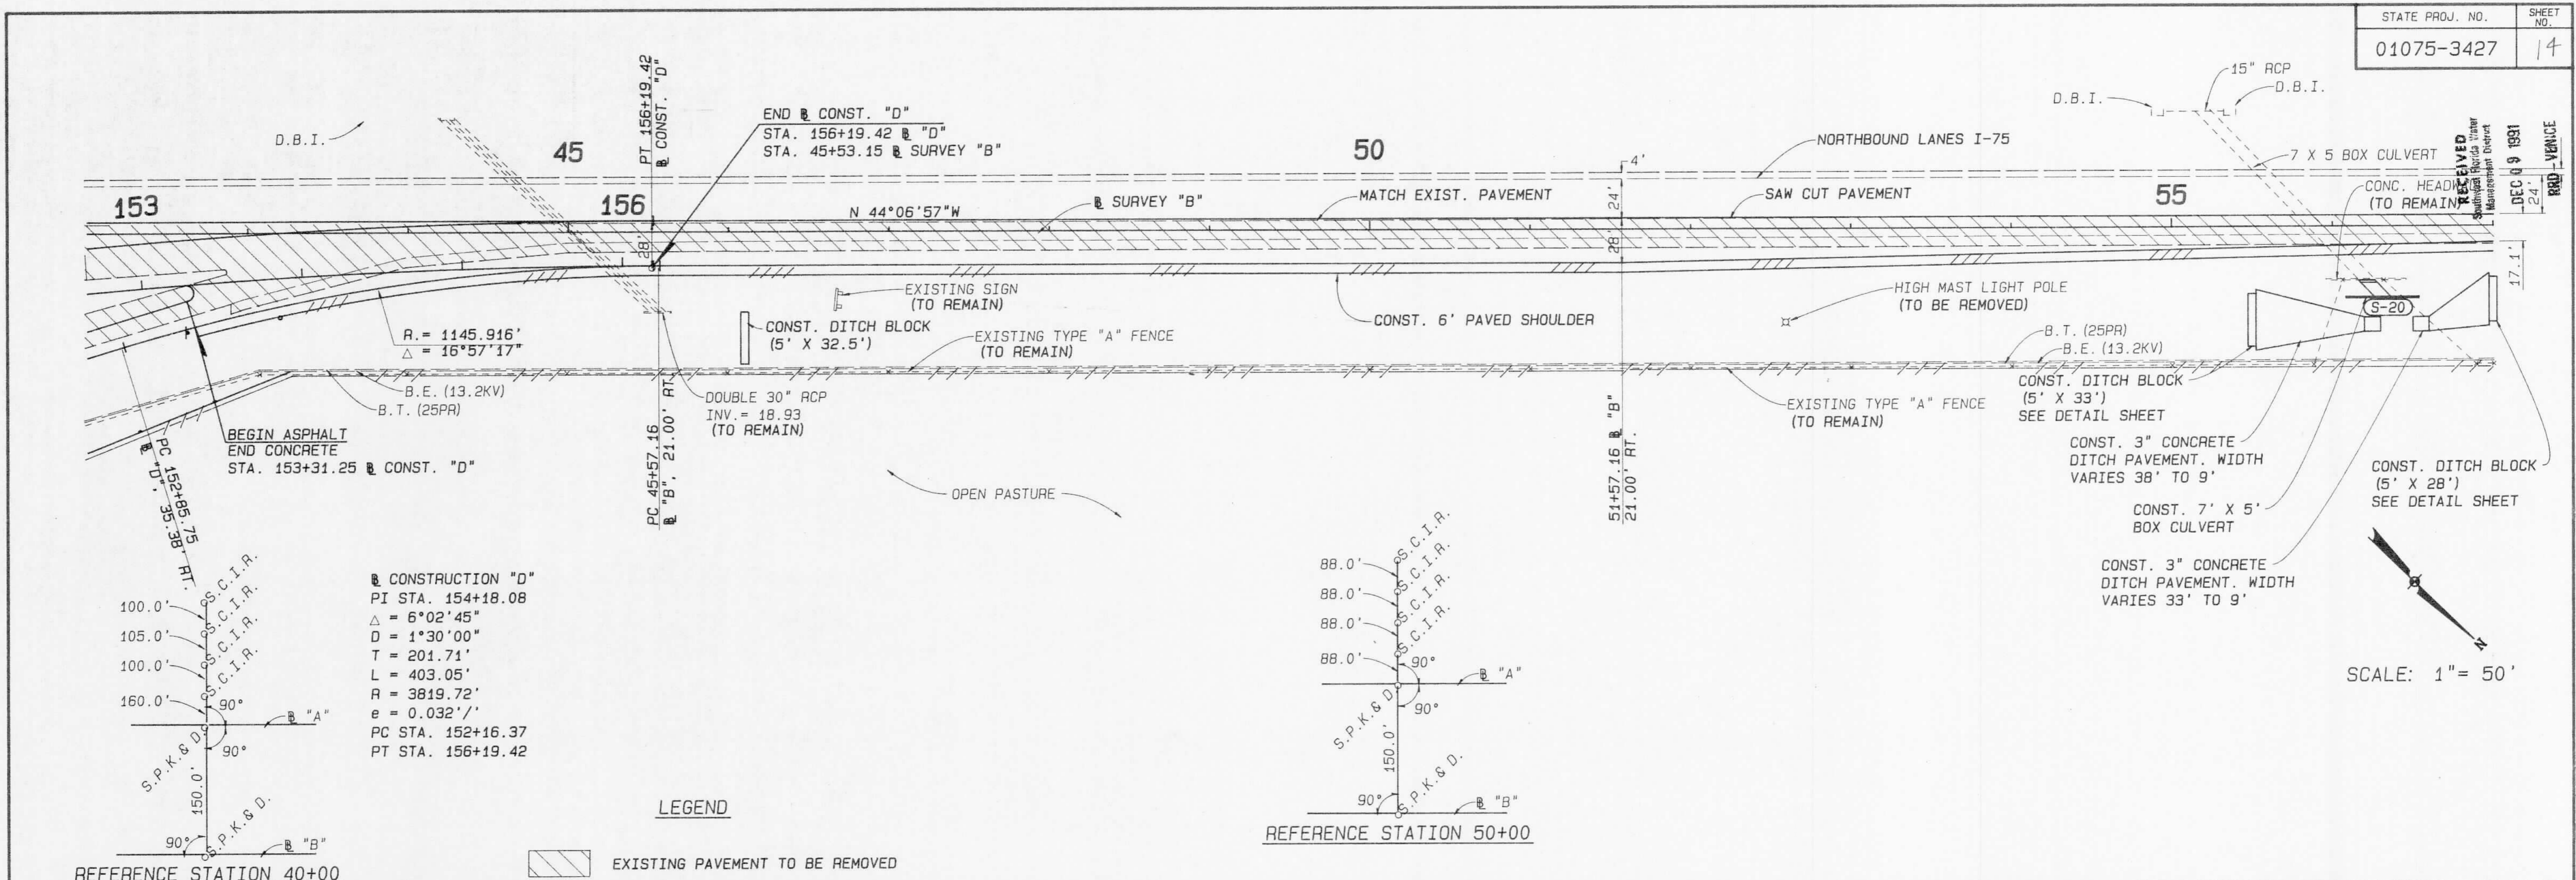

REVISIONS				DESIGNED BY				DRAWN BY				CHECKED BY				SUPERVISED BY			
DATE	BY	DESCRIPTION		NAME	DATE	NAME	DATE	NAME	DATE	NAME	DATE	NAME	DATE	NAME	DATE	NAME	DATE		
				L. CLEGG	9-91	S. WEBSTER	9-91	L. CLEGG	9-91	W. F. BIGGS	9-91	WILLIAM F. BIGGS, P.E.							


FLORIDA DEPARTMENT OF TRANSPORTATION

Bouje Engineering Corporation of Florida


5912-A Brackley Ridge Parkway, Tampa, FL 33610-4251 813/621-7900

PLAN AND PROFILE NORTHBOUND I-75

C:\JUMBLE>TASK-N.BIGGS\WEIGH-PUNTA\S.NB4 SPOOLED BY CDE ON 04 DEC 1991 AT 10:31:56

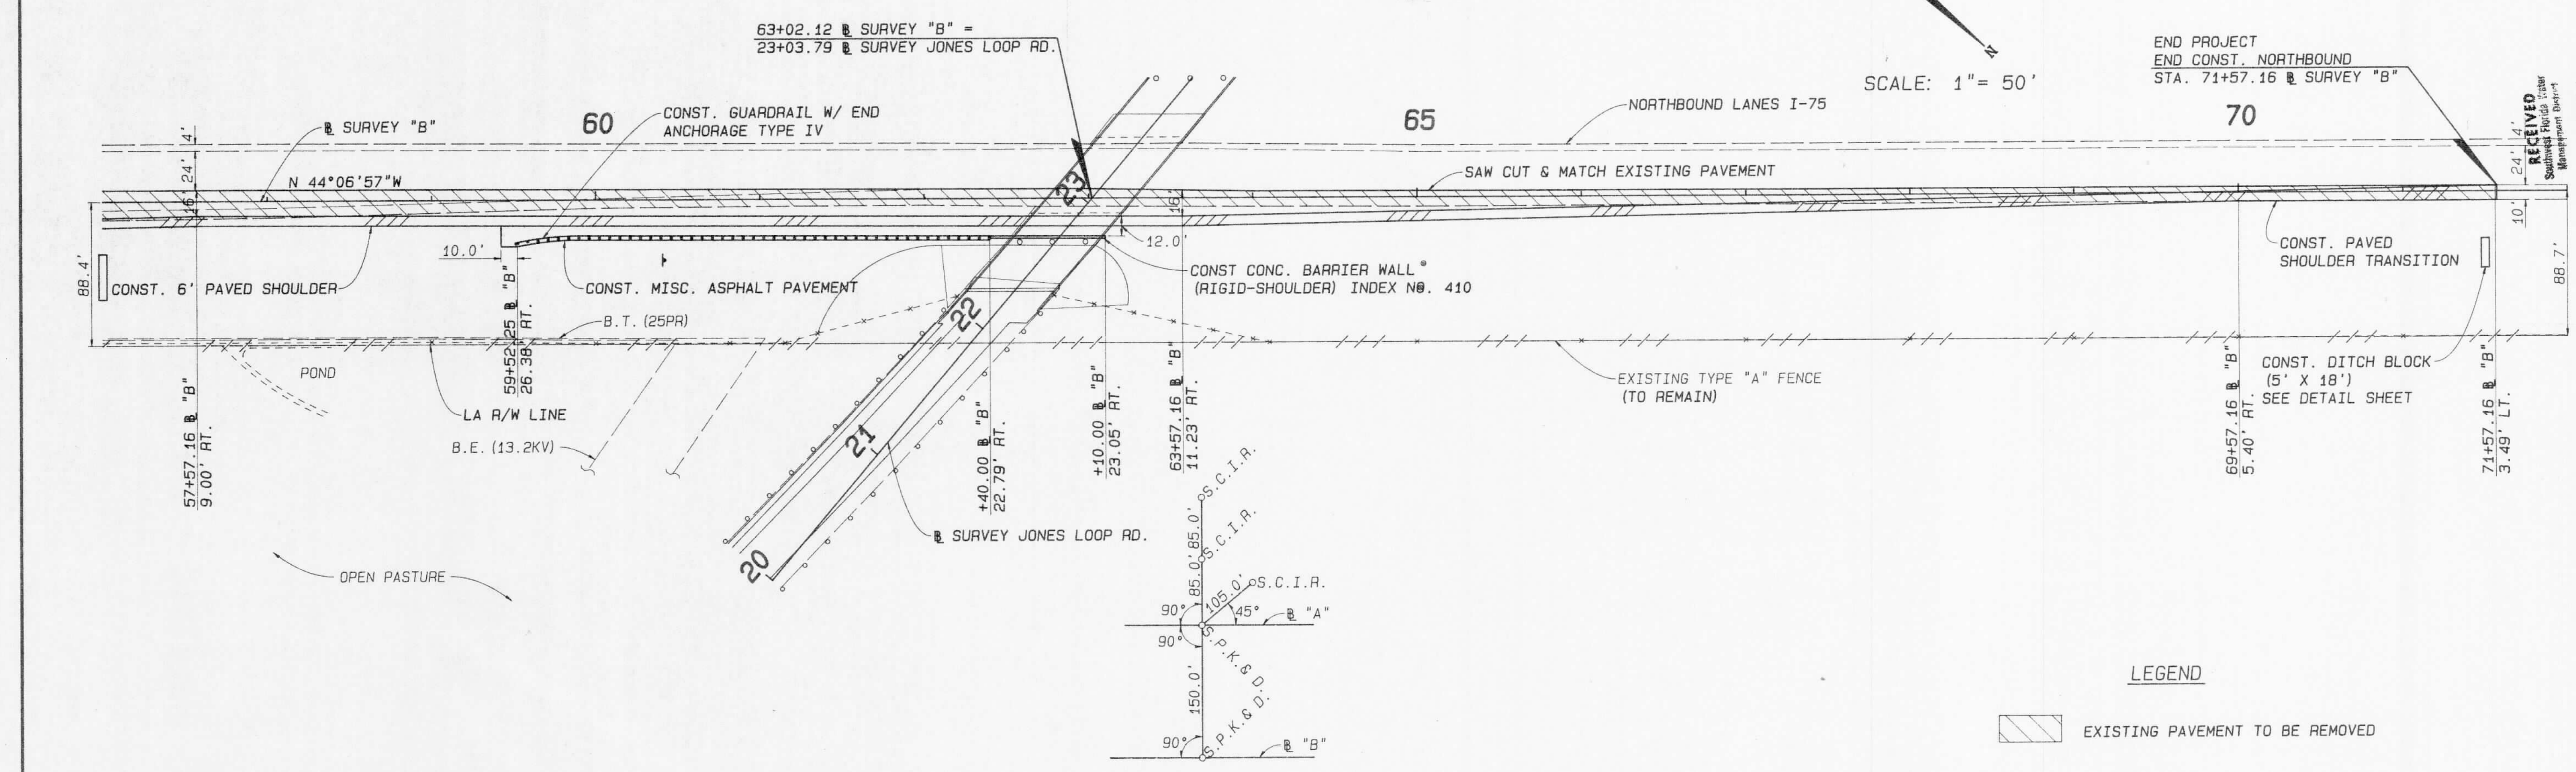

REFERENCE STATION 63+00

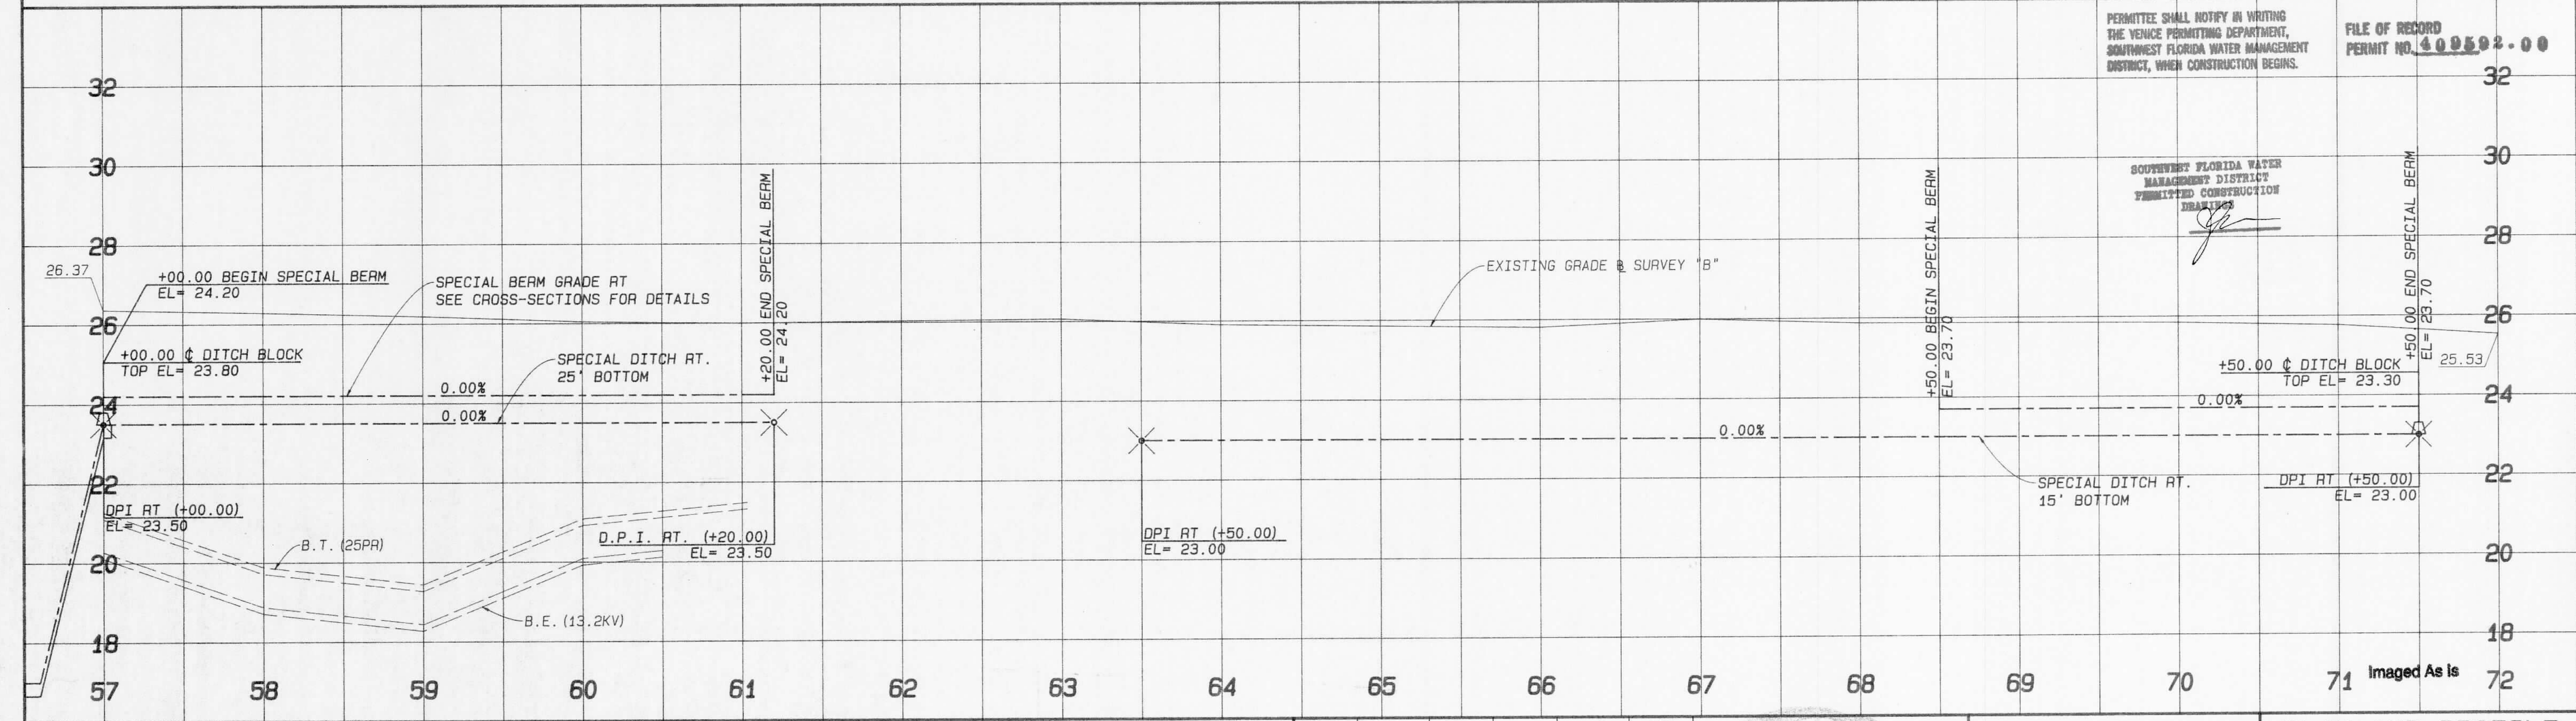

PERMITEE SHALL NOTIFY IN WRITING THE VENICE PERMITTING DEPARTMENT, SOUTHWEST FLORIDA WATER MANAGEMENT DISTRICT, WHEN CONSTRUCTION BEGINS.

FILE OF RECORD PERMIT NO. 409592-00

SOUTHWEST FLORIDA WATER MANAGEMENT DISTRICT PERMITTED CONSTRUCTION DRAWINGS

REVISIONS							
DATE	BY	DESCRIPTION	DATE	BY	DESCRIPTION	DATE	BY

NBS	NAME	DATE	NAME	DATE
DESIGNED BY	L. CLEGG	9-91	DRAWN BY	S. WEBSTER
CHECKED BY	W.F. BIGGS	9-91	CHECKED BY	L. CLEGG
SUPERVISED BY	WILLIAM F. BIGGS, P.E.			

FLORIDA DEPARTMENT OF TRANSPORTATION

APPROVED BY

DATE 12/6/91


Boyle Engineering Corporation of Florida

5912-A Breckenridge Parkway, Tampa, FL 33610-4251

PLAN AND PROFILE NORTHBOUND I-75

C:\JUMBLE\TASK\M.BIGGS\WEIGH\PUNTA\S.NBS SPOOLED BY CDE ON 04 DEC 1991 AT 10:58:07

RECEIVED
Southwest Florida Water Management District
DEC 09 1991
RDW-VLK-E

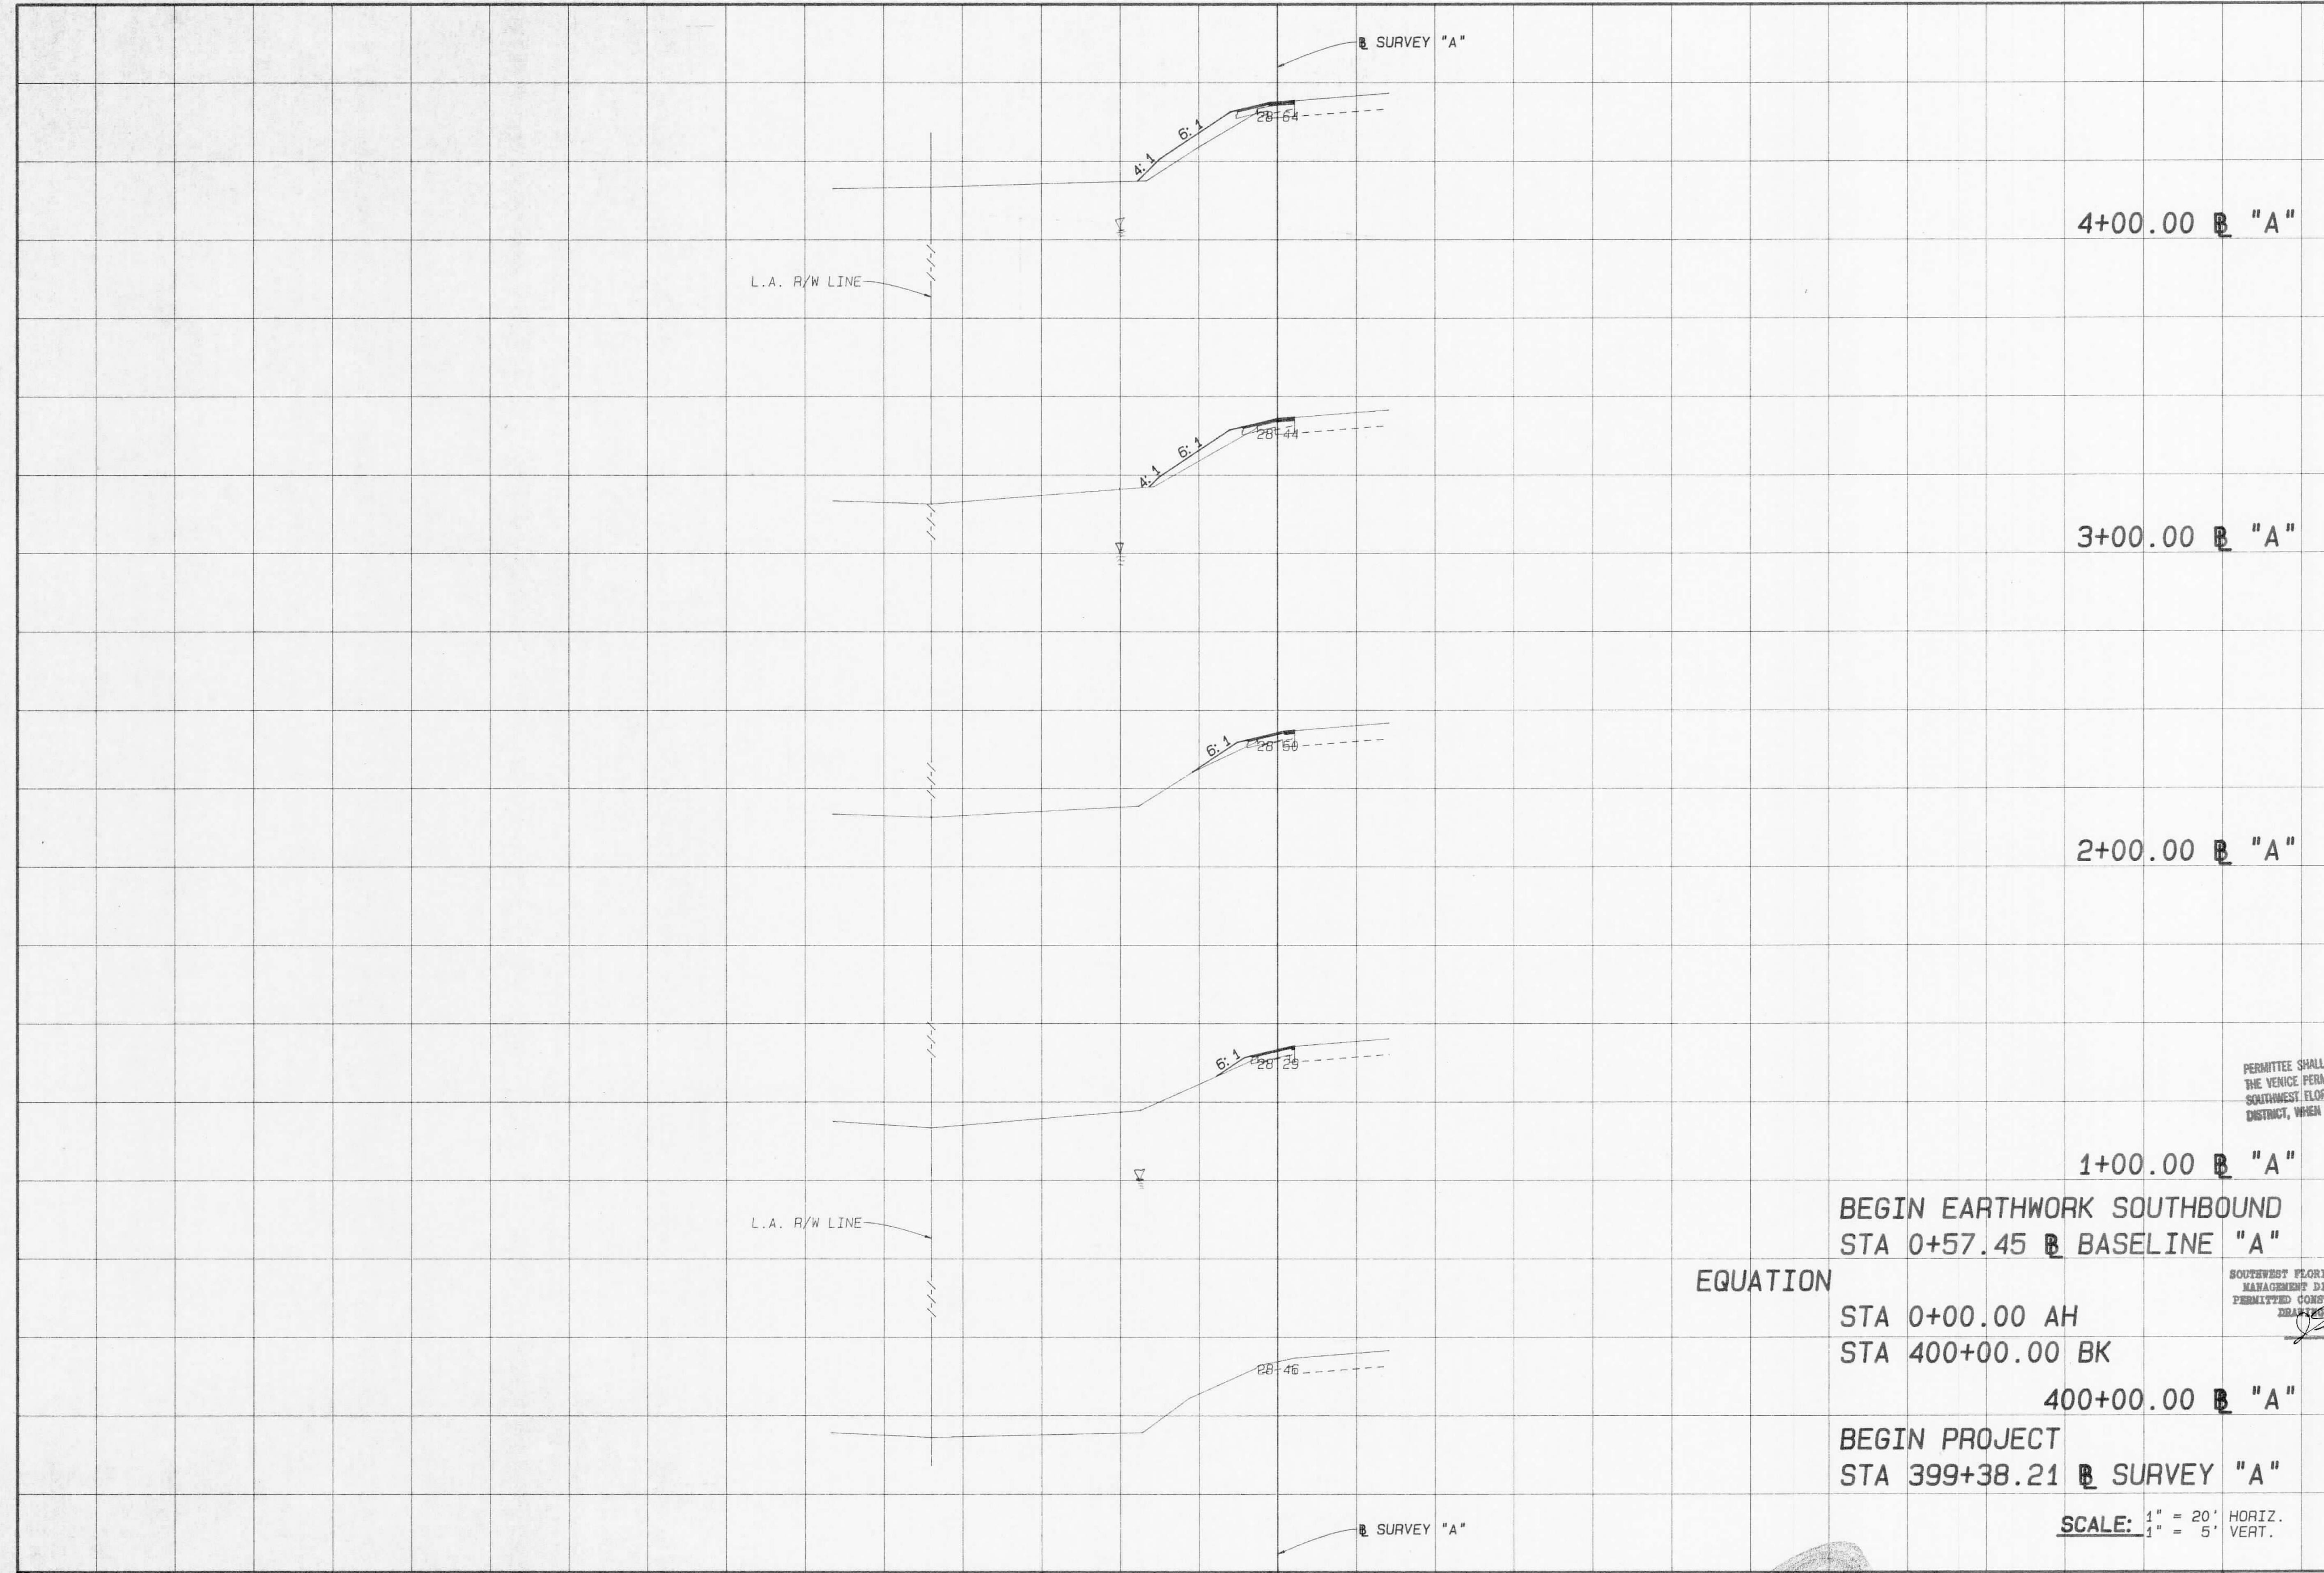

PERMITTEE SHALL NOTIFY IN WRITING THE VENICE PERMITTING DEPARTMENT, SOUTHWEST FLORIDA WATER MANAGEMENT DISTRICT, WHEN CONSTRUCTION BEGINS.

BEGIN EARTHWORK SOUTHBOUND
STA 0+57.45 B BASELINE "A"

EQUATION

STA 0+00.00 AH
STA 400+00.00 BK

400+00.00 B "A"

BEGIN PROJECT
STA 399+38.21 B SURVEY "A"

SCALE: 1" = 20' HORIZ.
1" = 5' VERT.

SOUTHWEST FLORIDA WATER MANAGEMENT DISTRICT
PERMITTED CONSTRUCTION
DRAWN BY [Signature]

FILE OF RECORD
PERMIT NO. 409592.00

Imaged As Is

REVISIONS											
DATE	BY	DESCRIPTION	DATE	BY	DESCRIPTION	DATE	BY	DESCRIPTION	DATE	BY	DESCRIPTION

XS-A2	NAME	DATE	NAME	DATE
DESIGNED BY	L.P. CLEGG	7-91	DRAWN BY	S.W./A.C.
CHECKED BY	W.F. BIGGS	7-91	CHECKED BY	L.P. CLEGG
SUPERVISED BY	WILLIAM F. BIGGS, P.E.			

FLORIDA DEPARTMENT OF TRANSPORTATION
APPROVED BY [Signature]
DATE 12/16/91

Souje Engineering Corporation
of Florida
5912-A Breckner Lodge Parkway, Tampa, FL 33610-4251 813/571-7900

CROSS SECTIONS
SOUTHBOUND I-75


C:\JUMBLE\TASK-N.BIGGS\WEIGH\PIK\TAS-XS-A2 SPLODED BY CDE ON 04 SEP 1991 AT 11:49:57

C:\JUMBLE\TASK\M.BIGGS\NEIGH-PUNTA>*.x6-a3 SPOOLED BY CLEGG ON 19 NOV 1991 AT 17:39:53

STATE PROJ. NO. 01075-3427 SHEET NO. 32

Rdwy. Exc. A V Fill A V

RECEIVED
Southwest Florida Water Management District
DEC 09 1991
RDW - VENICE

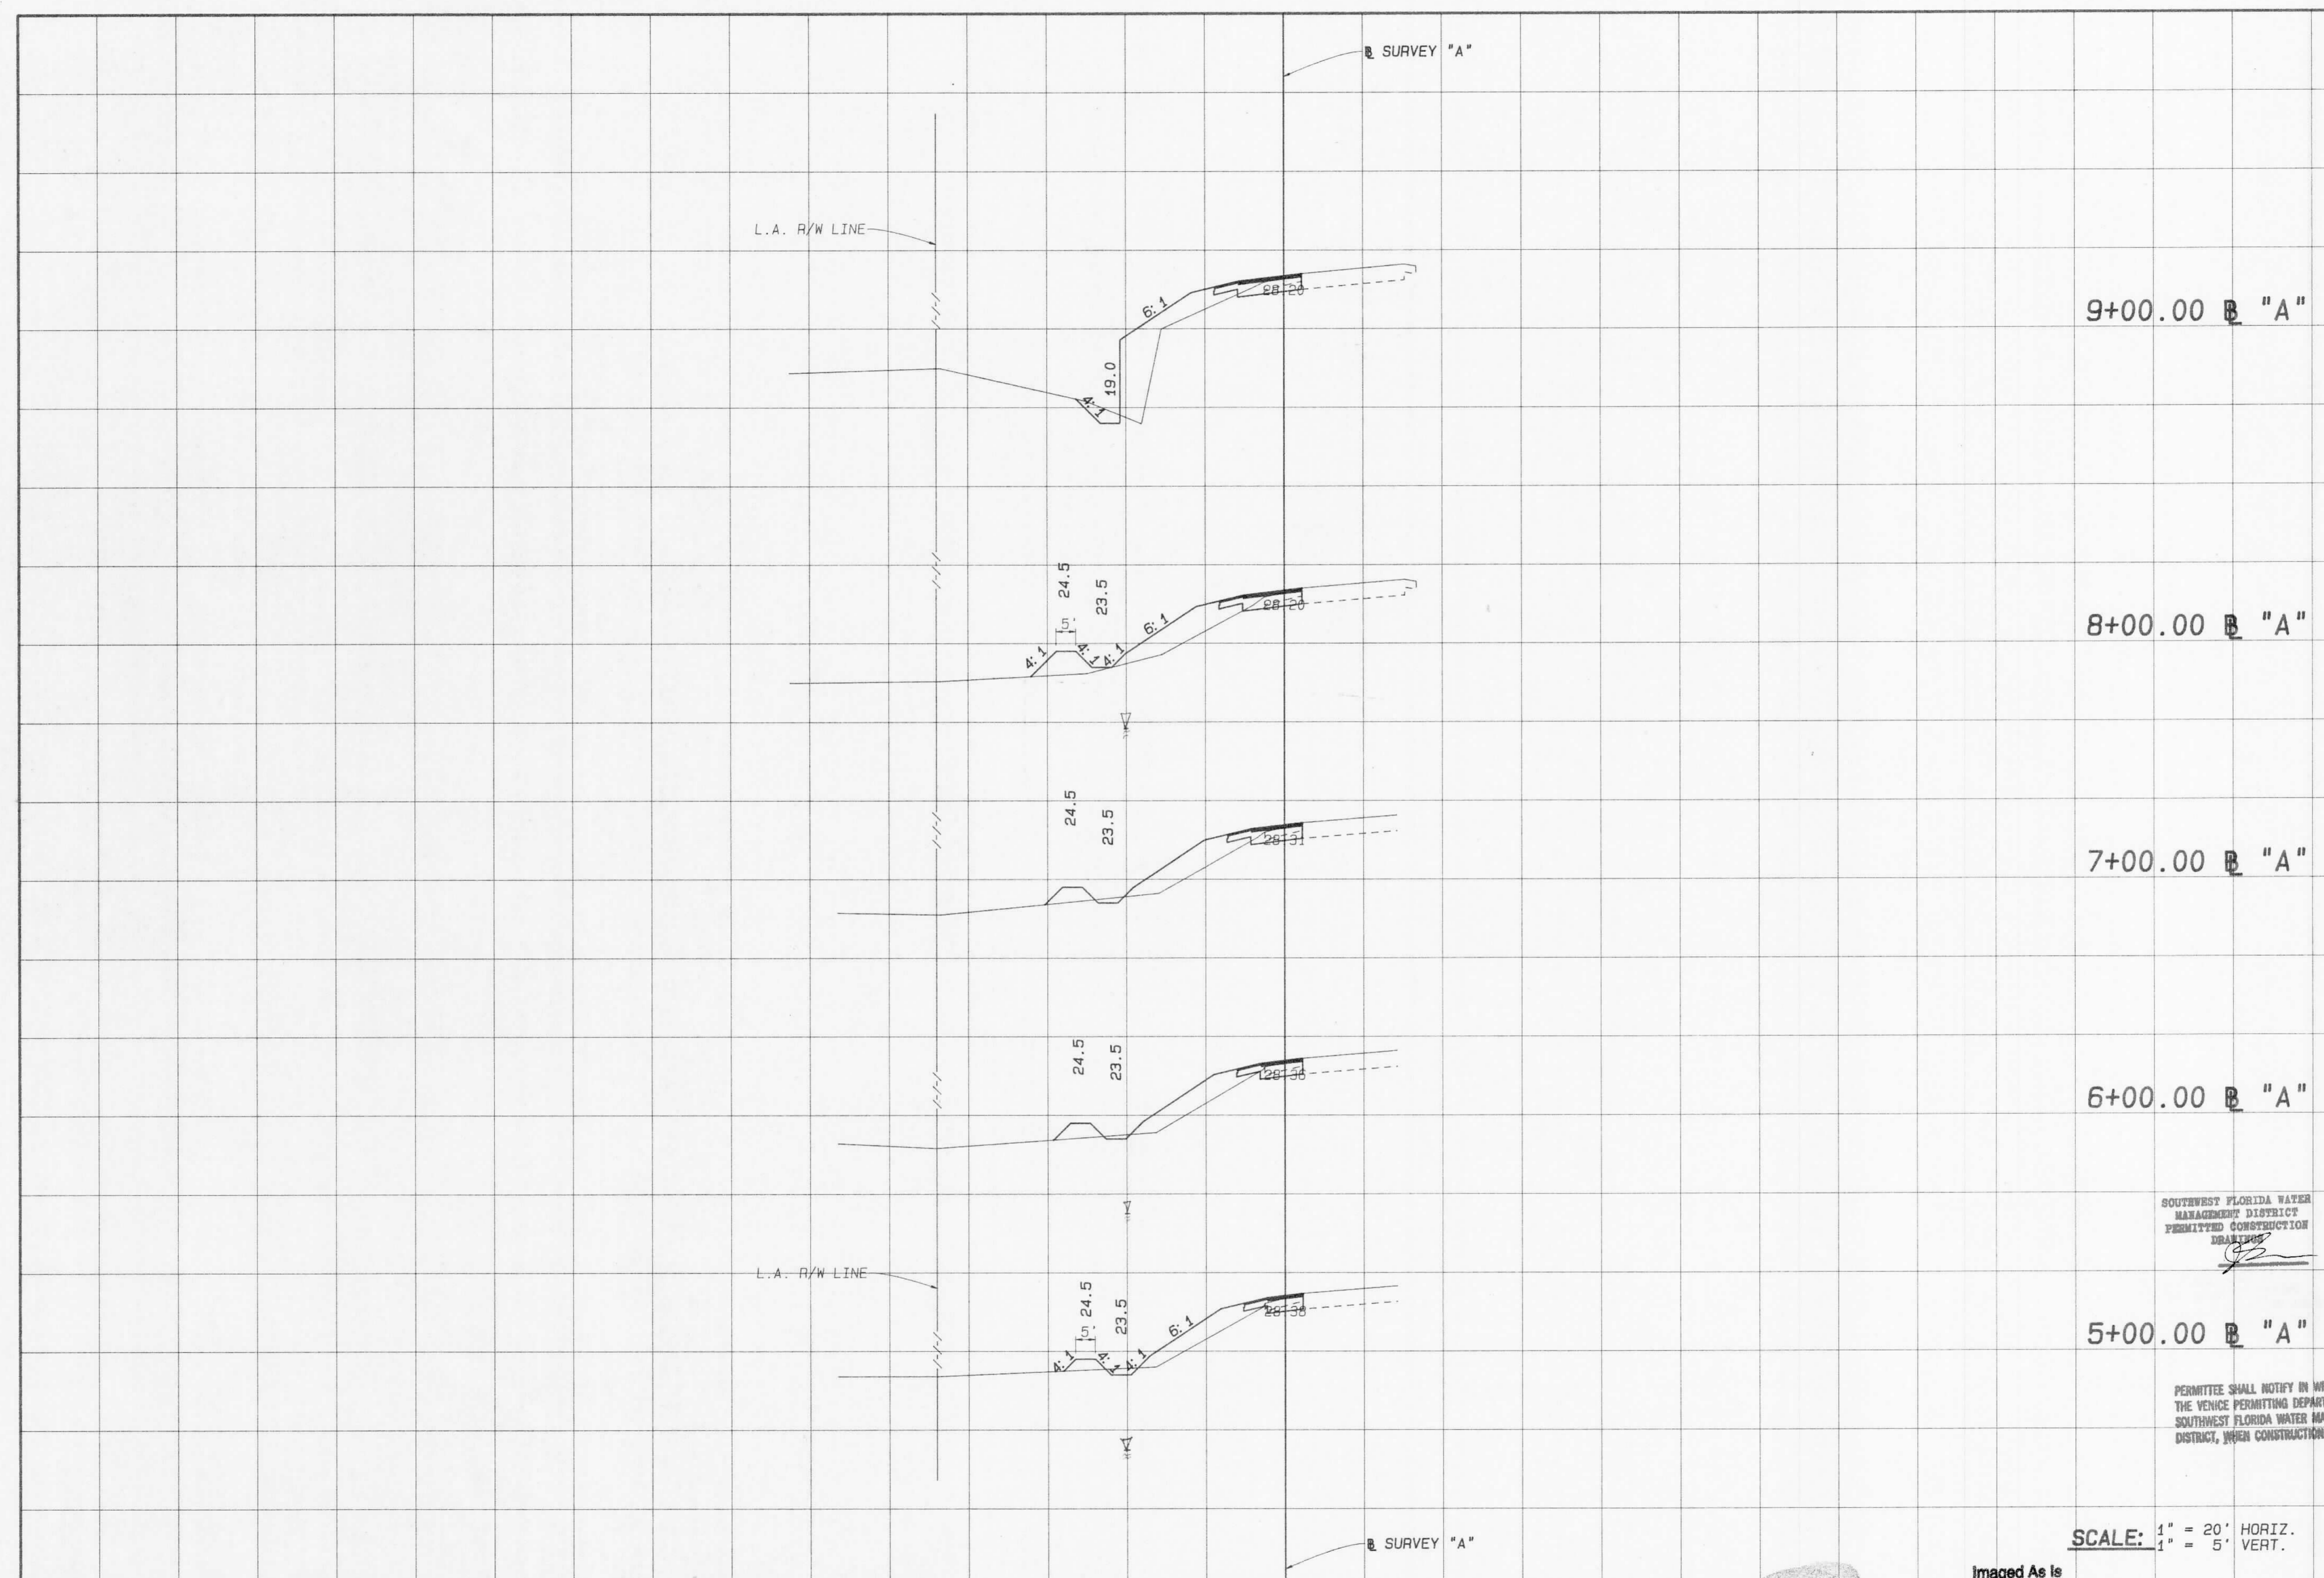

SCALE: 1" = 20' HORIZ. 1" = 5' VERT. FILE OF RECORD PERMIT NO. 409592-00

SOUTHWEST FLORIDA WATER MANAGEMENT DISTRICT
PERMITTED CONSTRUCTION
DRAWING

PERMITTEE SHALL NOTIFY IN WRITING THE VENICE PERMITTING DEPARTMENT, SOUTHWEST FLORIDA WATER MANAGEMENT DISTRICT, WHEN CONSTRUCTION BEGINS.

REVISIONS							
DATE	BY	DESCRIPTION	DATE	BY	DESCRIPTION	DATE	BY

XS-A3	NAME	DATE	NAME	DATE
DESIGNED BY	L.P. CLEGG	8-91	DRAWN BY	S.W./A.C.
CHECKED BY	W.F. BIGGS	8-91	CHECKED BY	L.P. CLEGG
SUPERVISED BY WILLIAM F. BIGGS, P.E.				

FLORIDA DEPARTMENT OF TRANSPORTATION
APPROVED BY
[Signature]
DATE 12/01/91

Boyle Engineering Corporation
of Florida
5912-A Breckenridge Parkway, Tampa, FL 33619-4251 813/621-7900


CROSS SECTIONS
SOUTHBOUND I-75

409592-00

32

Row	Exc.	Fill
A	V	A
		V

RECEIVED
 Southwest Florida Water
 Management District
 DEC 09 1991
 RD - VENICE

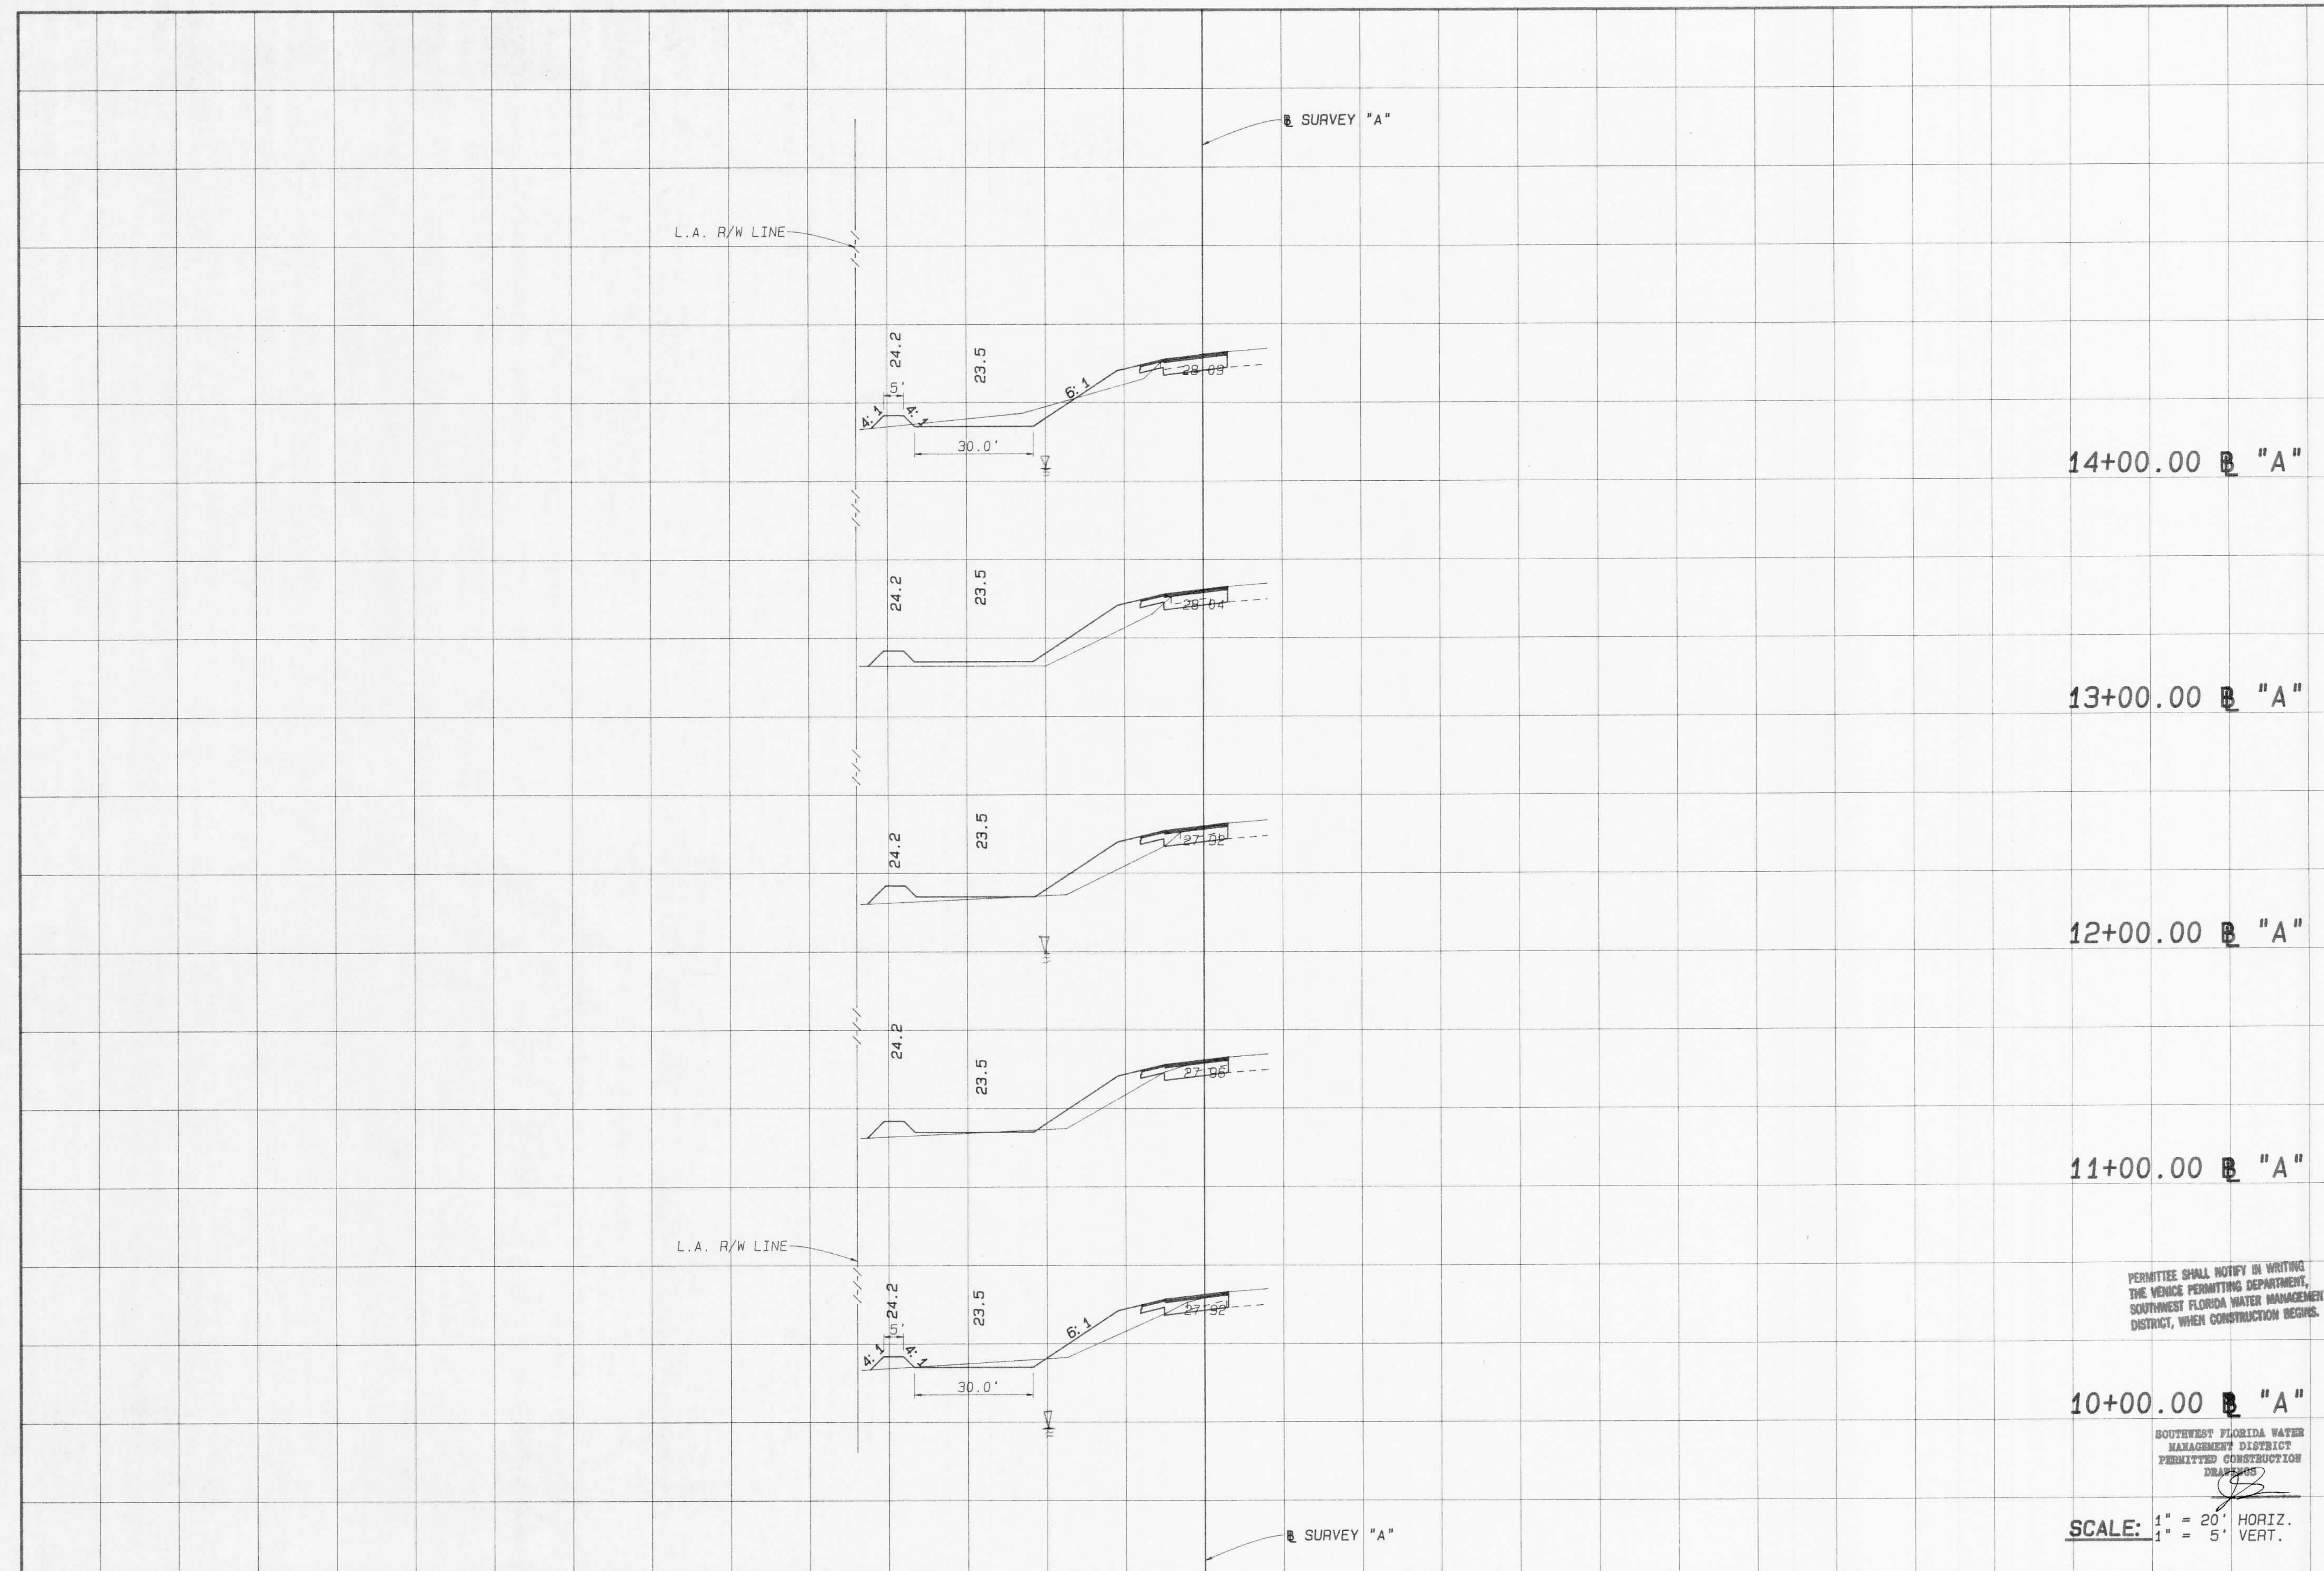

PERMITTEE SHALL NOTIFY IN WRITING
 THE VENICE PERMITTING DEPARTMENT,
 SOUTHWEST FLORIDA WATER MANAGEMENT
 DISTRICT, WHEN CONSTRUCTION BEGINS.

SOUTHWEST FLORIDA WATER
 MANAGEMENT DISTRICT
 PERMITTED CONSTRUCTION
 DRAPEWIS

SCALE: 1" = 20' HORIZ.
 1" = 5' VERT.

FILE OF RECORD
 PERMIT NO. 409592-00

Imaged As Is

REVISIONS							
DATE	BY	DESCRIPTION	DATE	BY	DESCRIPTION	DATE	BY

XS-A4	NAME	DATE	NAME	DATE
DESIGNED BY	L.P. CLEGG	8-91	DRAWN BY	S.W./A.C.
CHECKED BY	W.F. BIGGS	8-91	CHECKED BY	L.P. CLEGG
SUPERVISED BY	WILLIAM F. BIGGS, P.E.			

FLORIDA DEPARTMENT OF TRANSPORTATION
 APPROVED BY
 DATE 12/6/91

Boyle Engineering Corporation
 of Florida
 5512-A Breckenridge Parkway, Tampa, FL 33610-4251 813/821-7800


CROSS SECTIONS
 SOUTHBOUND I-75

<JUMBLE>TASK\M.BIGGS\WEIGH\PRINT\XS-A4 SPOOLED BY WEBSTER ON 26 NOV 1991 AT 08:51:30


RECEIVED
Southwest Florida Water
Management District
DEC 09 1991
RRD - VEHICLE

SURVEY "A"


L.A. R/W LINE

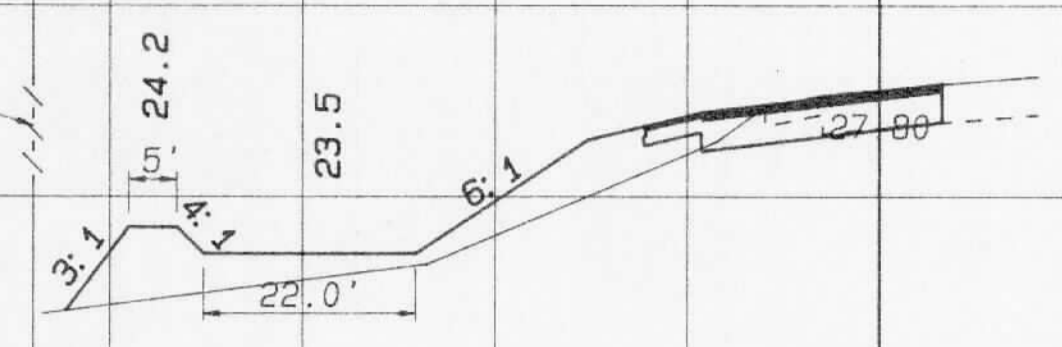


19+00.00 B "A"

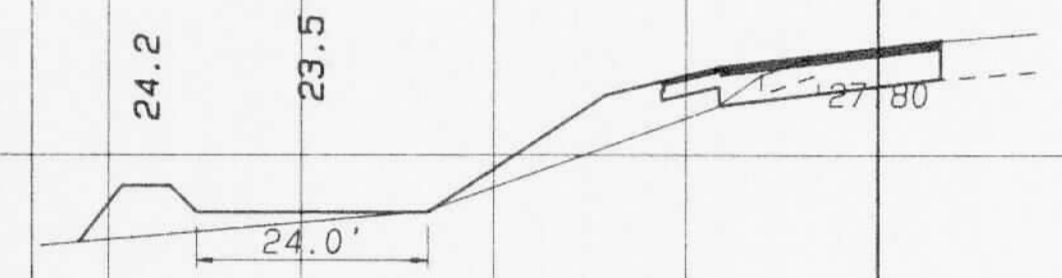

18+00.00 B "A"

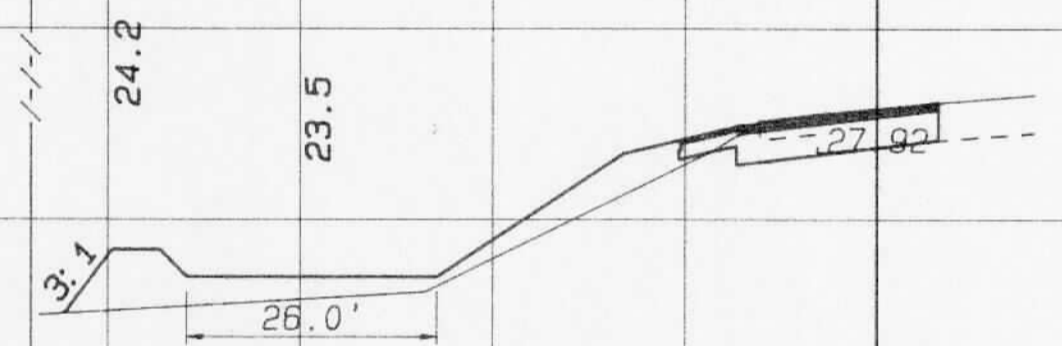


17+00.00 B "A"

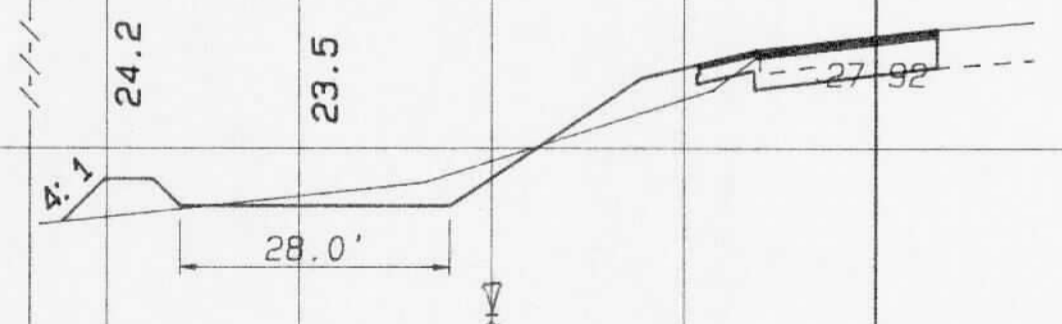

16+00.00 B "A"

L.A. R/W LINE

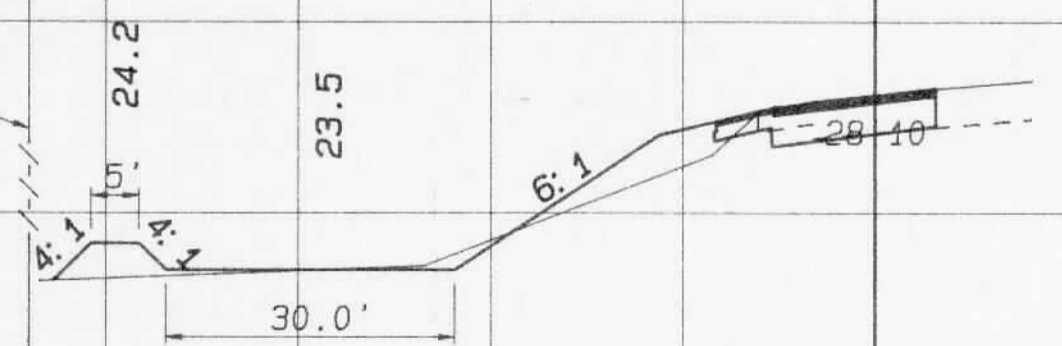

15+00.00 B "A"

PERMITEE SHALL NOTIFY IN WRITING
THE VENICE PERMITTING DEPARTMENT,
SOUTHWEST FLORIDA WATER MANAGEMENT
DISTRICT, WHEN CONSTRUCTION BEGINS.

SOUTHWEST FLORIDA WATER
MANAGEMENT DISTRICT
PERMITTED CONSTRUCTION
DRAWN BY
[Signature]

Imaged As Is

SCALE: 1" = 20' HORIZ.
1" = 5' VERT.

FILE OF RECORD
PERMIT NO. 409592.00

REVISIONS							
DATE	BY	DESCRIPTION	DATE	BY	DESCRIPTION	DATE	BY

XS-A5	NAME	DATE	NAME	DATE
DESIGNED BY	L. P. CLEGG	8-91	DRAWN BY	S. W. / A. C.
CHECKED BY	W. F. BIGGS	8-91	CHECKED BY	L. P. CLEGG
SUPERVISED BY	WILLIAM F. BIGGS, P.E.			

FLORIDA DEPARTMENT OF TRANSPORTATION
APPROVED BY
[Signature]
DATE 12/6/91

Boyle Engineering Corporation
of Florida
5912-A Breckneridge Parkway, Tampa, FL 33610-4251 813/621-7200

CROSS SECTIONS,
SOUTHBOUND I-75


CUMULETARY W. BIGGS-NEIGH-PUNTA'S, XS-A5 SPOOLED BY WEBSTER ON 26 NOV 1991 AT 08:52:02

Rdwy. Exc.	Fill
A	A
V	V

RECEIVED
Southwest Florida Water
Management District
DEC 09 1991
PRD-VENICE

SURVEY "A"

L.A. R/W LINE

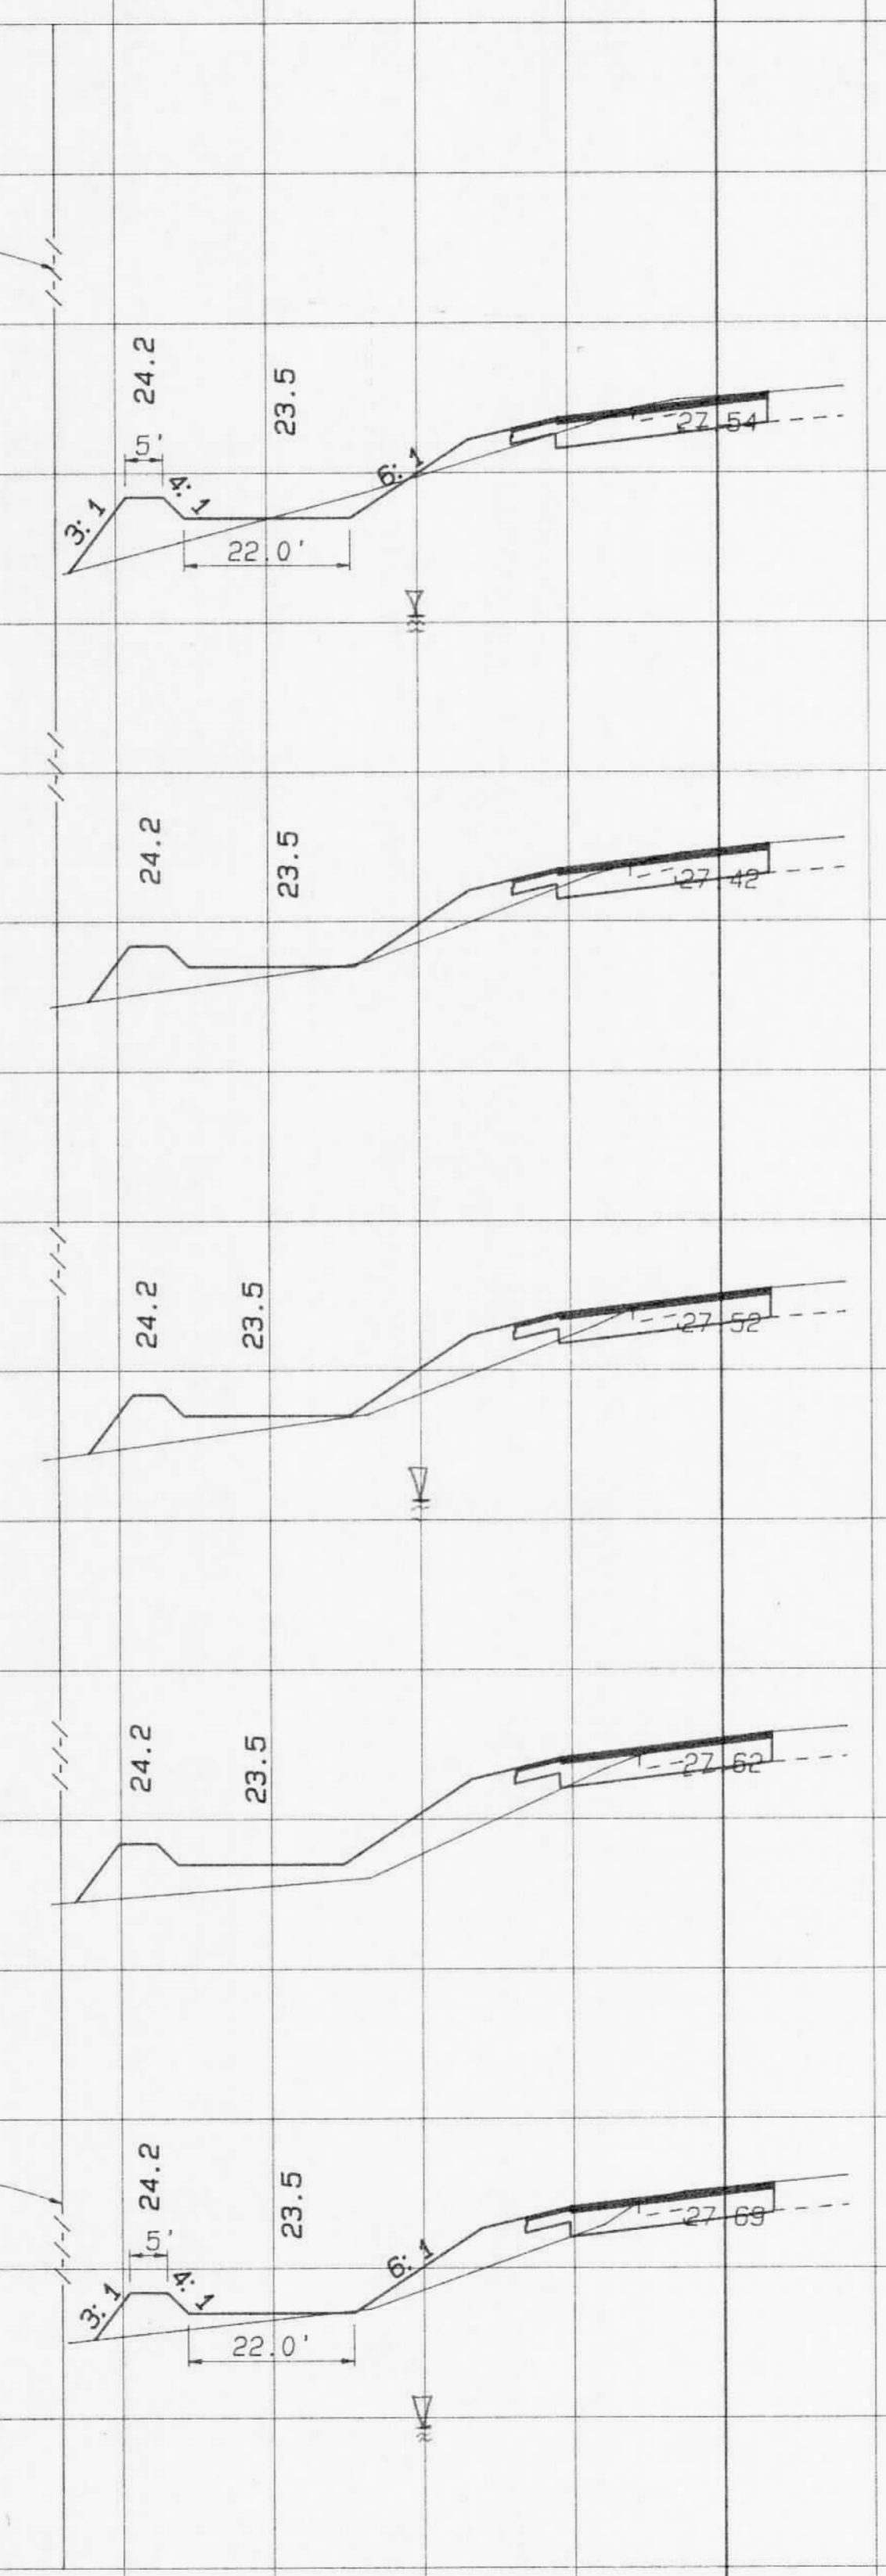

24+00.00 B "A"

23+00.00 B "A"

22+00.00 B "A"

21+00.00 B "A"

PERMITTEE SHALL NOTIFY IN WRITING
THE VENICE PERMITTING DEPARTMENT,
SOUTHWEST FLORIDA WATER MANAGEMENT
DISTRICT, WHEN CONSTRUCTION BEGINS.

20+00.00 B "A"

SOUTHWEST FLORIDA WATER
MANAGEMENT DISTRICT
PERMITTED CONSTRUCTION

[Signature]

Imaged As is

SCALE: 1" = 20' HORIZ.
1" = 5' VERT.

FILE OF RECORD
PERMIT NO. 409592-00

REVISIONS

DATE	BY	DESCRIPTION	DATE	BY	DESCRIPTION

XS-AB	NAME	DATE	NAME	DATE
DESIGNED BY	L.P. CLEGG	8-91	DRAWN BY	S.W./A.C.
CHECKED BY	W.F. BIGGS	8-91	CHECKED BY	L.P. CLEGG
SUPERVISED BY	WILLIAM F. BIGGS, P.E.			

FLORIDA DEPARTMENT OF TRANSPORTATION
APPROVED BY
[Signature]
DATE 12/6/91


Boyle Engineering Corporation
of Florida
5912-A Breckenridge Parkway, Tampa, FL 33610-4251 813/621-7800

CROSS SECTIONS
SOUTHBOUND I-75

C:\JUMBLE\TASK\M.BIGGS\WEIGH\PUNTA\S.XS-AB SPOOLED BY WEBSTER ON 26 NOV 1991 AT 06:53:14

Rdwy.	Exc...	Fill
A	V	A
		V

RECEIVED
Southwest Florida Water
Management District
DEC 09 1991
RRD - VENICE

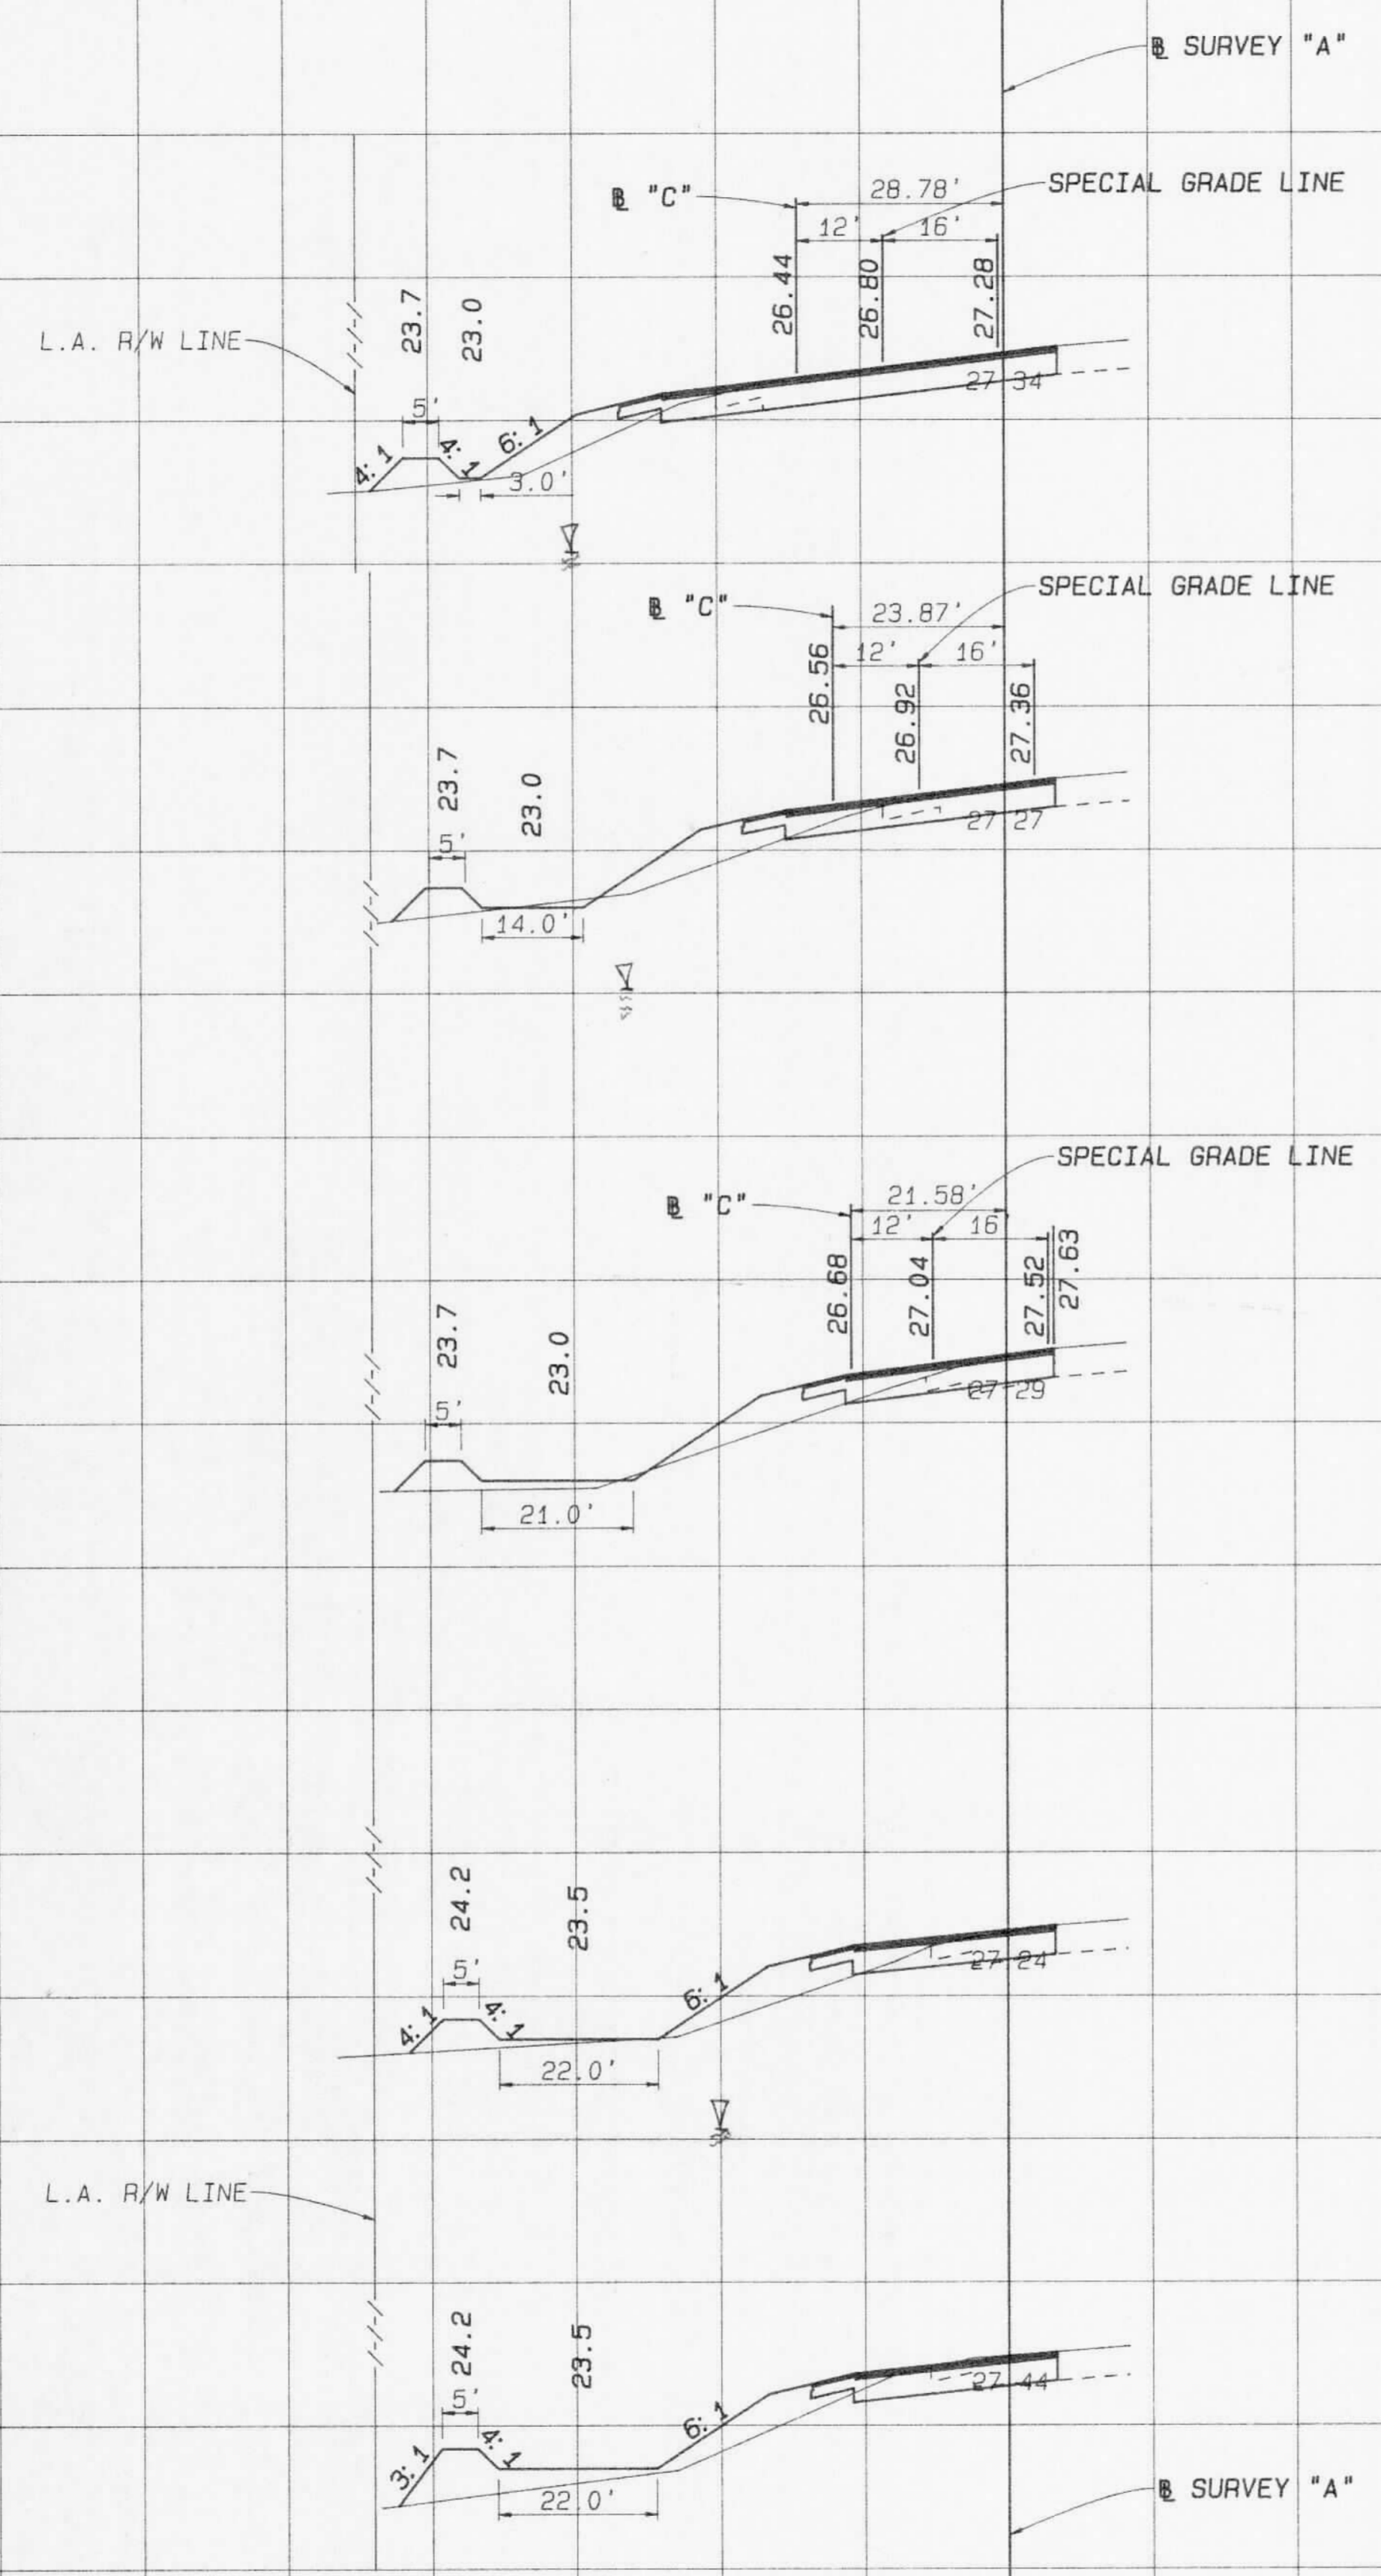

29+00.00 B "A"
112+37.51 B "C"

28+00.00 B "A"
111+37.39 B "C"

27+00.00 B "A"
110+37.36 B "C"

110+00.00 B "C" AH =
26+62.64 B "A" BK

26+00.00

PERMITTEE SHALL NOTIFY IN WRITING
THE VENICE PERMITTING DEPARTMENT,
SOUTHWEST FLORIDA WATER MANAGEMENT
DISTRICT, WHEN CONSTRUCTION BEGINS.

25+00.00

SOUTHWEST FLORIDA WATER
MANAGEMENT DISTRICT
PERMITTED CONSTRUCTION

Imaged As Is

SCALE: 1" = 20' HORIZ.
1" = 5' VERT.

FILE OF RECORD
PERMIT NO. 409592.00

REVISIONS							
DATE	BY	DESCRIPTION	DATE	BY	DESCRIPTION	DATE	BY

DESIGNED BY	L.P. CLEGG	8-91	DRAWN BY	S.W./A.C.	8-91
CHECKED BY	W.F. BIGGS	8-91	CHECKED BY	L.P. CLEGG	8-91
SUPERVISED BY	WILLIAM F. BIGGS, P.E.				

FLORIDA DEPARTMENT OF TRANSPORTATION
APPROVED BY
DATE 12/6/91


Boyle Engineering Corporation
of Florida
1912-A Breckenridge Parkway, Tampa, FL 33610-4255 813/921-7900

**CROSS SECTIONS
SOUTHBOUND I-75**

C:\JUMBLE>TASK\M.BIGGS\WEIGH\PUNTA\S.XS-A7 SPOOLED BY REGISTER ON 26 NOV 1991 AT 08:54:27

Rdwy.	Exc.	F111
A	V	A
		V

RECEIVED
Southwest Florida Water Management District
DEC 09 1991
PRD - VENICE

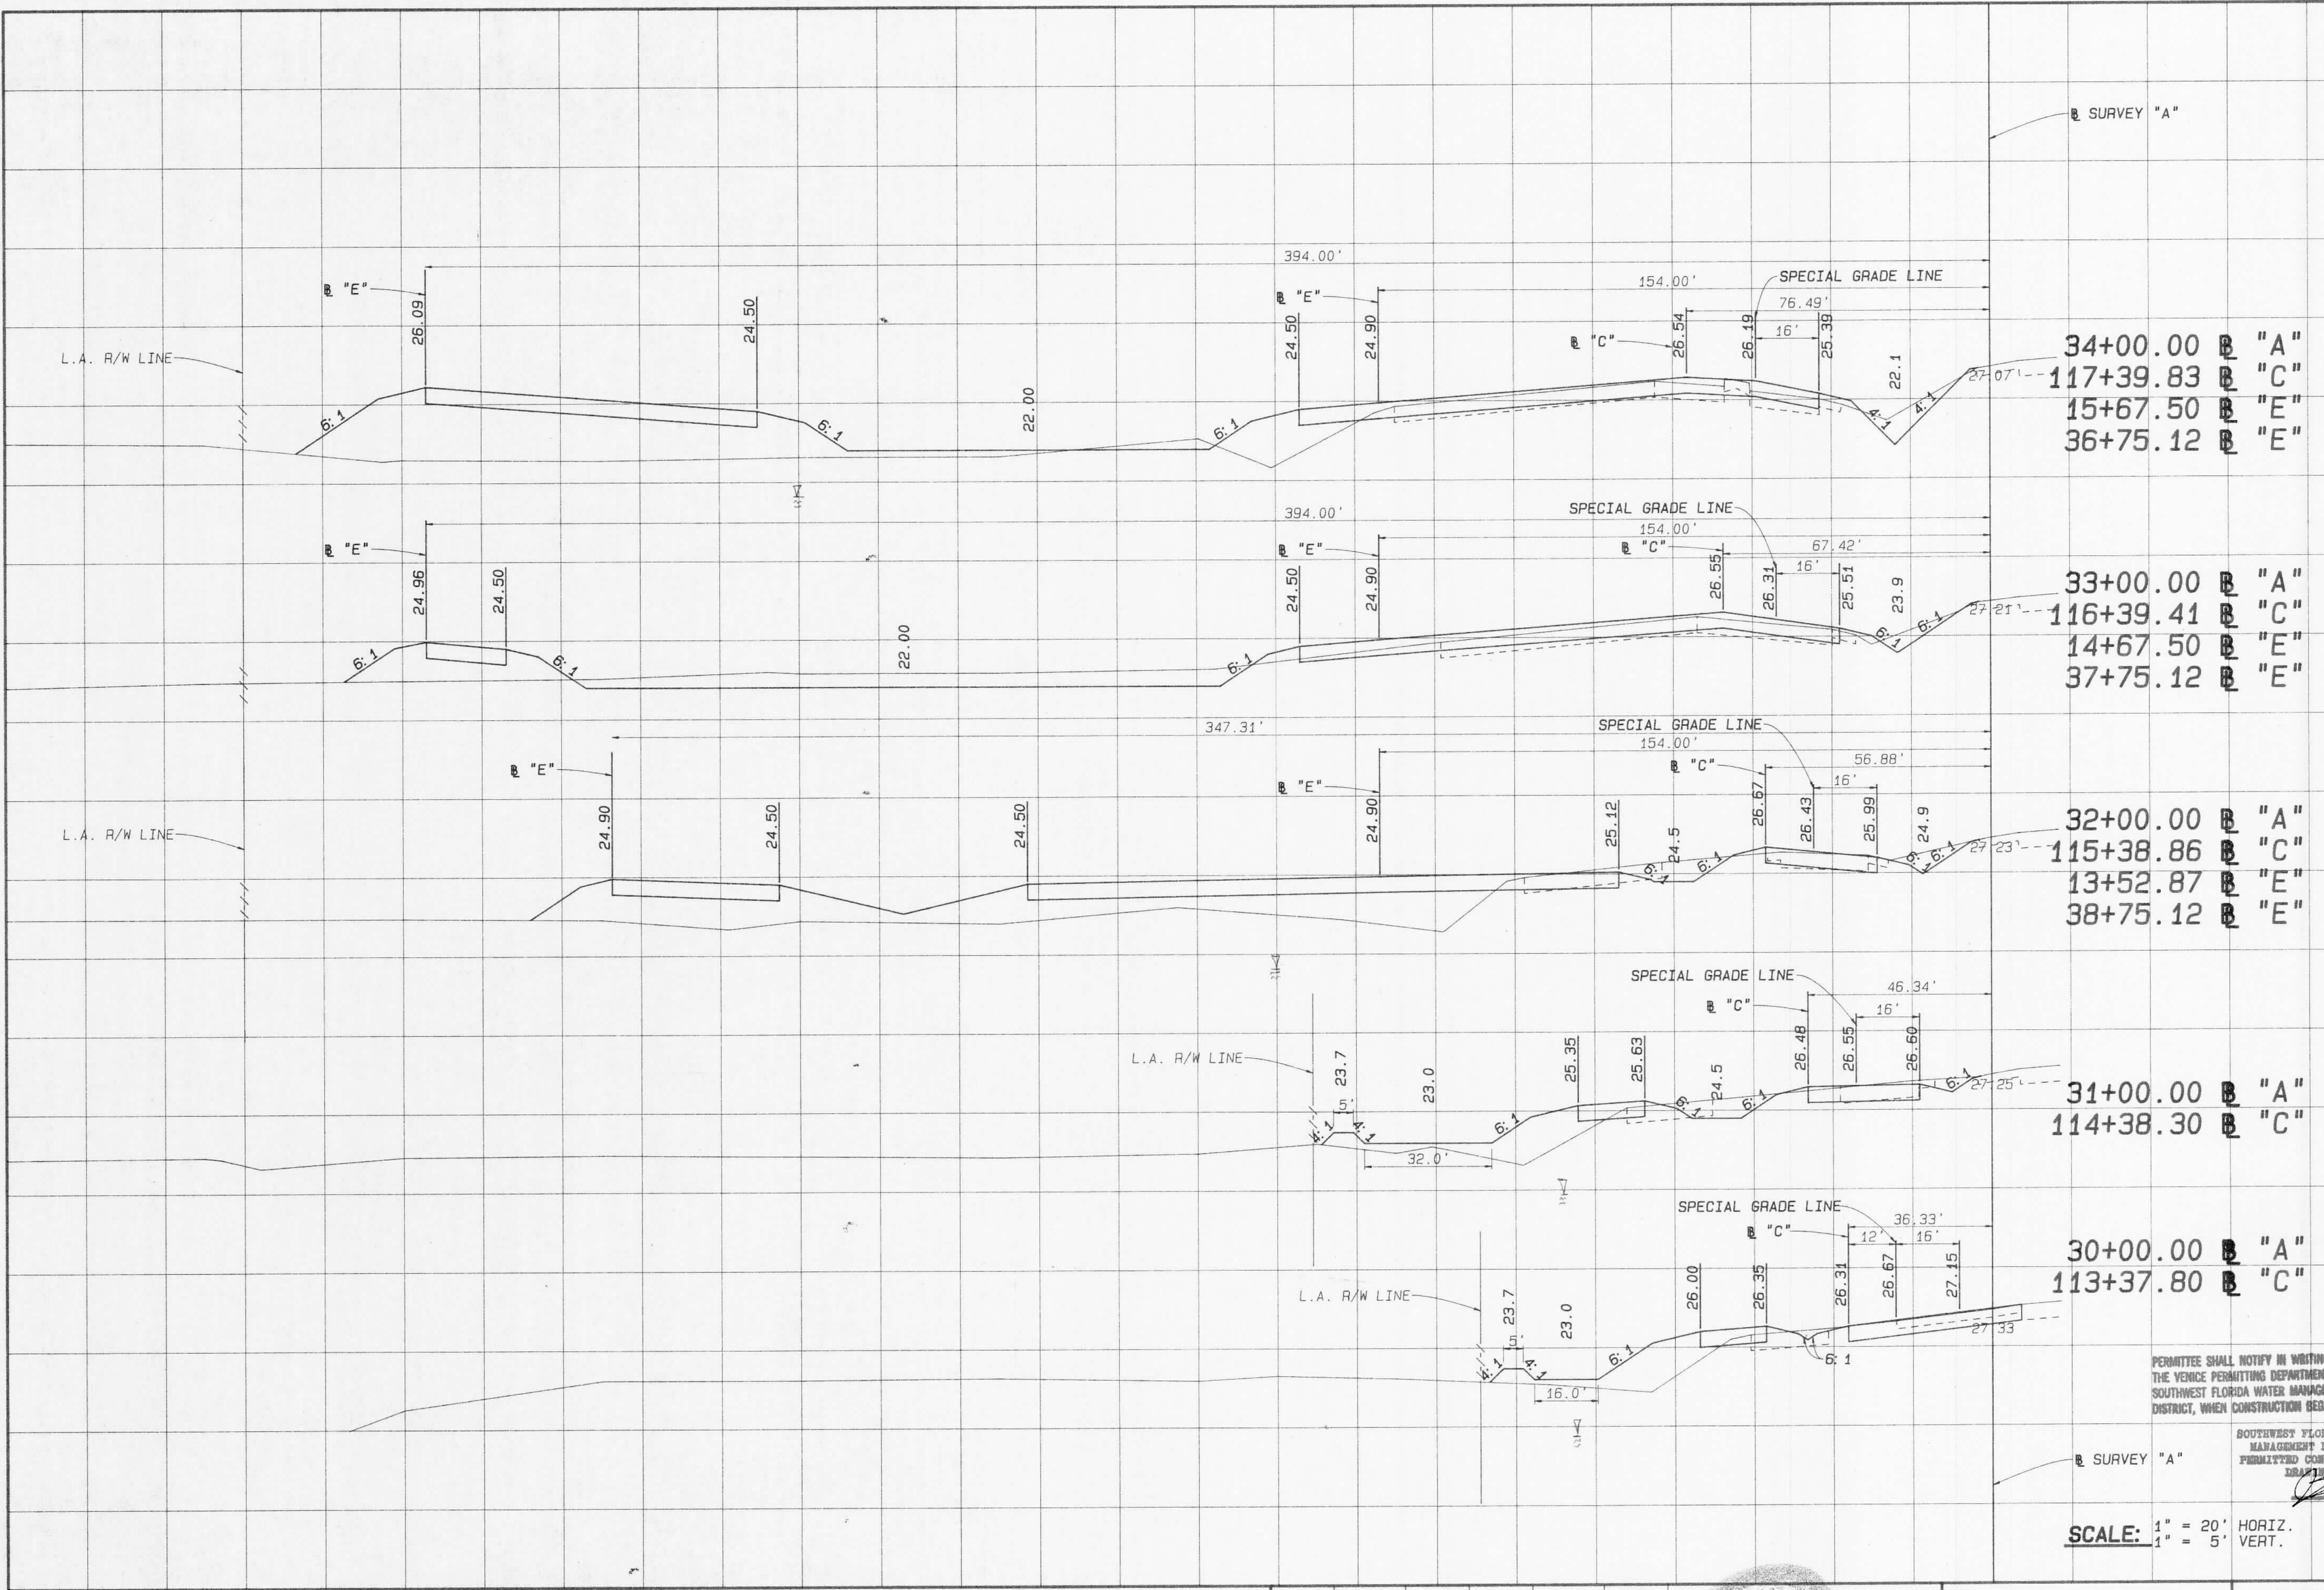

34+00.00 "A"
117+39.83 "C"
15+67.50 "E"
36+75.12 "E"

33+00.00 "A"
116+39.41 "C"
14+67.50 "E"
37+75.12 "E"

32+00.00 "A"
115+38.86 "C"
13+52.87 "E"
38+75.12 "E"

31+00.00 "A"
114+38.30 "C"

30+00.00 "A"
113+37.80 "C"

PERMITEE SHALL NOTIFY IN WRITING THE VENICE PERMITTING DEPARTMENT, SOUTHWEST FLORIDA WATER MANAGEMENT DISTRICT, WHEN CONSTRUCTION BEGINS.

SOUTHWEST FLORIDA WATER MANAGEMENT DISTRICT
PERMITTED CONSTRUCTION
DRAWING

SCALE: 1" = 20' HORIZ.
1" = 5' VERT.

FILE OF RECORD
PERMIT NO. 409592.00

REVISIONS							
DATE	BY	DESCRIPTION	DATE	BY	DESCRIPTION	DATE	BY

DESIGNED BY	L.P. CLEGG	DATE	8-91	DRAWN BY	S.W./A.C.	DATE	8-91
CHECKED BY	W.F. BIGGS	DATE	8-91	CHECKED BY	L.P. CLEGG	DATE	8-91
SUPERVISED BY	WILLIAM F. BIGGS, P.E.						

FLORIDA DEPARTMENT OF TRANSPORTATION
APPROVED BY: [Signature]
DATE: 12/6/91

Boje Engineering Corporation of Florida
5915-A Breckridge Parkway, Tampa, FL 33610-4251 813/921-7900


**CROSS SECTIONS
SOUTHBOUND I-75**

409592 - 00

C:\JUMBLE>TASK\M-BIGGS\WEIGH-PRINT\A\S-XS-AB SPOOLED BY WEBSTER ON 26 NOV 1991 AT 08:55:24

Rdwy.	Exc.	Fill
A	V	A
		V

RECEIVED
 South Florida Water
 Management District
 DEC 09 1991
 RDW - VENICE

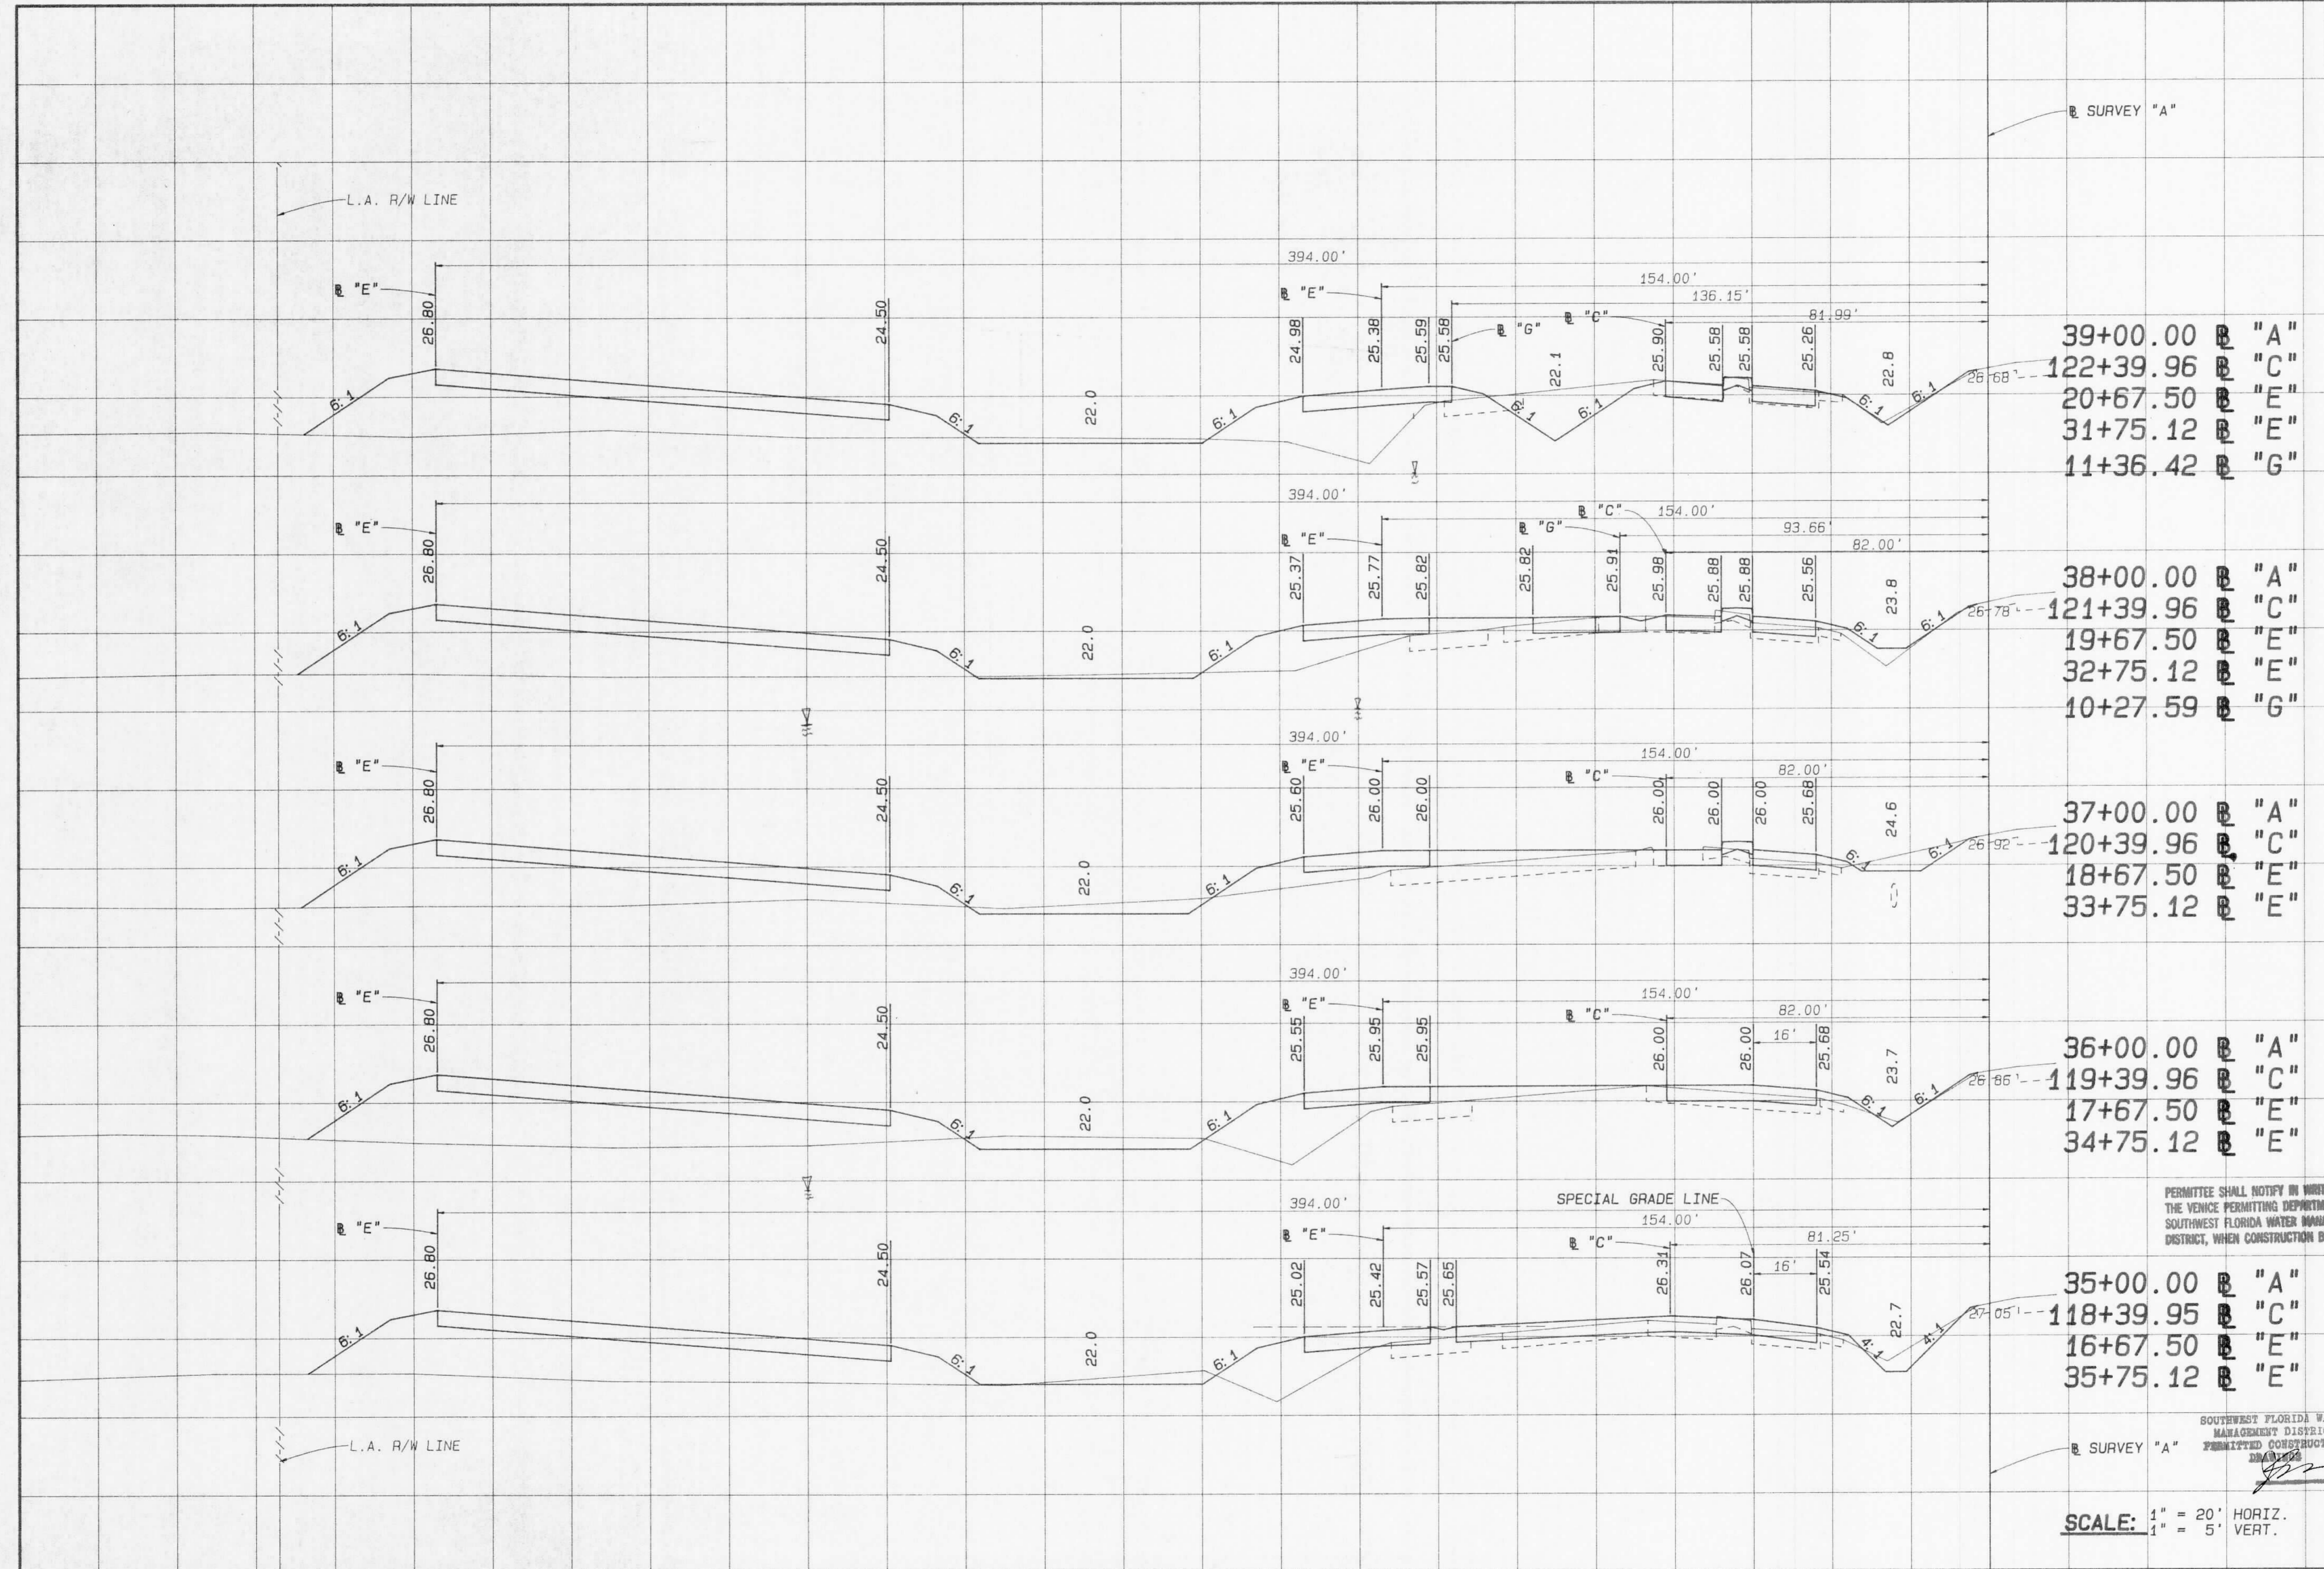

39+00.00 "A"
 122+39.96 "C"
 20+67.50 "E"
 31+75.12 "E"
 11+36.42 "G"

38+00.00 "A"
 121+39.96 "C"
 19+67.50 "E"
 32+75.12 "E"
 10+27.59 "G"

37+00.00 "A"
 120+39.96 "C"
 18+67.50 "E"
 33+75.12 "E"

36+00.00 "A"
 119+39.96 "C"
 17+67.50 "E"
 34+75.12 "E"

35+00.00 "A"
 118+39.95 "C"
 16+67.50 "E"
 35+75.12 "E"

PERMITTEE SHALL NOTIFY IN WRITING THE VENICE PERMITTING DEPARTMENT, SOUTHWEST FLORIDA WATER MANAGEMENT DISTRICT, WHEN CONSTRUCTION BEGINS.

SOUTHWEST FLORIDA WATER MANAGEMENT DISTRICT
 PERMITTED CONSTRUCTION
 DISTRICT

SCALE: 1" = 20' HORIZ.
 1" = 5' VERT.

FILE OF RECORD
 PERMIT NO. 409592-00

Imaged As Is

REVISIONS											
DATE	BY	DESCRIPTION	DATE	BY	DESCRIPTION	DATE	BY	DESCRIPTION	DATE	BY	DESCRIPTION

XS-A9	NAME	DATE	NAME	DATE
DESIGNED BY	L. P. CLEGG	7-91	DRAWN BY	S. M. /A. C.
CHECKED BY	W. F. BIGGS	7-91	CHECKED BY	L. P. CLEGG
SUPERVISED BY	WILLIAM F. BIGGS, P. E.			


FLORIDA DEPARTMENT OF TRANSPORTATION
 APPROVED BY
 DATE 12/6/91

Boyle Engineering Corporation
 of Florida
 5912-N Breckridge Parkway, Tampa, FL 33610-4201 813/621-7900

CROSS SECTIONS
 SOUTHBOUND I-75

<JUNBLE>TASKM<BIGGS>WEIGH>PUNTA>S<XS-A9>SPOOLED BY COE ON 05 SEP 1991 AT 11:55:35

RECEIVED
Southwest Florida
Water Management District
DEC 08 1991
RDW-VEHICLE

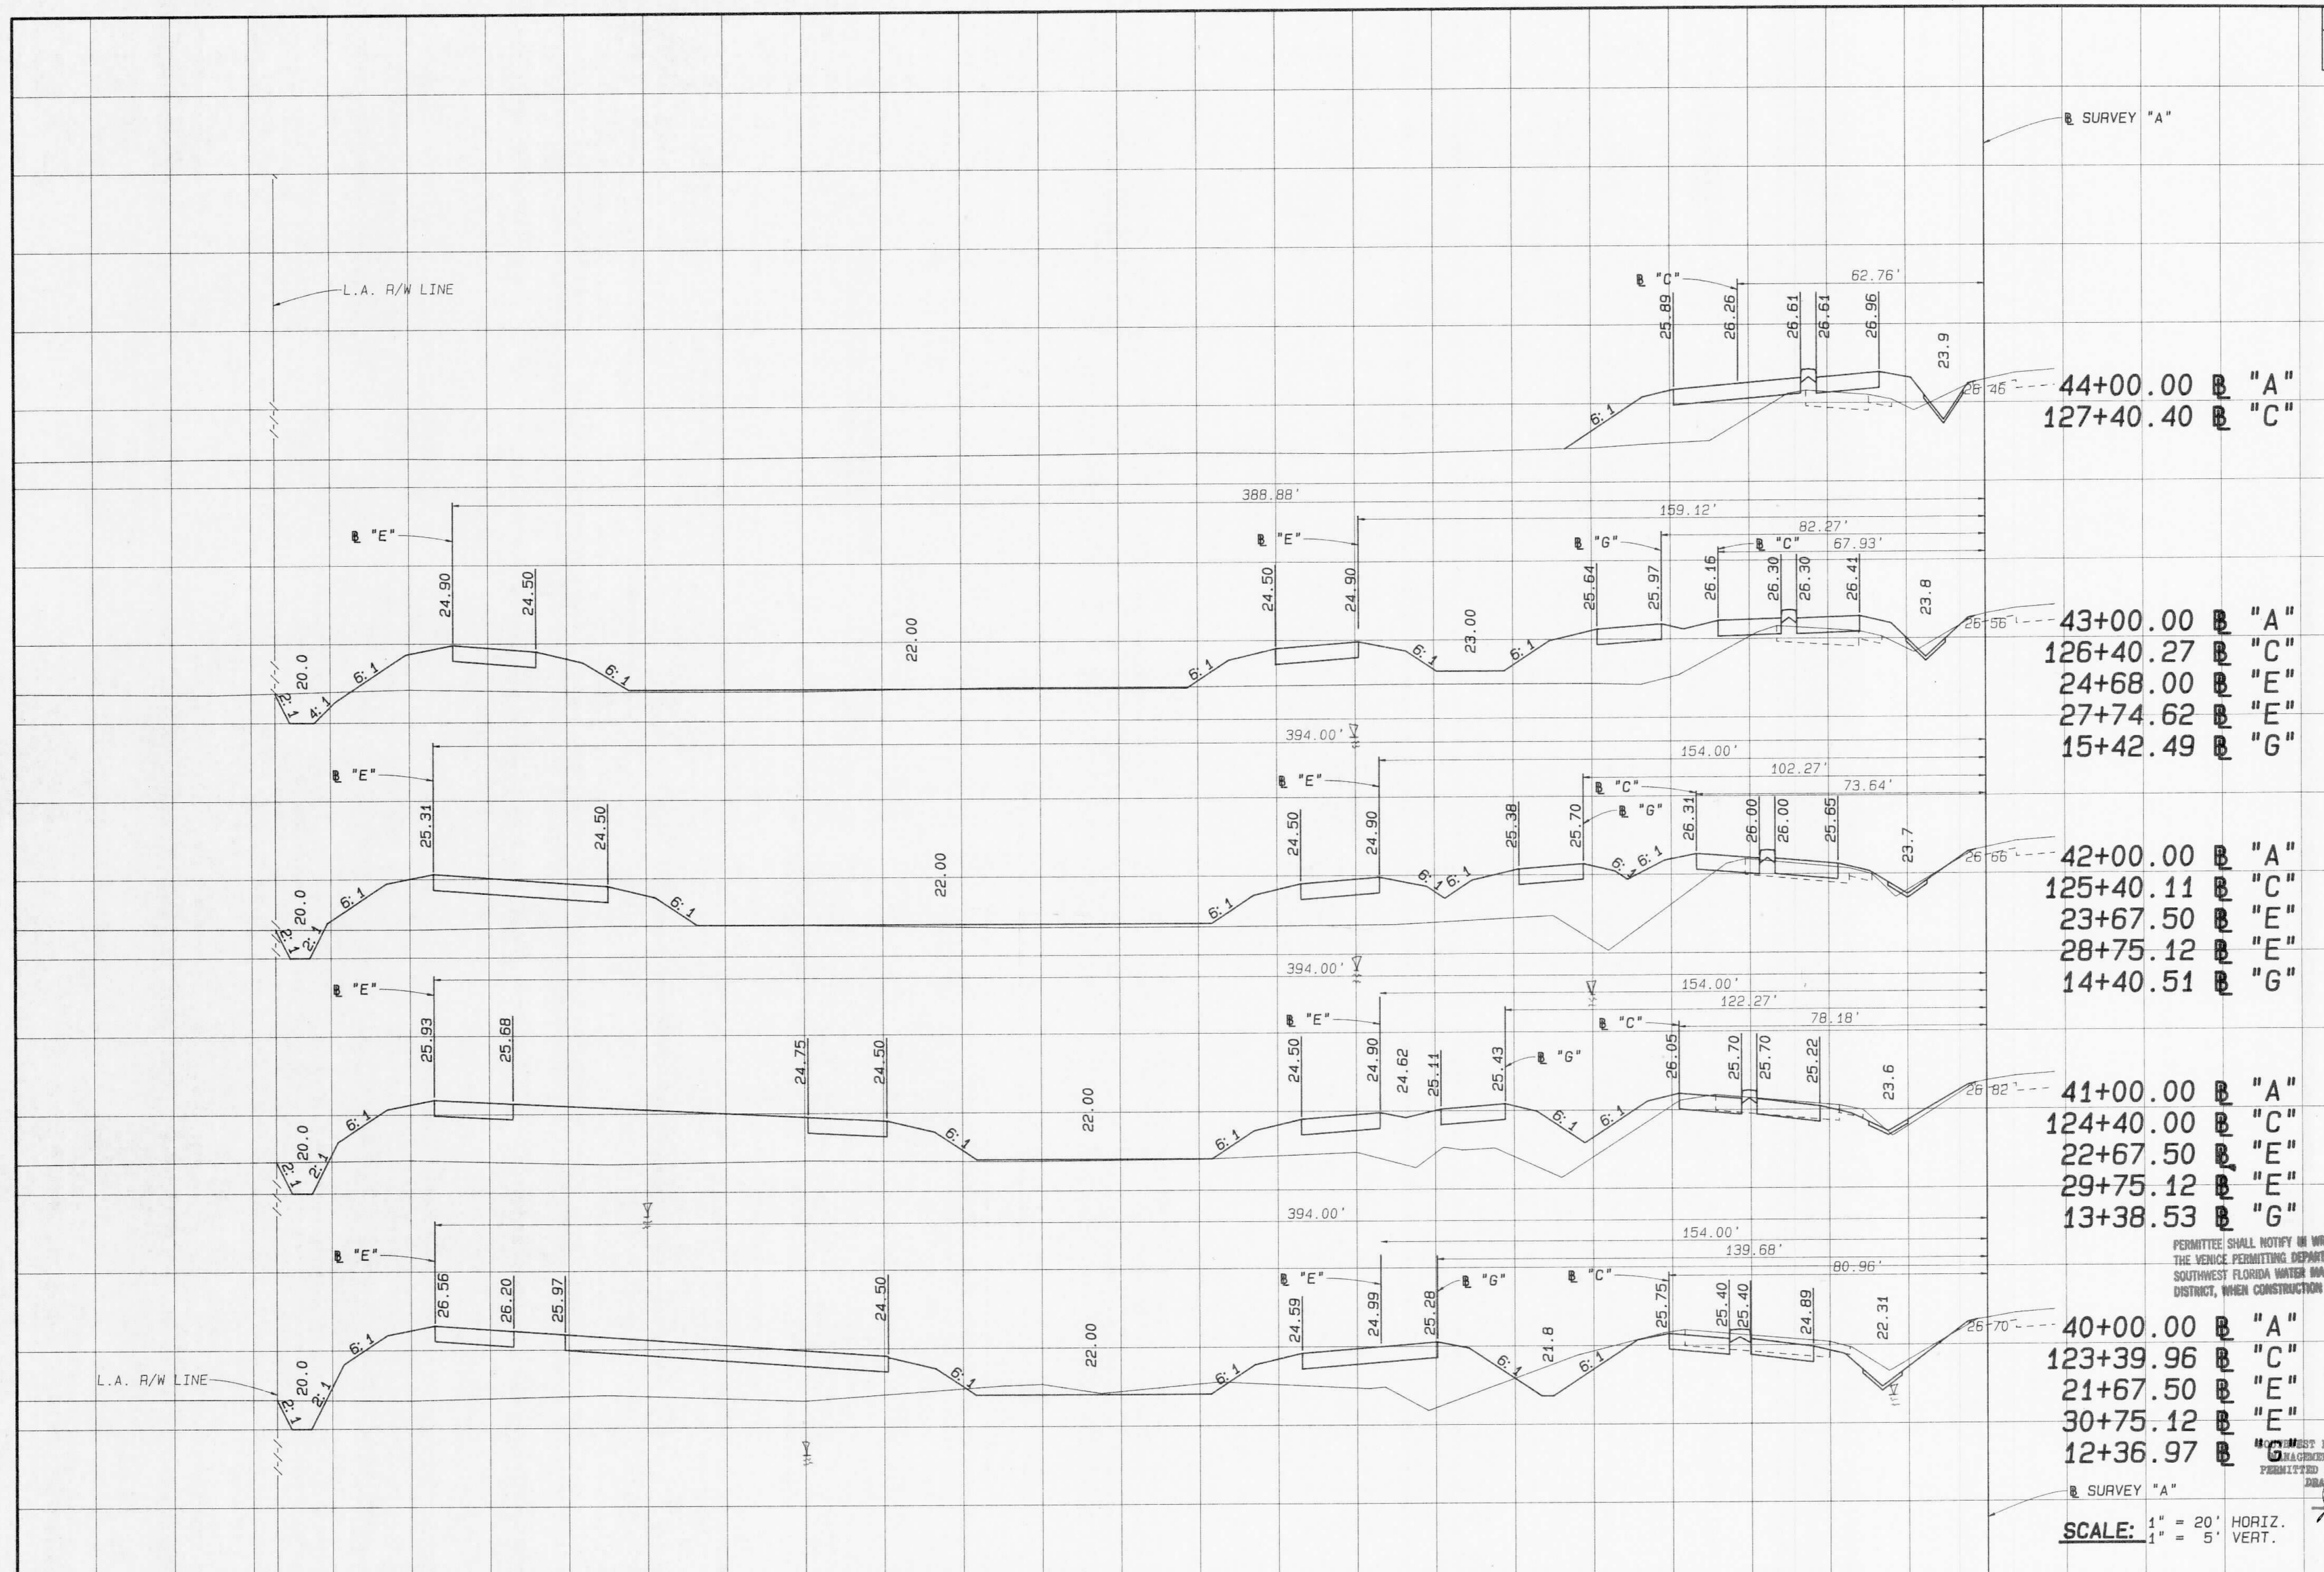

44+00.00 "A"
127+40.40 "C"

43+00.00 "A"
126+40.27 "C"
24+68.00 "E"
27+74.62 "E"
15+42.49 "G"

42+00.00 "A"
125+40.11 "C"
23+67.50 "E"
28+75.12 "E"
14+40.51 "G"

41+00.00 "A"
124+40.00 "C"
22+67.50 "E"
29+75.12 "E"
13+38.53 "G"

40+00.00 "A"
123+39.96 "C"
21+67.50 "E"
30+75.12 "E"
12+36.97 "G"

PERMITTEE SHALL NOTIFY IN WRITING THE VEHICLE PERMITTING DEPARTMENT, SOUTHWEST FLORIDA WATER MANAGEMENT DISTRICT, WHEN CONSTRUCTION BEGINS.

FILE OF RECORD PERMIT NO. 409592.00

SOUTHWEST FLORIDA WATER MANAGEMENT DISTRICT PERMITTED CONSTRUCTION DRAWING

SCALE: 1" = 20' HORIZ.
1" = 5' VERT.

Imaged As Is

REVISIONS			
DATE	BY	DESCRIPTION	

XS-A10	NAME	DATE	NAME	DATE
DESIGNED BY	L. P. CLEGG	7-91	DRAWN BY	S. W. / A. C.
CHECKED BY	W. F. BIGGS	7-91	CHECKED BY	L. P. CLEGG
SUPERVISED BY	WILLIAM F. BIGGS, P. E.			


FLORIDA DEPARTMENT OF TRANSPORTATION
APPROVED BY
[Signature]
DATE: 10/16/91

Boyle Engineering Corporation of Florida
5912-A Brackenridge Parkway, Tampa, FL 33610-4251 813/821-7900

CROSS SECTIONS
SOUTHBOUND I-75

Rdwy.	Exc.	Fill
A	V	A
		V

RECEIVED
Southwest Florida Water
Management District
DEC 09 1991
RDW - VENICE

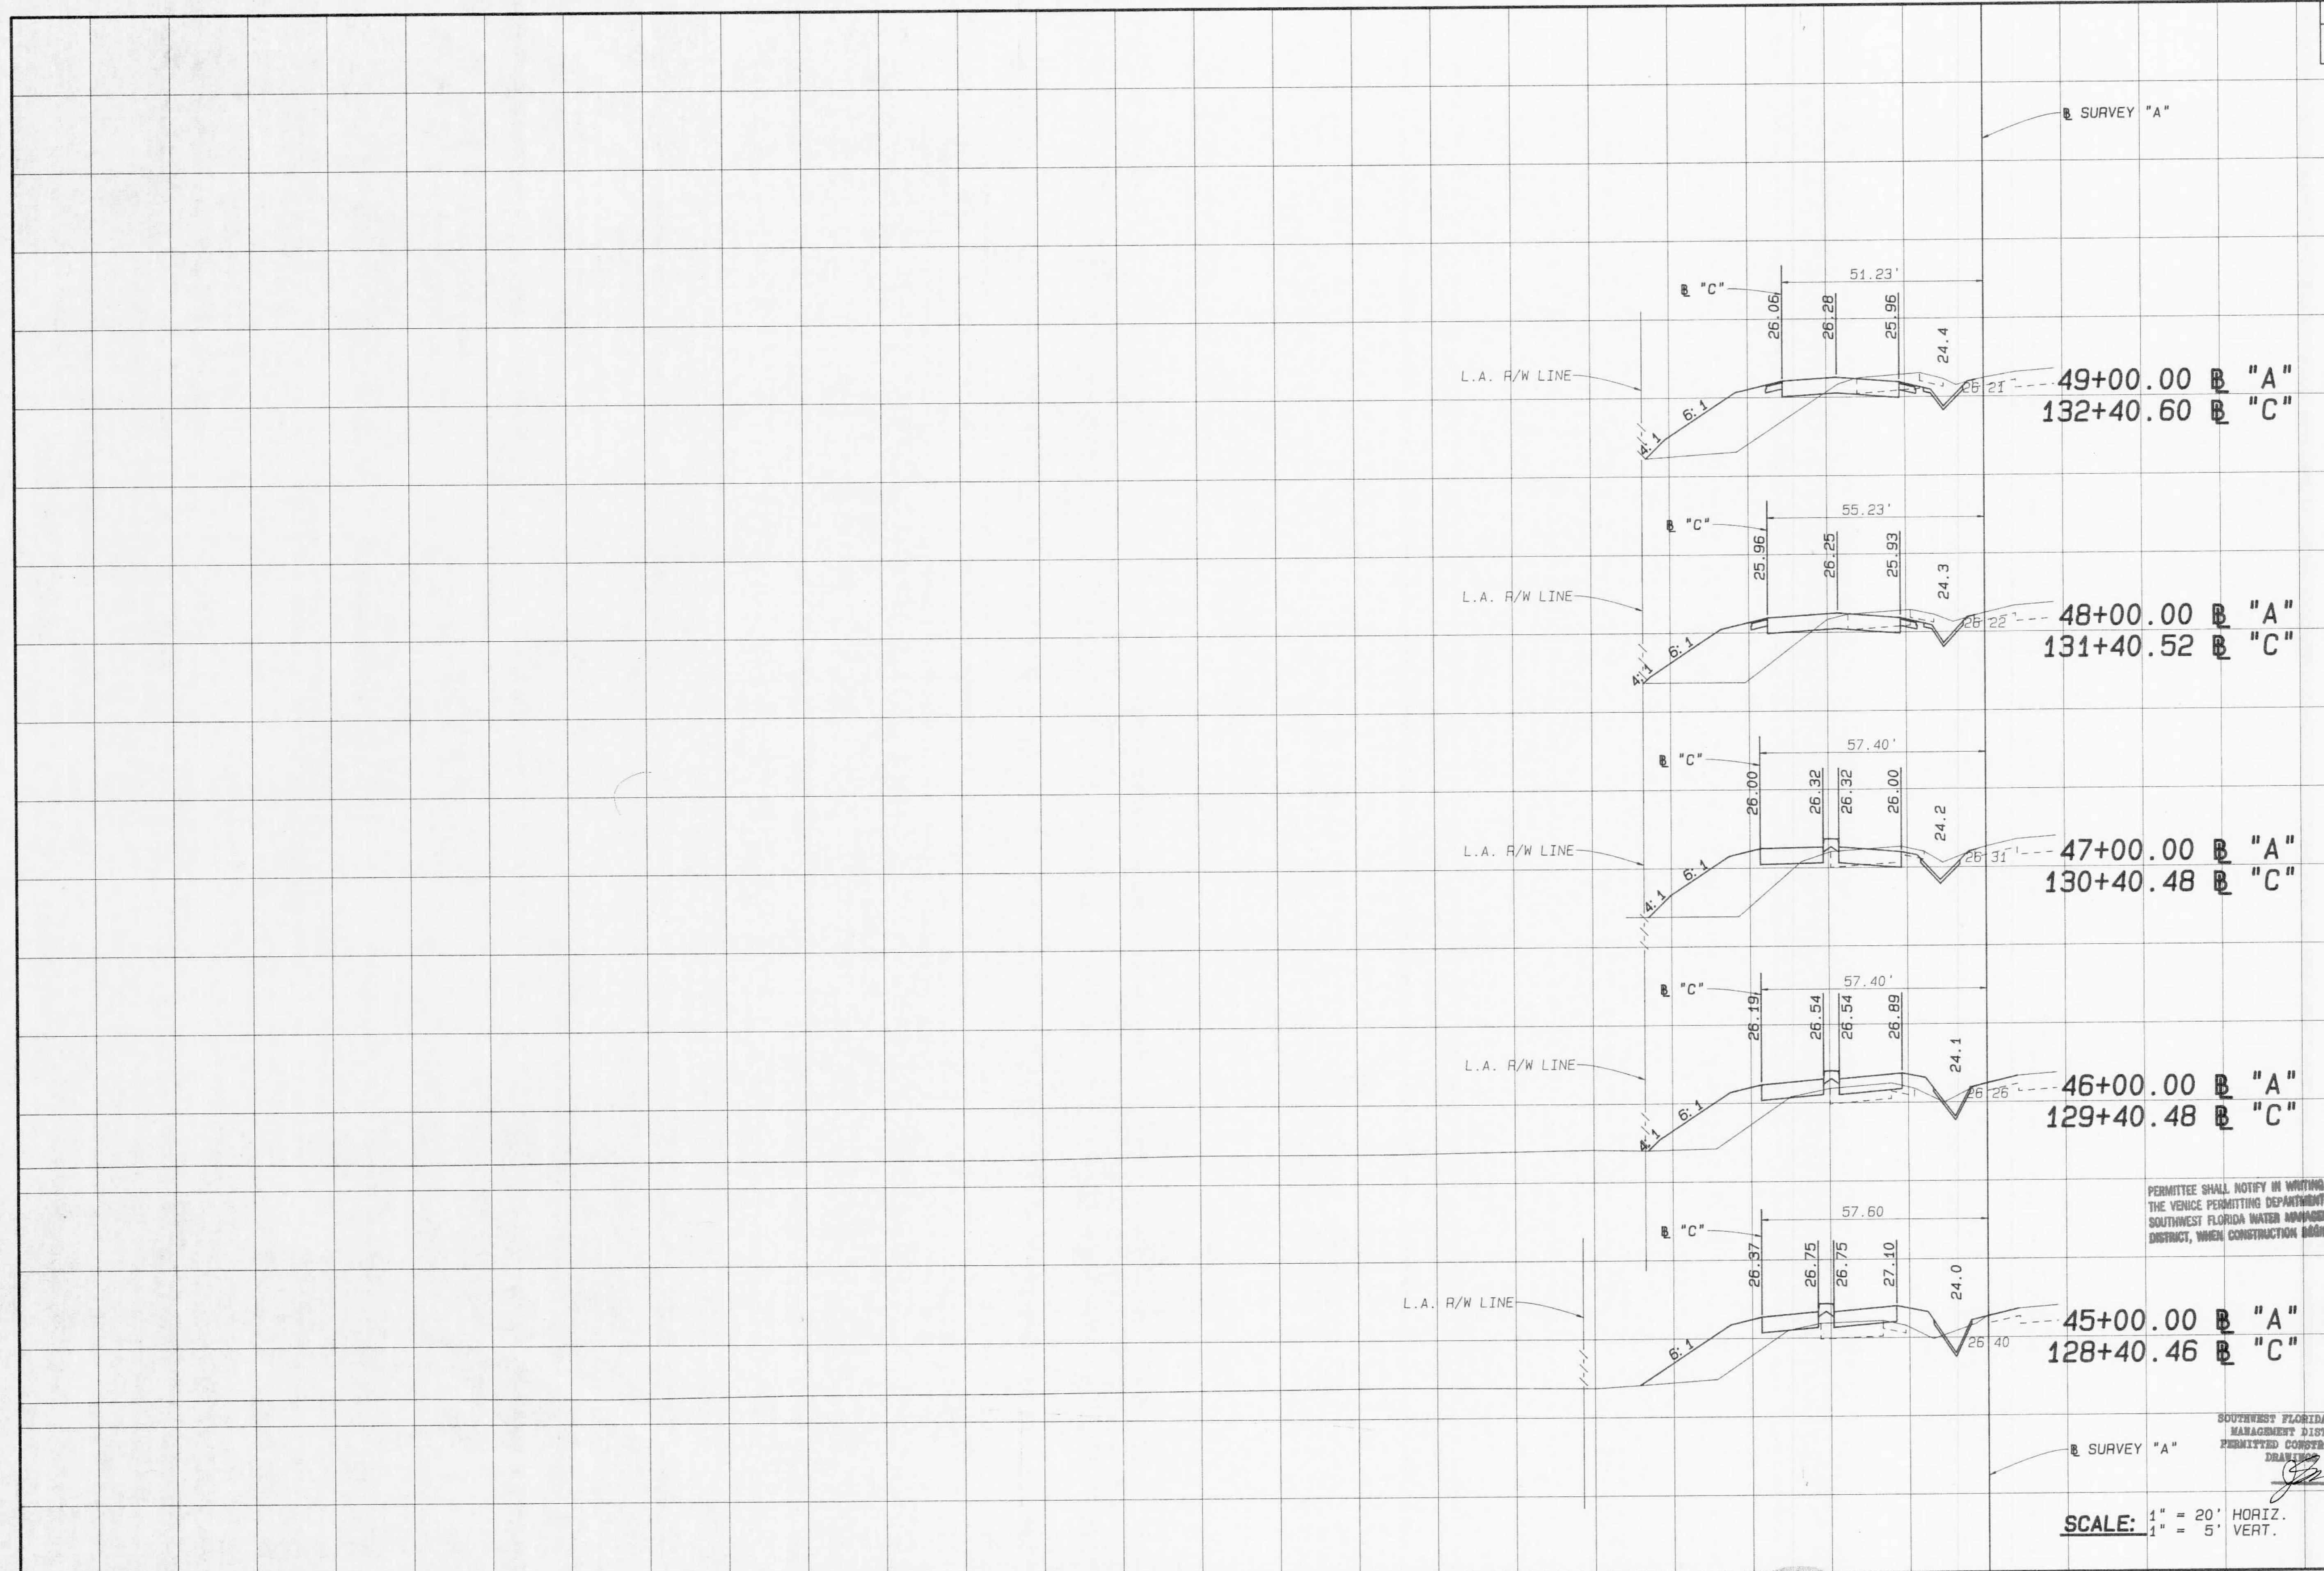

PERMITTEE SHALL NOTIFY IN WRITING THE VENICE PERMITTING DEPARTMENT, SOUTHWEST FLORIDA WATER MANAGEMENT DISTRICT, WHEN CONSTRUCTION BEGINS.

FILE OF RECORD PERMIT NO. 409592.00

SOUTHWEST FLORIDA WATER MANAGEMENT DISTRICT PERMITTED CONSTRUCTION DRAWING

SCALE: 1" = 20' HORIZ. 1" = 5' VERT.

Imaged As Is

REVISIONS							
DATE	BY	DESCRIPTION	DATE	BY	DESCRIPTION	DATE	BY

DESIGNED BY	L.P. CLEGG	DATE	8-91	DRAWN BY	S.W./A.C.	DATE	8-91
CHECKED BY	W.F. BIGGS	DATE	8-91	CHECKED BY	L.P. CLEGG	DATE	8-91
SUPERVISED BY WILLIAM F. BIGGS, P.E.							


FLORIDA DEPARTMENT OF TRANSPORTATION
 APPROVED BY: *[Signature]* DATE 12/6/91

Boyle Engineering Corporation
 5912-A Breckridge Parkway, Tampa, FL 33610-4251 813/624-7300

CROSS SECTIONS SOUTHBOUND I-75

C:\JUMBLE\TASK\M.BIGGS\WEIGH\PUNTA>8.X8-811 SPOOLED BY CLEGG ON 16 SEP 1991 AT 17:45:36

RECEIVED
Southwest Florida Water Management District
D-C 9 1991
RBD-424...

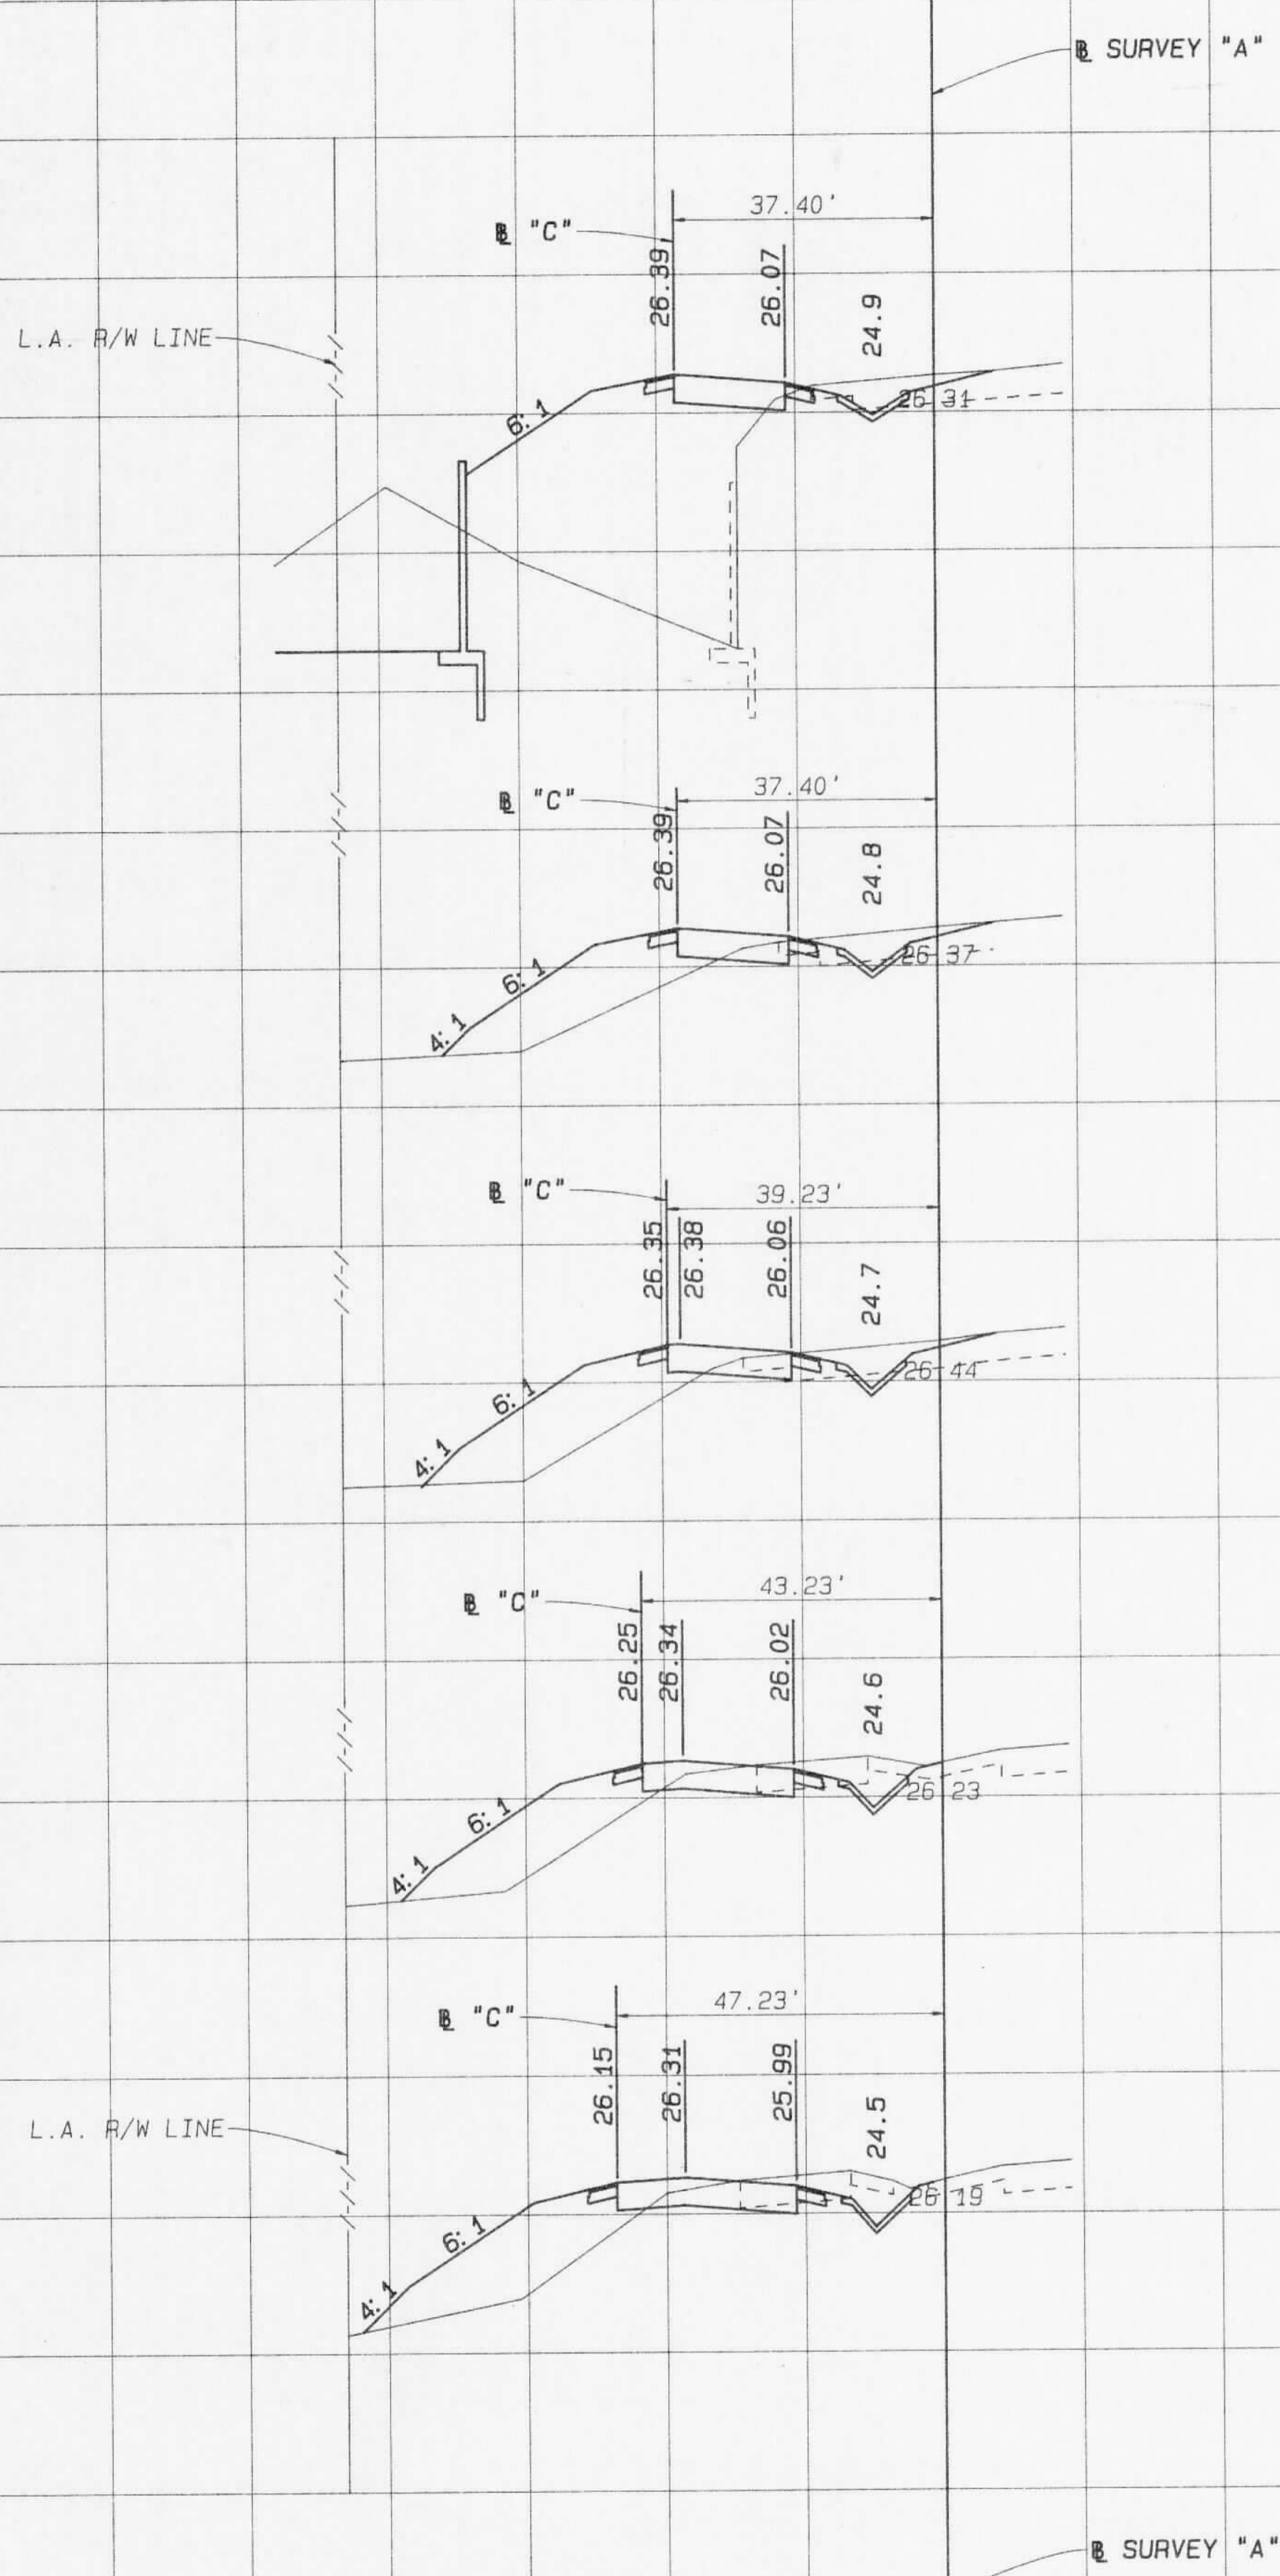

54+00.00 B "A"
137+40.88 B "C"

53+00.00 B "A"
136+40.88 B "C"

52+00.00 B "A"
135+40.84 B "C"

51+00.00 B "A"
134+40.76 B "C"

50+00.00 B "A"
133+40.68 B "C"

PERMITEE SHALL NOTIFY IN WRITING THE VENICE PERMITTING DEPARTMENT, SOUTHWEST FLORIDA WATER MANAGEMENT DISTRICT, WHEN CONSTRUCTION BEGINS.

FILE OF RECORD
PERMIT NO. 09592.00


SOUTHWEST FLORIDA WATER MANAGEMENT DISTRICT
PERMITTED CONSTRUCTION
DRAWING

SCALE: 1" = 20' HORIZ.
1" = 5' VERT.

Imaged As Is

REVISIONS					
DATE	BY	DESCRIPTION	DATE	BY	DESCRIPTION

XS-A12	NAME	DATE	NAME	DATE
DESIGNED BY	L.P. CLEGG	8-91	DRAWN BY	S.W./A.C.
CHECKED BY	W.F. BIGGS	8-91	CHECKED BY	L.P. CLEGG
SUPERVISED BY		WILLIAM F. BIGGS, P.E.		

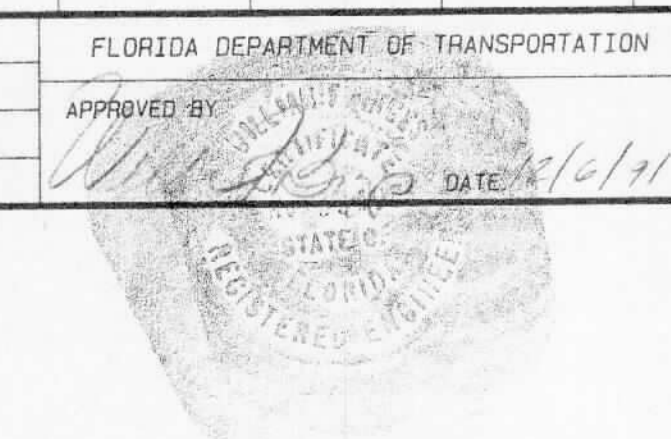


Boule Engineering Corporation of Florida
5910-A Brackenridge Parkway, Tampa, FL 33610-4151 813/921-7000

**CROSS SECTIONS
SOUTHBOUND I-75**

AT 17: 47: 24

Rdwy.	Exc.	Fill
A	V	A
		V

RECEIVED
 Southwest Florida Water
 Management District
 DEC 9 1991
 BRD - VENICE

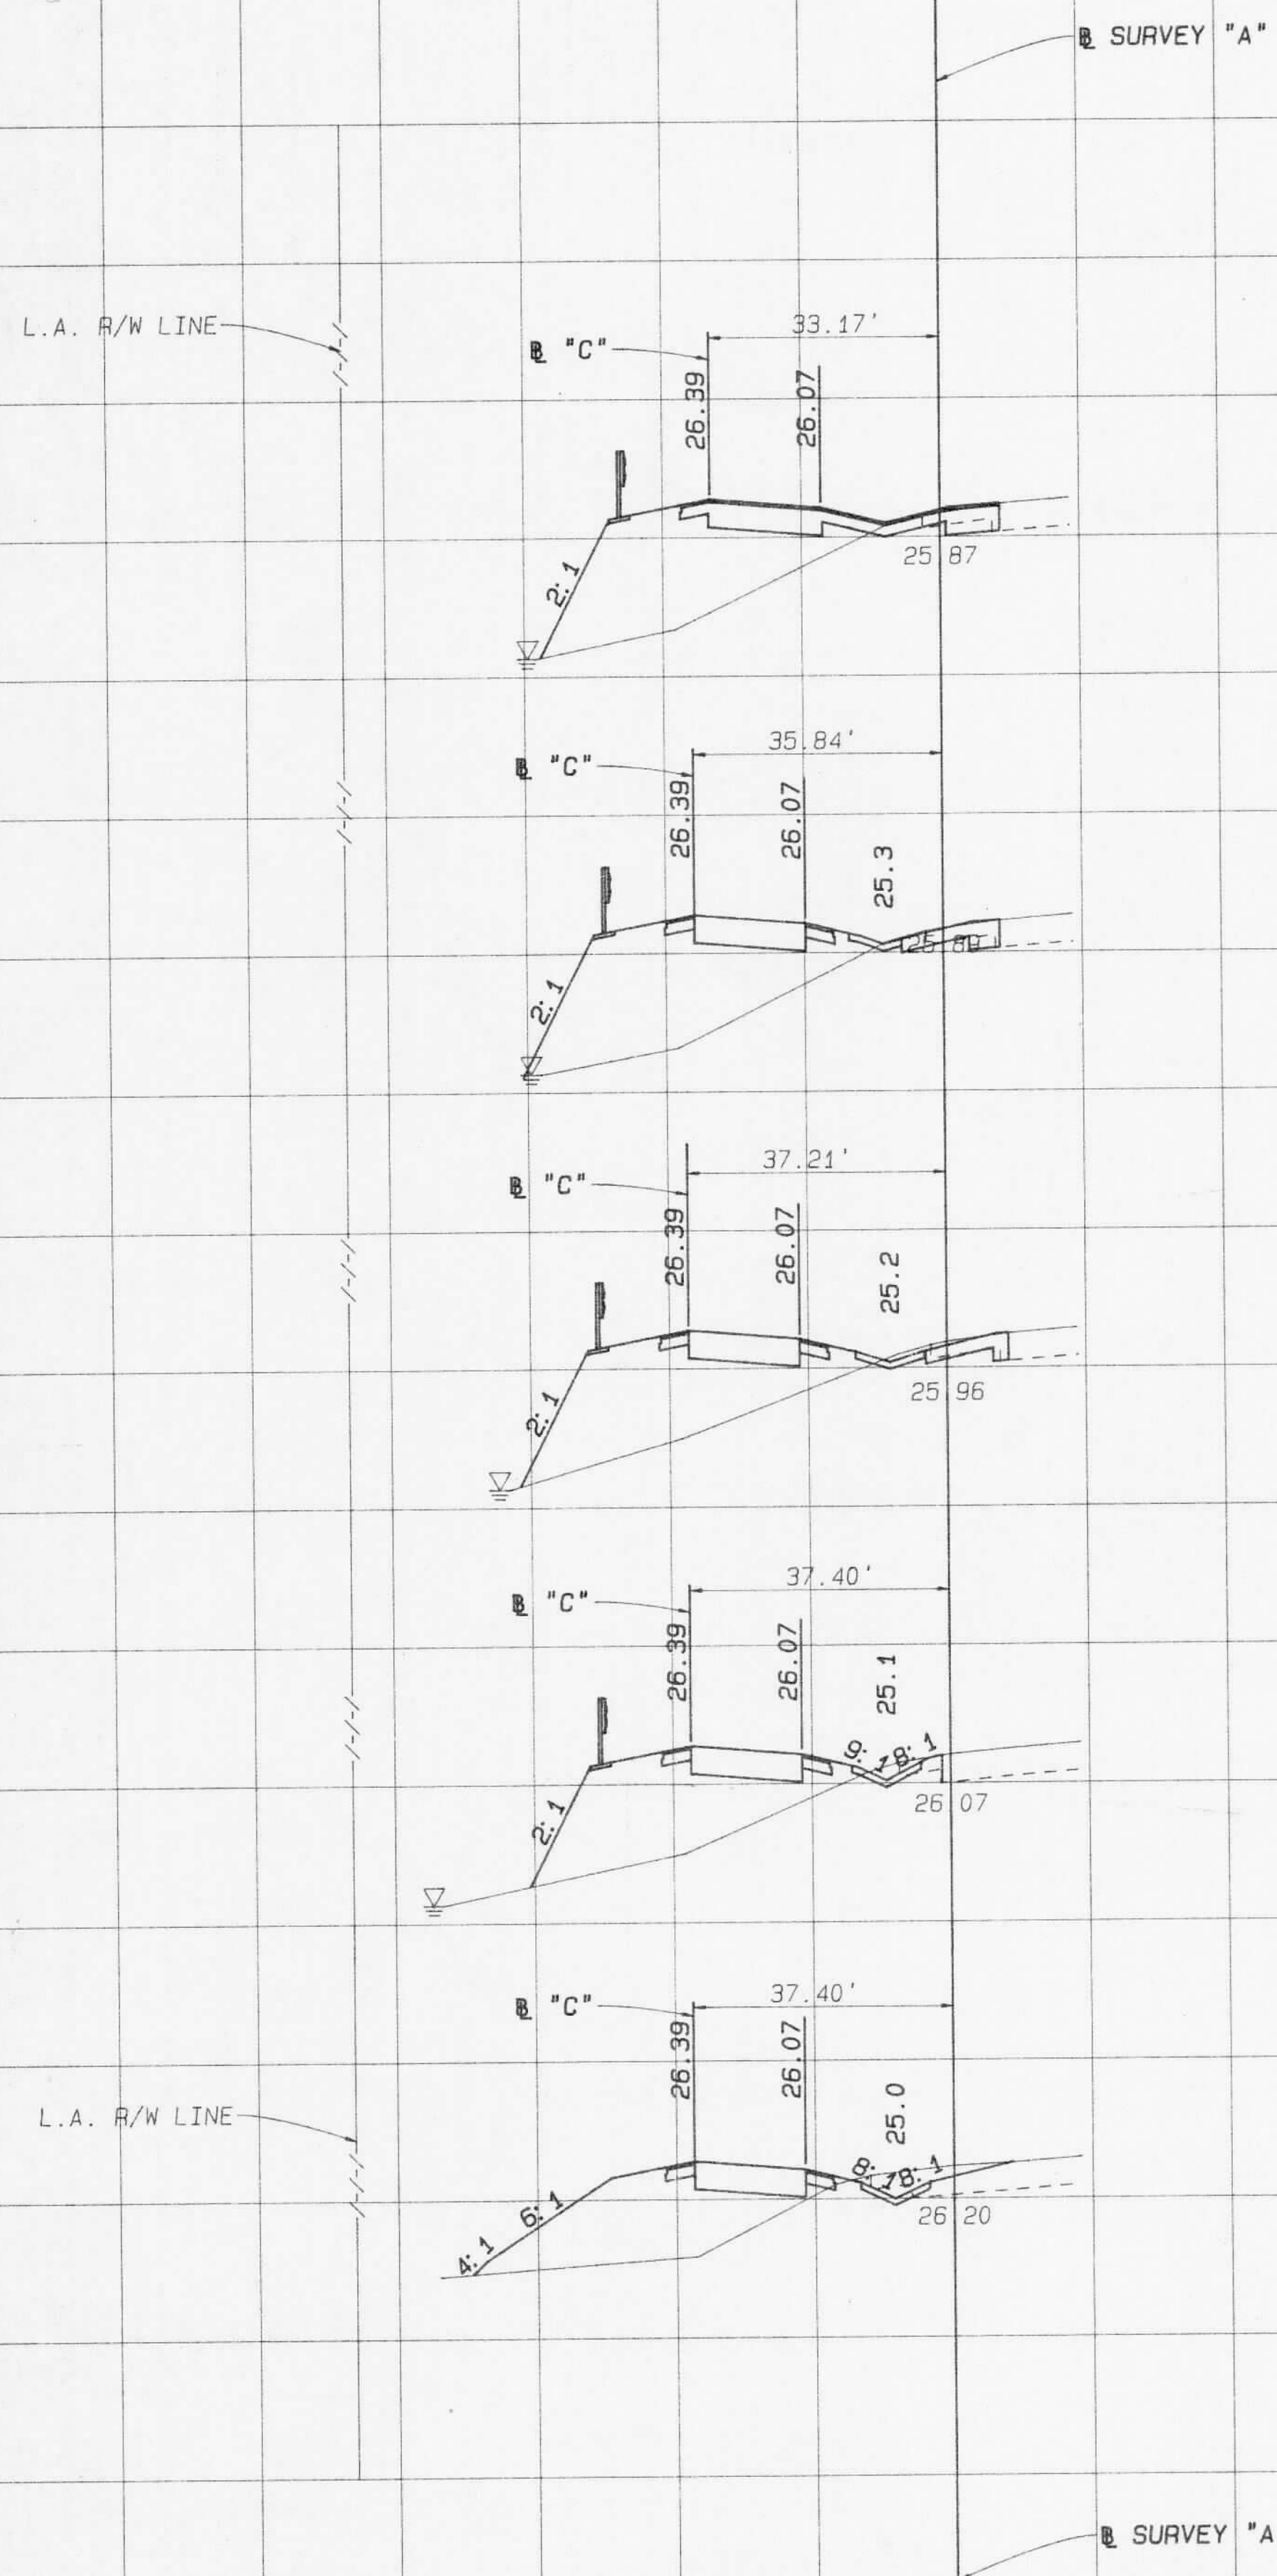

59+00.00 B "A"
 142+40.93 B "C"

58+00.00 B "A"
 141+40.89 B "C"

57+00.00 B "A"
 140+40.88 B "C"

56+00.00 B "A"
 139+40.88 B "C"

55+00.00 B "A"
 138+40.98 B "C"

PERMITTEE SHALL NOTIFY IN WRITING
 THE VENICE PERMITTING DEPARTMENT,
 SOUTHWEST FLORIDA WATER MANAGEMENT
 DISTRICT, WHEN CONSTRUCTION BEGINS.

FILE OF RECORD 409592.00
 PERMIT NO. 409592.00

SOUTHWEST FLORIDA WATER
 MANAGEMENT DISTRICT
 PERMITTED CONSTRUCTION
 DRAWING

SCALE: 1" = 20' HORIZ.
 1" = 5' VERT.

Imaged As is

REVISIONS							
DATE	BY	DESCRIPTION	DATE	BY	DESCRIPTION	DATE	BY

XS-A13	NAME	DATE	NAME	DATE
DESIGNED BY	L.P. CLEGG	8-91	DRAWN BY	S.W./A.C.
CHECKED BY	W.F. BIGGS	8-91	CHECKED BY	L.P. CLEGG
SUPERVISED BY	WILLIAM F. BIGGS, P.E.			

FLORIDA DEPARTMENT OF TRANSPORTATION
 APPROVED BY: *[Signature]*
 DATE: 12/10/91

Boyle Engineering Corporation
 of Florida
 5912-A Bruceway Lodge Parkway, Tampa, FL 33630-4251 813/671-7500


CROSS SECTIONS
 SOUTHBOUND I-75

4-JUMBLE-TASKOM-BIGGS-WEIGH-PUNTA-S-XS-A13 SPOOLED BY COE ON 06 SEP 1991 AT 11:38:53


RECEIVED
Southwest Florida
Management District
DEC 09 1991
RDW - VENICE

L.A. R/W LINE


SURVEY "A"

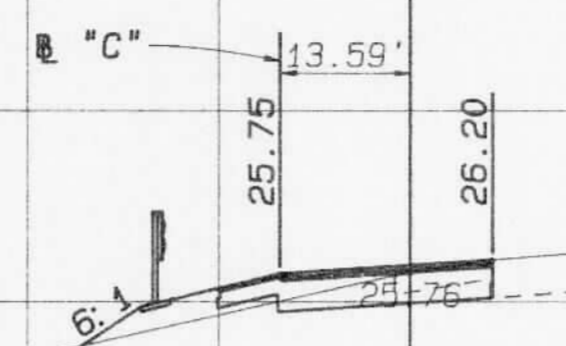

63+00.00 B "A"
146+41.41 B "C"

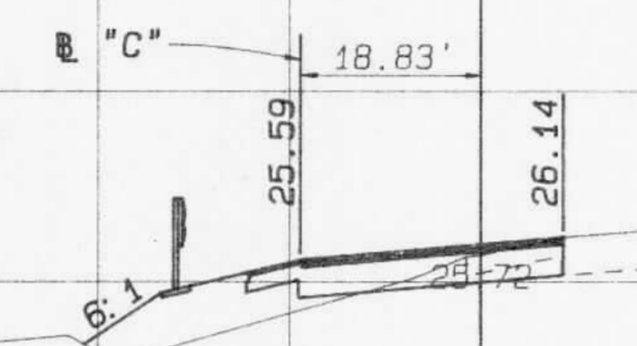

62+00.00 B "A"
145+41.28 B "C"

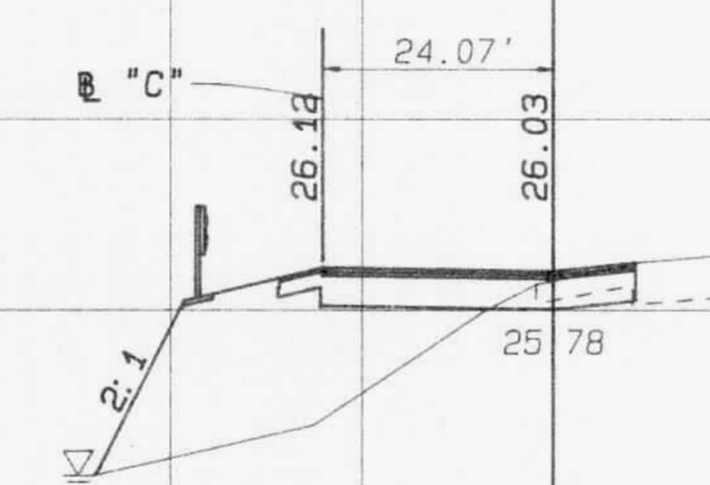


61+00.00 B "A"
144+41.14 B "C"

PERMITTEE SHALL NOTIFY IN WRITING
THE VENICE PERMITTING DEPARTMENT,
SOUTHWEST FLORIDA WATER MANAGEMENT
DISTRICT, WHEN CONSTRUCTION BEGINS.

L.A. R/W LINE

SURVEY "A"

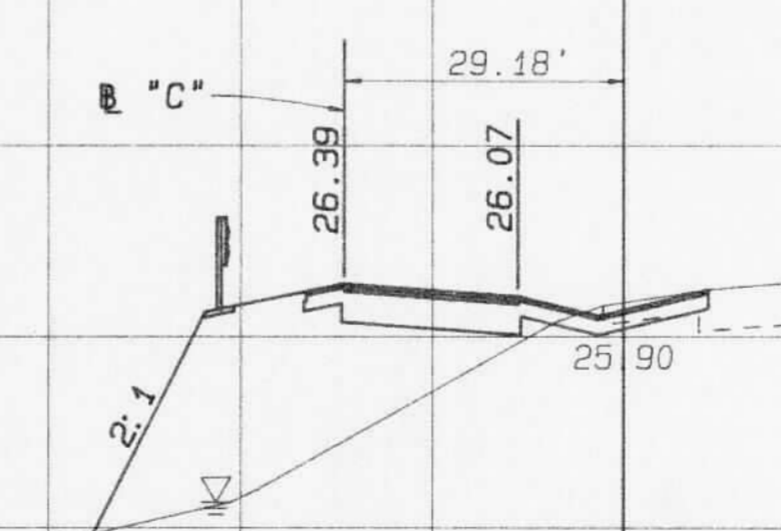

60+00.00 B "A"
143+41.01 B "C"

FILE OF RECORD
PERMIT NO. 409592.00

SOUTHWEST FLORIDA WATER
MANAGEMENT DISTRICT
PERMITTED CONSTRUCTION
DRAWINGS

SCALE: 1" = 20' HORIZ.
1" = 5' VERT.

Imaged As Is

REVISIONS			
DATE	BY	DESCRIPTION	

XS-A14	NAME	DATE	NAME	DATE
DESIGNED BY	L.P. CLEGG	8-91	DRAWN BY	S.W./A.C.
CHECKED BY	W.F. BIGGS	8-91	CHECKED BY	L.P. CLEGG
SUPERVISED BY	WILLIAM F. BIGGS, P.E.			


FLORIDA DEPARTMENT OF TRANSPORTATION
APPROVED BY
[Signature]
DATE 12/10/91

Boyle Engineering Corporation
of Florida
5912-A Breckenridge Parkway, Tampa, FL 33610-0291 813/921-7900

CROSS SECTIONS
SOUTHBOUND I-75

C:\JUMBLE\TASK\M.BIGGS\WEIGH\PUNTA\S.XS-A14 SPOOLED BY RICKER ON 09 SEP 1991 AT 10:55:54

RECEIVED
Southwest Florida Water
Management District
DEC 09 1991
RD - VENUE

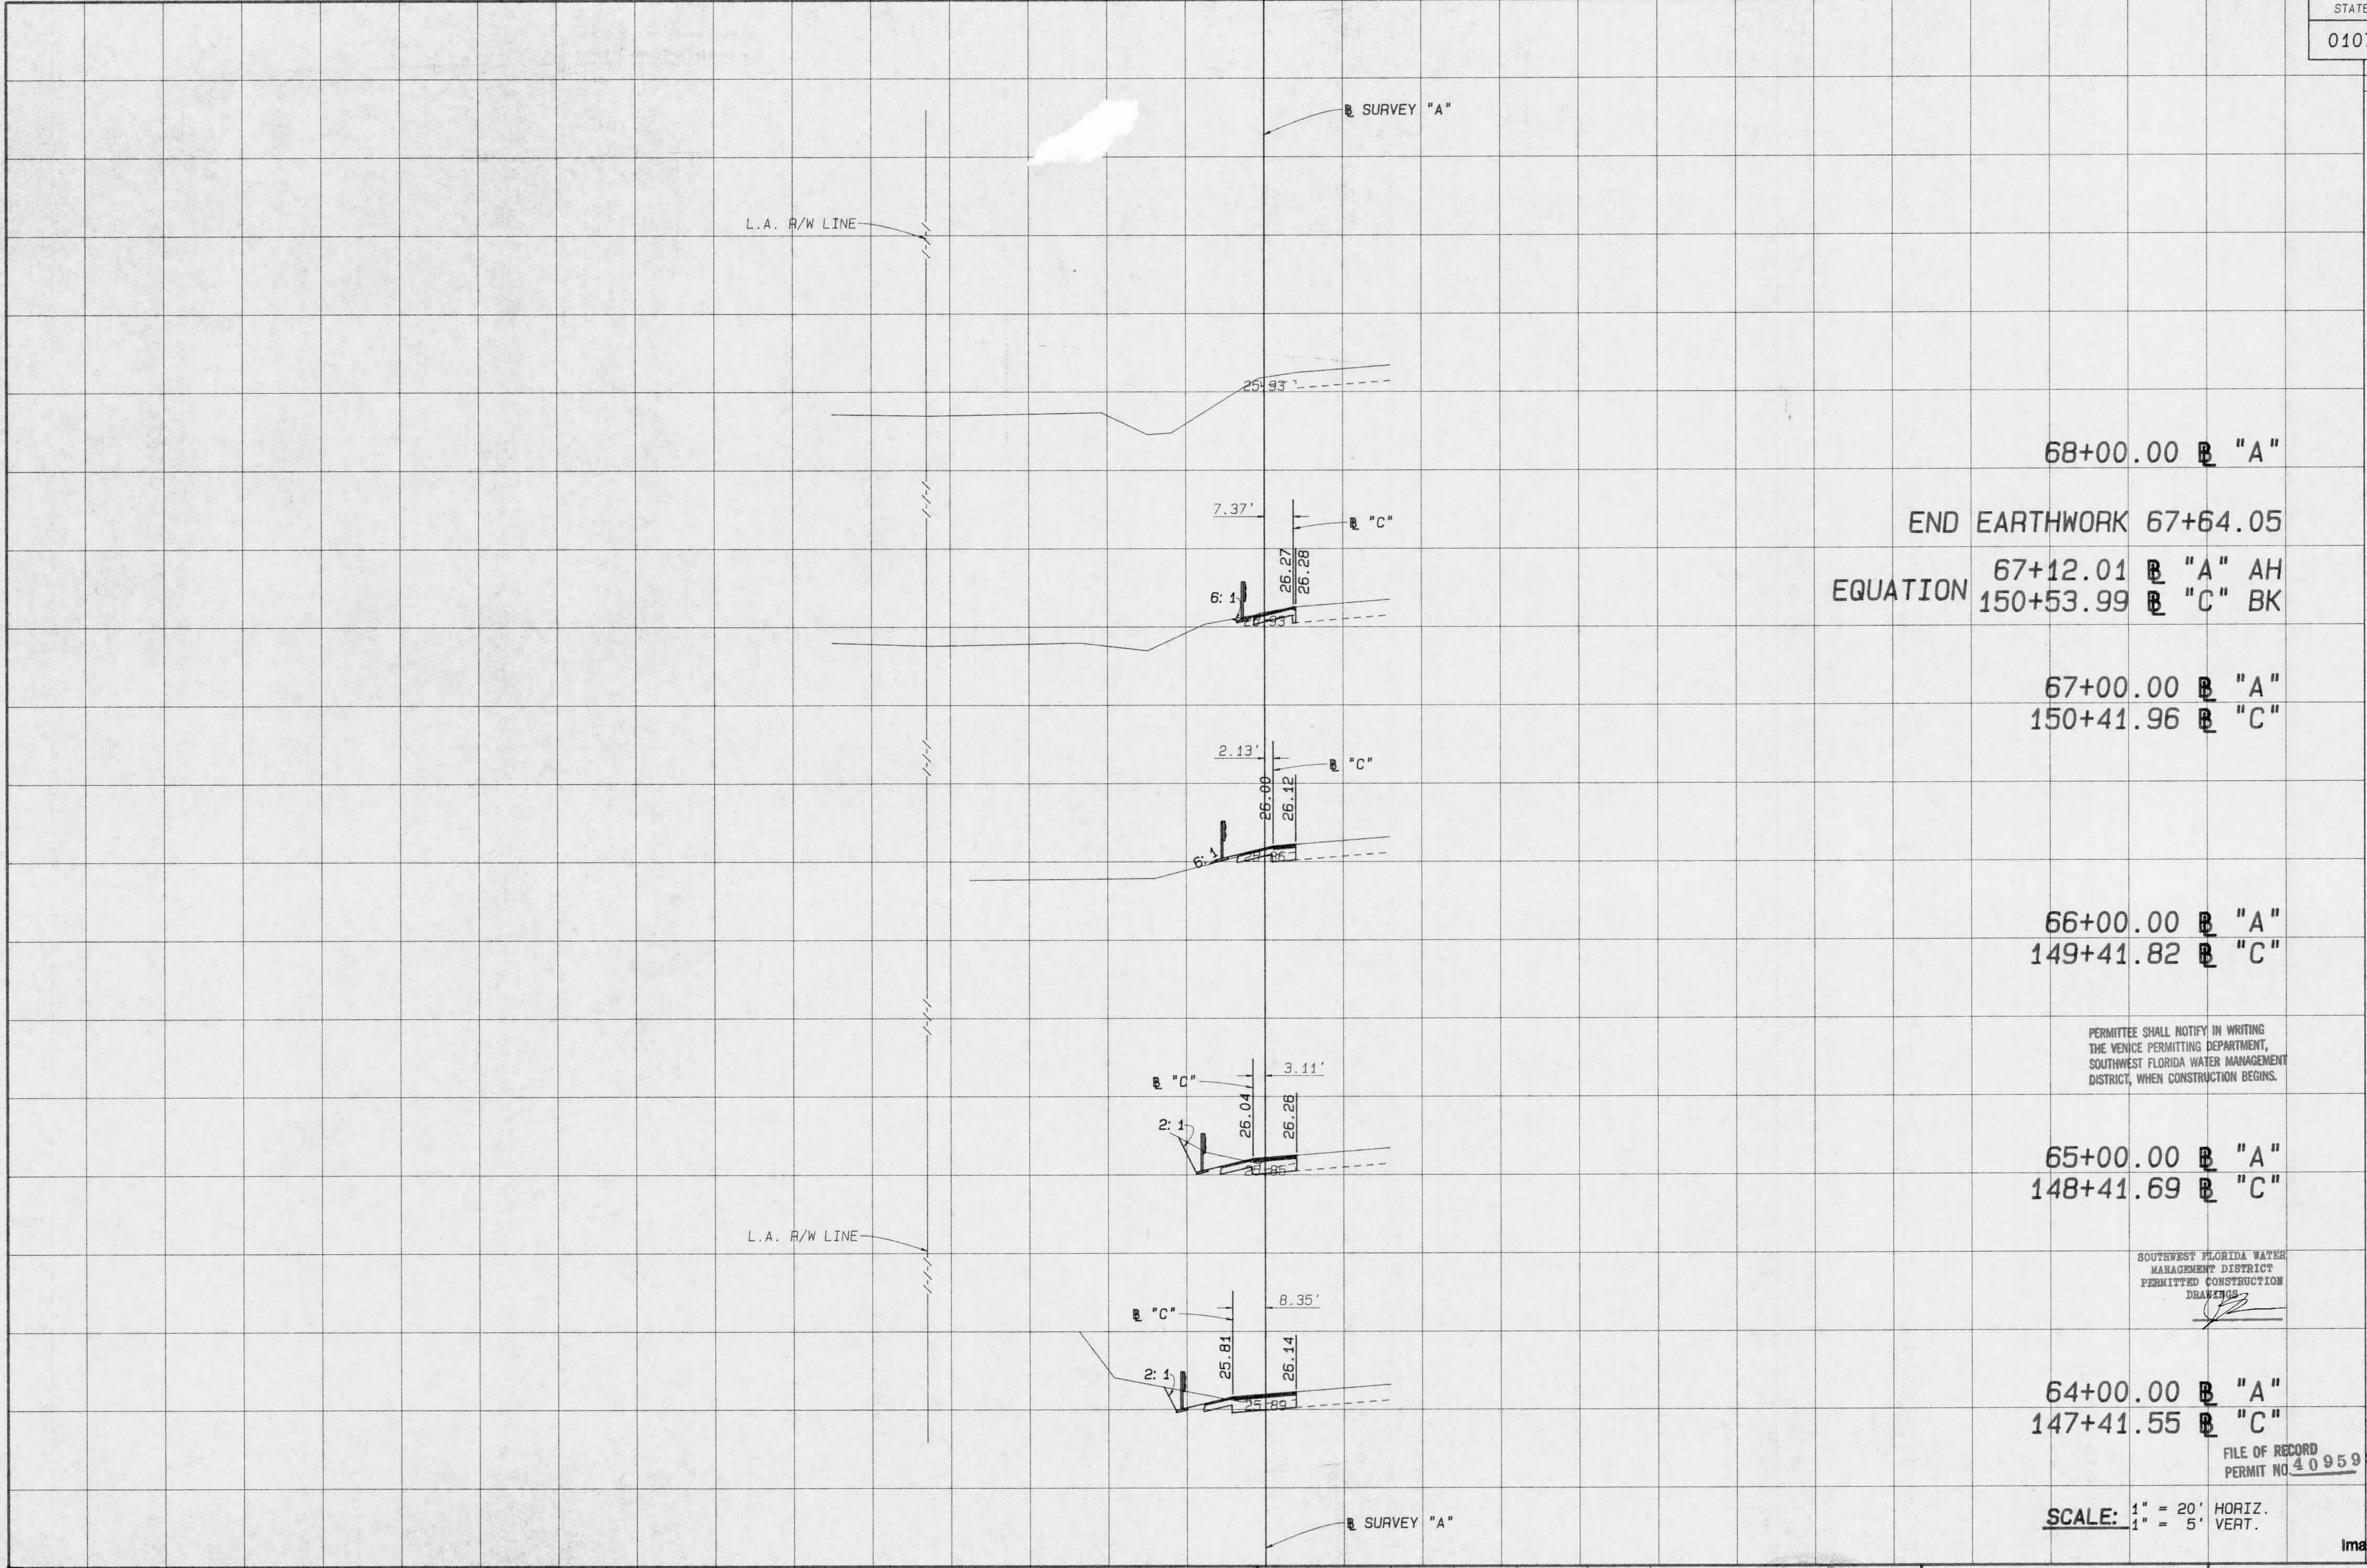

68+00.00 B "A"
END EARTHWORK 67+64.05
EQUATION 67+12.01 B "A" AH
150+53.99 B "C" BK

67+00.00 B "A"
150+41.96 B "C"

66+00.00 B "A"
149+41.82 B "C"

PERMITEE SHALL NOTIFY IN WRITING
THE VENUE PERMITTING DEPARTMENT,
SOUTHWEST FLORIDA WATER MANAGEMENT
DISTRICT, WHEN CONSTRUCTION BEGINS.

65+00.00 B "A"
148+41.69 B "C"

SOUTHWEST FLORIDA WATER
MANAGEMENT DISTRICT
PERMITTED CONSTRUCTION
DRAWINGS

64+00.00 B "A"
147+41.55 B "C"

FILE OF RECORD
PERMIT NO. 409592.00

SCALE: 1" = 20' HORIZ.
1" = 5' VERT.

Imaged As Is

REVISIONS							
DATE	BY	DESCRIPTION	DATE	BY	DESCRIPTION	DATE	BY

XS-A15	NAME	DATE	NAME	DATE
DESIGNED BY	L.P. CLEGG	8-91	DRAWN BY	S.W./A.C.
CHECKED BY	W.F. BIGGS	8-91	CHECKED BY	L.P. CLEGG
SUPERVISED BY	WILLIAM F. BIGGS, P.E.			


FLORIDA DEPARTMENT OF TRANSPORTATION
APPROVED BY
DATE 12/1/91

Boyle Engineering Corporation
of Florida
5912-A Breckenridge Parkway, Tampa, FL 33610-4251 813/921-7900

**CROSS SECTIONS
SOUTHBOUND I-75**

C:\JUMBLE\TASK\M.BIGGS\WEIGH\PUNTA\S.XS-A15 SPOOLED BY RICKER ON 09 SEP 1991 AT 11:18:24

RECEIVED
Southwest Florida Water
Management District
DEC 9 1991
PRD - VENICE

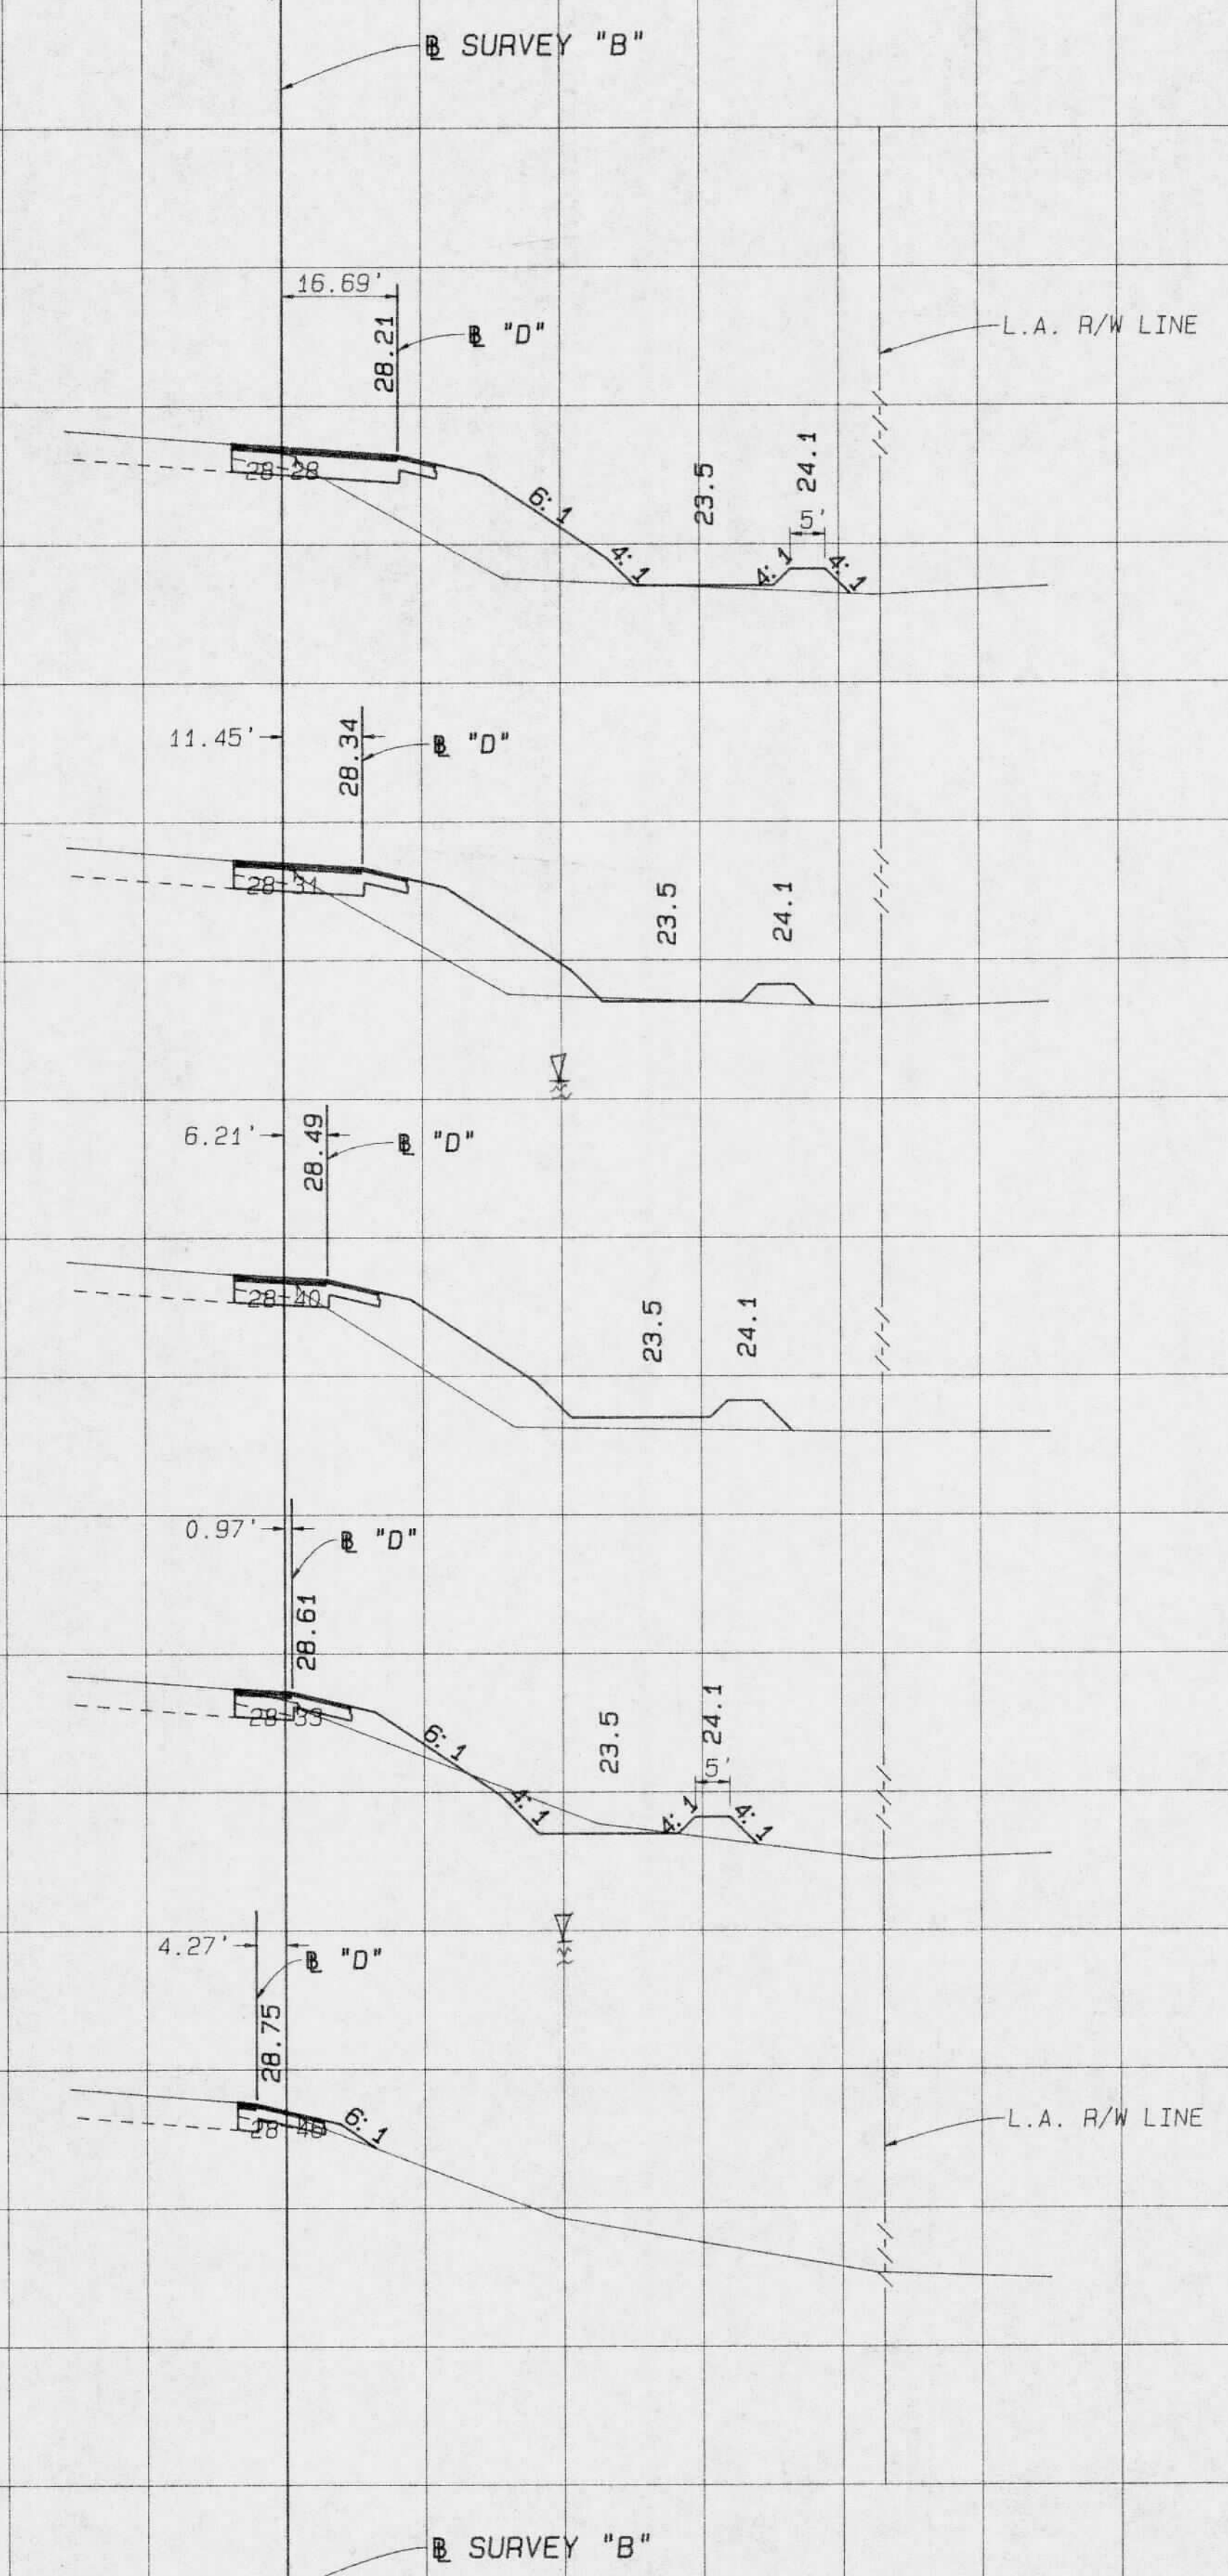

4+00.00 B "B"
114+62.33 B "D"

3+00.00 B "B"
113+62.19 B "D"

2+00.00 B "B"
112+62.05 B "D"

PERMITTEE SHALL NOTIFY IN WRITING
THE VENICE PERMITTING DEPARTMENT,
SOUTHWEST FLORIDA WATER MANAGEMENT
DISTRICT, WHEN CONSTRUCTION BEGINS.

1+00.00 B "B"
111+61.92 B "D"

SOUTHWEST FLORIDA WATER
MANAGEMENT DISTRICT
PERMITTED CONSTRUCTION
DRAWINGS

EQUATION 0+00.00 B "B" AH
400+00.00 B "B" BK
110+61.78 B "D"

BEGIN PROJECT
BEGIN CONSTRUCTION NORTHBOUND
STA 110+00.00 B "D"
STA 399+38.31 B SURVEY "B"

FILE OF RECORD
PERMIT NO. 409592-00

SCALE: 1" = 20' HORIZ.
1" = 5' VERT.

Imaged As Is

REVISIONS							
DATE	BY	DESCRIPTION	DATE	BY	DESCRIPTION	DATE	BY

XS-BP	NAME	DATE	NAME	DATE
DESIGNED BY	L.P. CLEGG	8-91	DRAWN BY	S.W./A.C.
CHECKED BY	W.F. BIGGS	8-91	CHECKED BY	L.P. CLEGG
SUPERVISED BY	WILLIAM F. BIGGS, P.E.			

FLORIDA DEPARTMENT OF TRANSPORTATION
APPROVED BY
Will [Signature]
DATE 12/1/91


Boyle Engineering Corporation
of Florida
5910-A Breckenridge Parkway, Tampa, FL 33610-4251 813/921-7900

CROSS SECTIONS
NORTHBOUND I-75

C:\JUMBLE-TASK\M-BIGGS\NEIGH-PUNTA>8.X6-DE SPOOLED BY CLEGG ON 22 NOV 1991 AT 10:41:33

Rdwy.	Exc.	F111
A	V	A
		V

RECEIVED
 Southwest Florida Water Management District
 DEC 09 1991
 RDW - VENICE

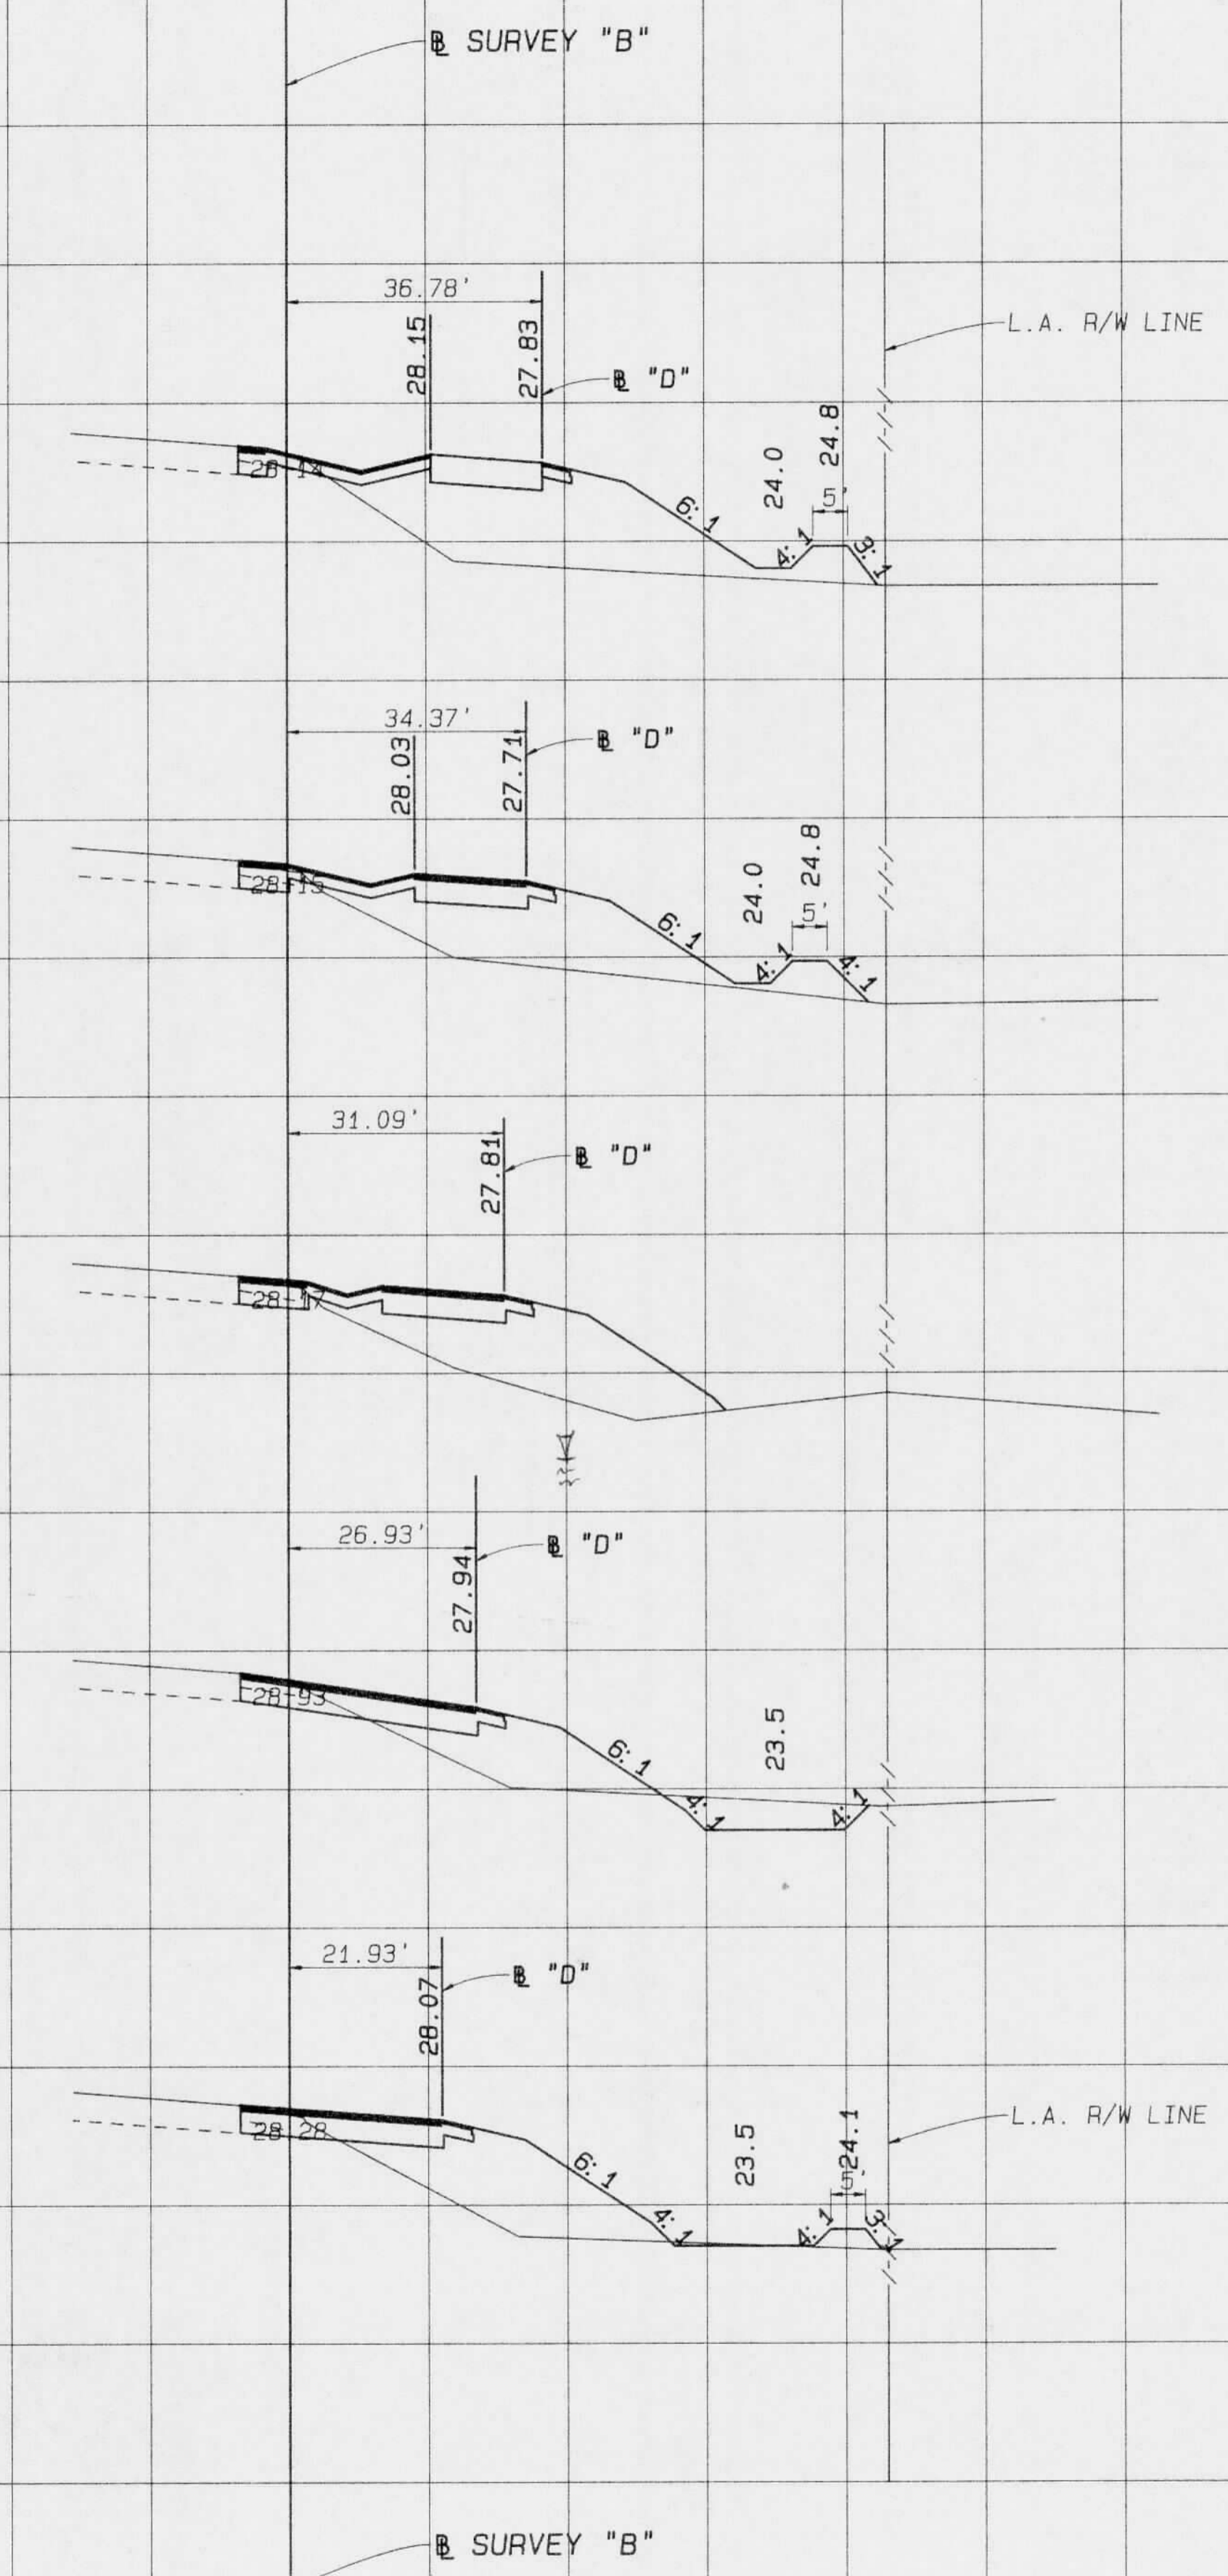

9+00.00 B "B"
 119+62.76 B "D"

8+00.00 B "B"
 118+62.73 B "D"

7+00.00 B "B"
 117+62.68 B "D"

PERMITTEE SHALL NOTIFY IN WRITING THE VENICE PERMITTING DEPARTMENT, SOUTHWEST FLORIDA WATER MANAGEMENT DISTRICT, WHEN CONSTRUCTION BEGINS.

6+00.00 B "B"
 116+62.59 B "D"

SOUTHWEST FLORIDA WATER MANAGEMENT DISTRICT PERMITTED CONSTRUCTION DRAWINGS

5+00.00 B "B"
 115+62.47 B "D"

FILE OF RECORD PERMIT NO. 409592.00

SCALE: 1" = 20' HORIZ.
 1" = 5' VERT.

Imaged As Is

REVISIONS							
DATE	BY	DESCRIPTION	DATE	BY	DESCRIPTION	DATE	BY

DESIGNED BY	L. P. CLEGG	8-91	DRAWN BY	S. W. / A. C.	8-91
CHECKED BY	W. F. BIGGS	8-91	CHECKED BY	L. P. CLEGG	8-91
SUPERVISED BY		WILLIAM F. BIGGS, P.E.			

FLORIDA DEPARTMENT OF TRANSPORTATION
 APPROVED BY: [Signature]
 DATE: 12/6/91


Boyle Engineering Corporation
 of Florida
 5912-A Breckenridge Parkway, Tampa, FL 33610-4291 813/821-7900

CROSS SECTIONS
 NORTHBOUND I-75

<JUMBLE>TASK-W. BIGGS-WEIGH-PUNTA>6.X8-B3 SPOOLED BY CLEGG ON 22 NOV 1991 AT 11:26:46

Rdwy.	Exc.	Fill
A	V	A
		V

RECEIVED
Southwest Florida Water Management District
DEC 09 1991
BRD-VENICE

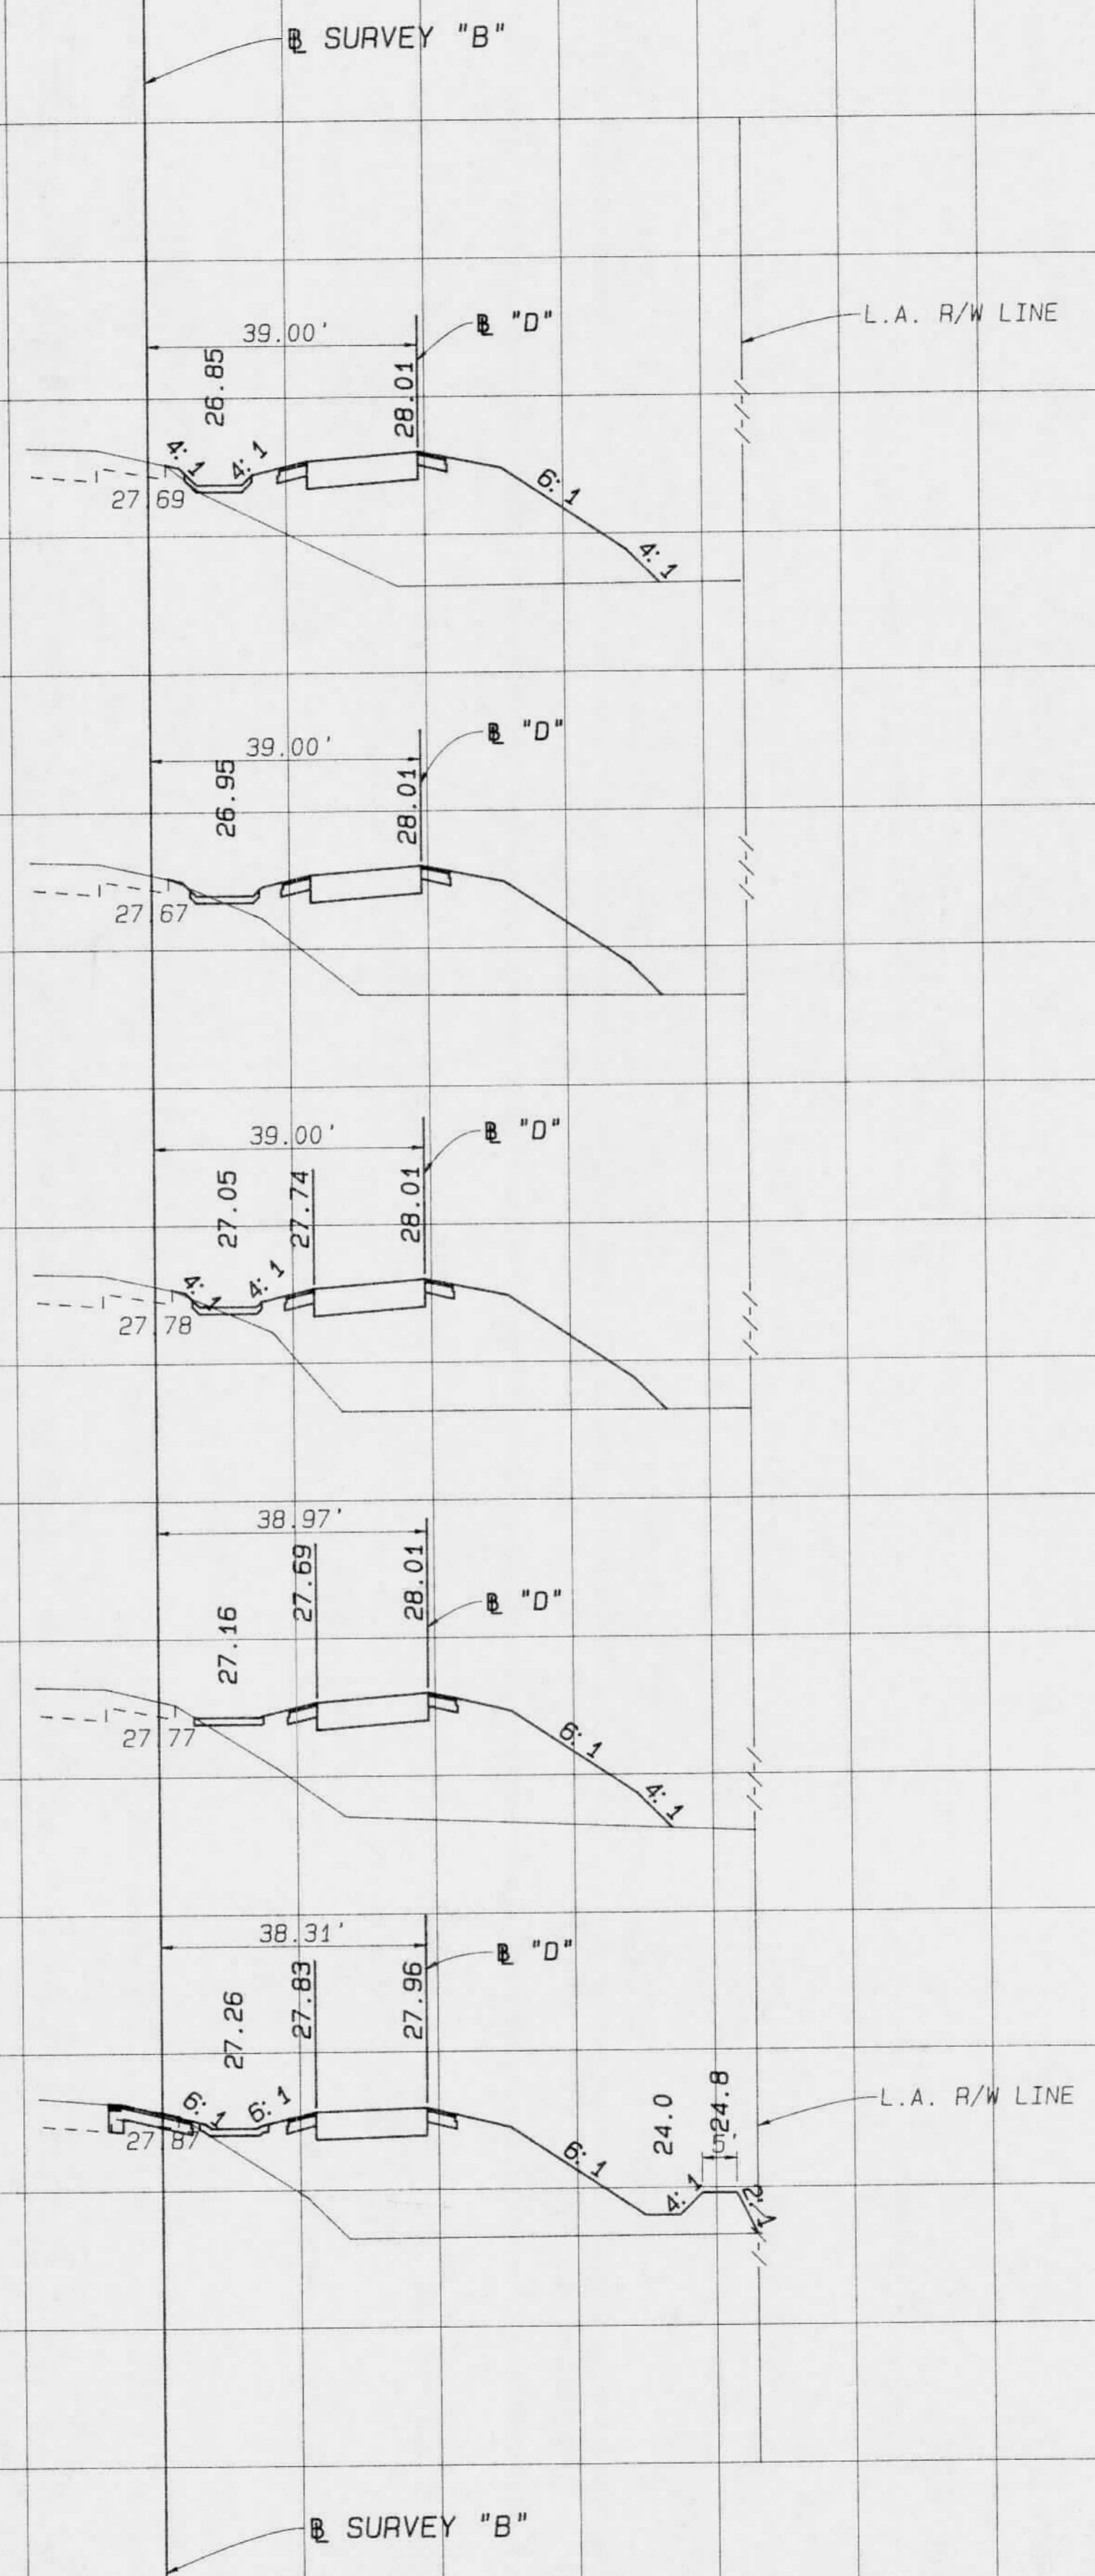

14+00.00 B "B"
124+62.78 B "D"

13+00.00 B "B"
123+62.78 B "D"

12+00.00 B "B"
122+62.78 B "D"

11+00.00 B "B"
121+62.78 B "D"

10+00.00 B "B"
120+62.77 B "D"

PERMITTEE SHALL NOTIFY IN WRITING THE VENICE PERMITTING DEPARTMENT, SOUTHWEST FLORIDA WATER MANAGEMENT DISTRICT, WHEN CONSTRUCTION BEGINS.

SOUTHWEST FLORIDA WATER MANAGEMENT DISTRICT PERMITTED CONSTRUCTION DRAWING

FILE OF RECORD PERMIT NO. 409592-00

SCALE: 1" = 20' HORIZ.
1" = 5' VERT.

Imaged As Is

REVISIONS											
DATE	BY	DESCRIPTION	DATE	BY	DESCRIPTION	DATE	BY	DESCRIPTION	DATE	BY	DESCRIPTION

DESIGNED BY	L. P. CLEGG	8-91	DRAWN BY	S. W. / A. C.	8-91
CHECKED BY	W. F. BIGGS	8-91	CHECKED BY	L. P. CLEGG	8-91
SUPERVISED BY		WILLIAM F. BIGGS, P.E.			


FLORIDA DEPARTMENT OF TRANSPORTATION
APPROVED BY
DATE 12/6/91

Boyle Engineering Corporation
5512-A Breckenridge Parkway, Tampa, FL 33610-4251 813/827-7900


CROSS SECTIONS
NORTHBOUND I-75

Rdwy.	Exc.	Fill
A	V	A
		V


RECEIVED
Southwest Florida Water
Management District
DEC 09 1991
RD - VENICE

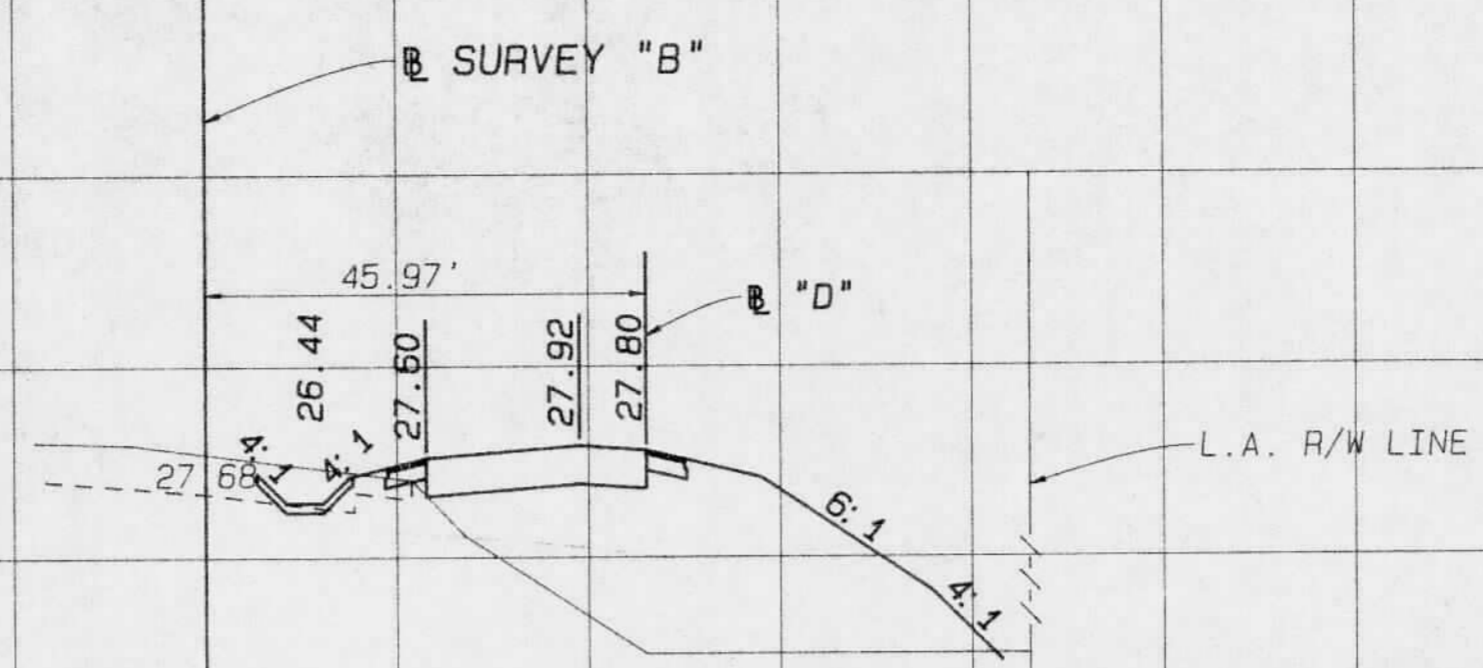

19+00.00 B "B"
129+62.91 B "D"

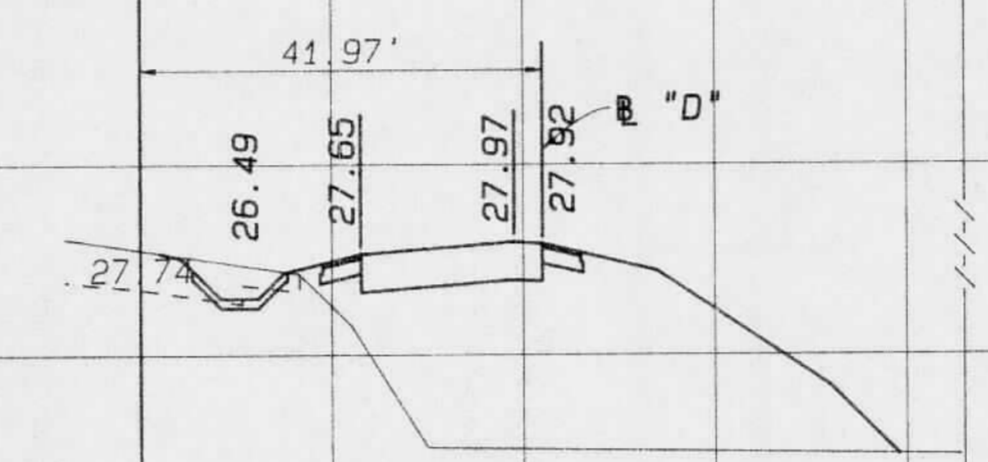


18+00.00 B "B"
128+62.83 B "D"

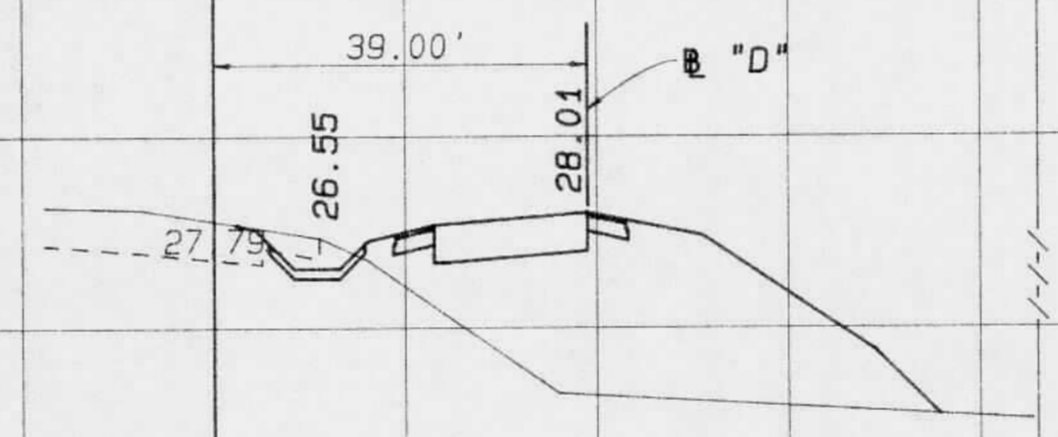


17+00.00 B "B"
127+62.78 B "D"

PERMITTEE SHALL NOTIFY IN WRITING
THE VENICE PERMITTING DEPARTMENT,
SOUTHWEST FLORIDA WATER MANAGEMENT
DISTRICT, WHEN CONSTRUCTION BEGINS.

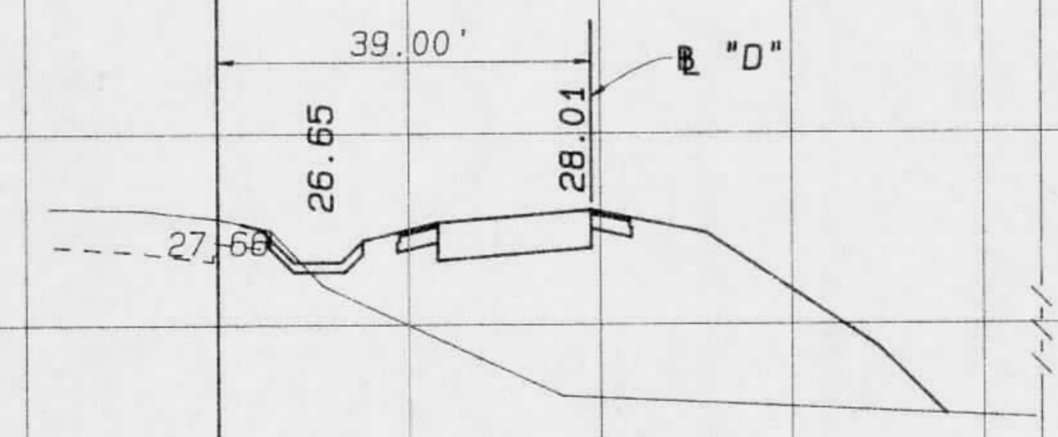

16+00.00 B "B"
126+62.78 B "D"

SOUTHWEST FLORIDA WATER
MANAGEMENT DISTRICT
PERMITTED CONSTRUCTION
DRAWINGS

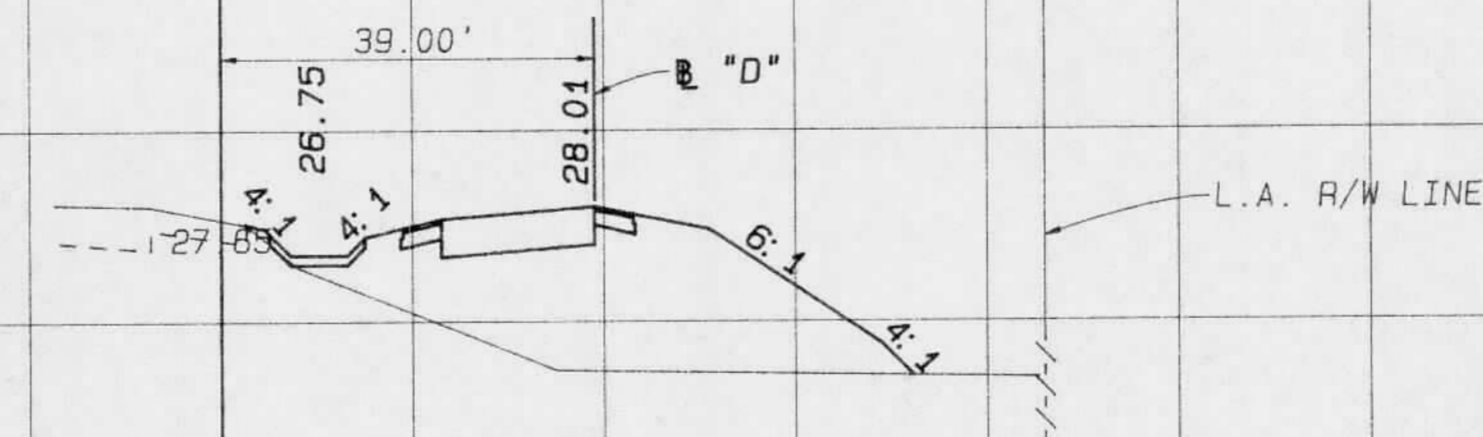

15+00.00 B "B"
125+62.78 B "D"

FILE OF RECORD
PERMIT NO. 409592-00

SCALE: 1" = 20' HORIZ.
1" = 5' VERT.

Imaged As Is

REVISIONS					
DATE	BY	DESCRIPTION	DATE	BY	DESCRIPTION

XS-05	NAME	DATE	NAME	DATE
DESIGNED BY	L. P. CLEGG	8-91	DRAWN BY	S. W. / A. C.
CHECKED BY	W. F. BIGGS	8-91	CHECKED BY	L. P. CLEGG
SUPERVISED BY	WILLIAM F. BIGGS, P.E.			

FLORIDA DEPARTMENT OF TRANSPORTATION
APPROVED BY
[Signature]
DATE 12/6/91


Boyle Engineering Corporation
of Florida
5912-A Brackenridge Parkway, Tampa, FL 33610-4291 813/971-7900

**CROSS SECTIONS
NORTHBOUND I-75**

C:\JUMBLE\TASK\M_BIGGS\WEIGH\PUNTA\S_XS-05 SPOOLED BY RICKER ON 10 SEP 1991 AT 16:31:56

Rdwy.	Exc.	Fill
A	V	A
		V

RECEIVED
 Submitted by: [Signature]
 Date: DEC 9 1991
 RDW - VENUE

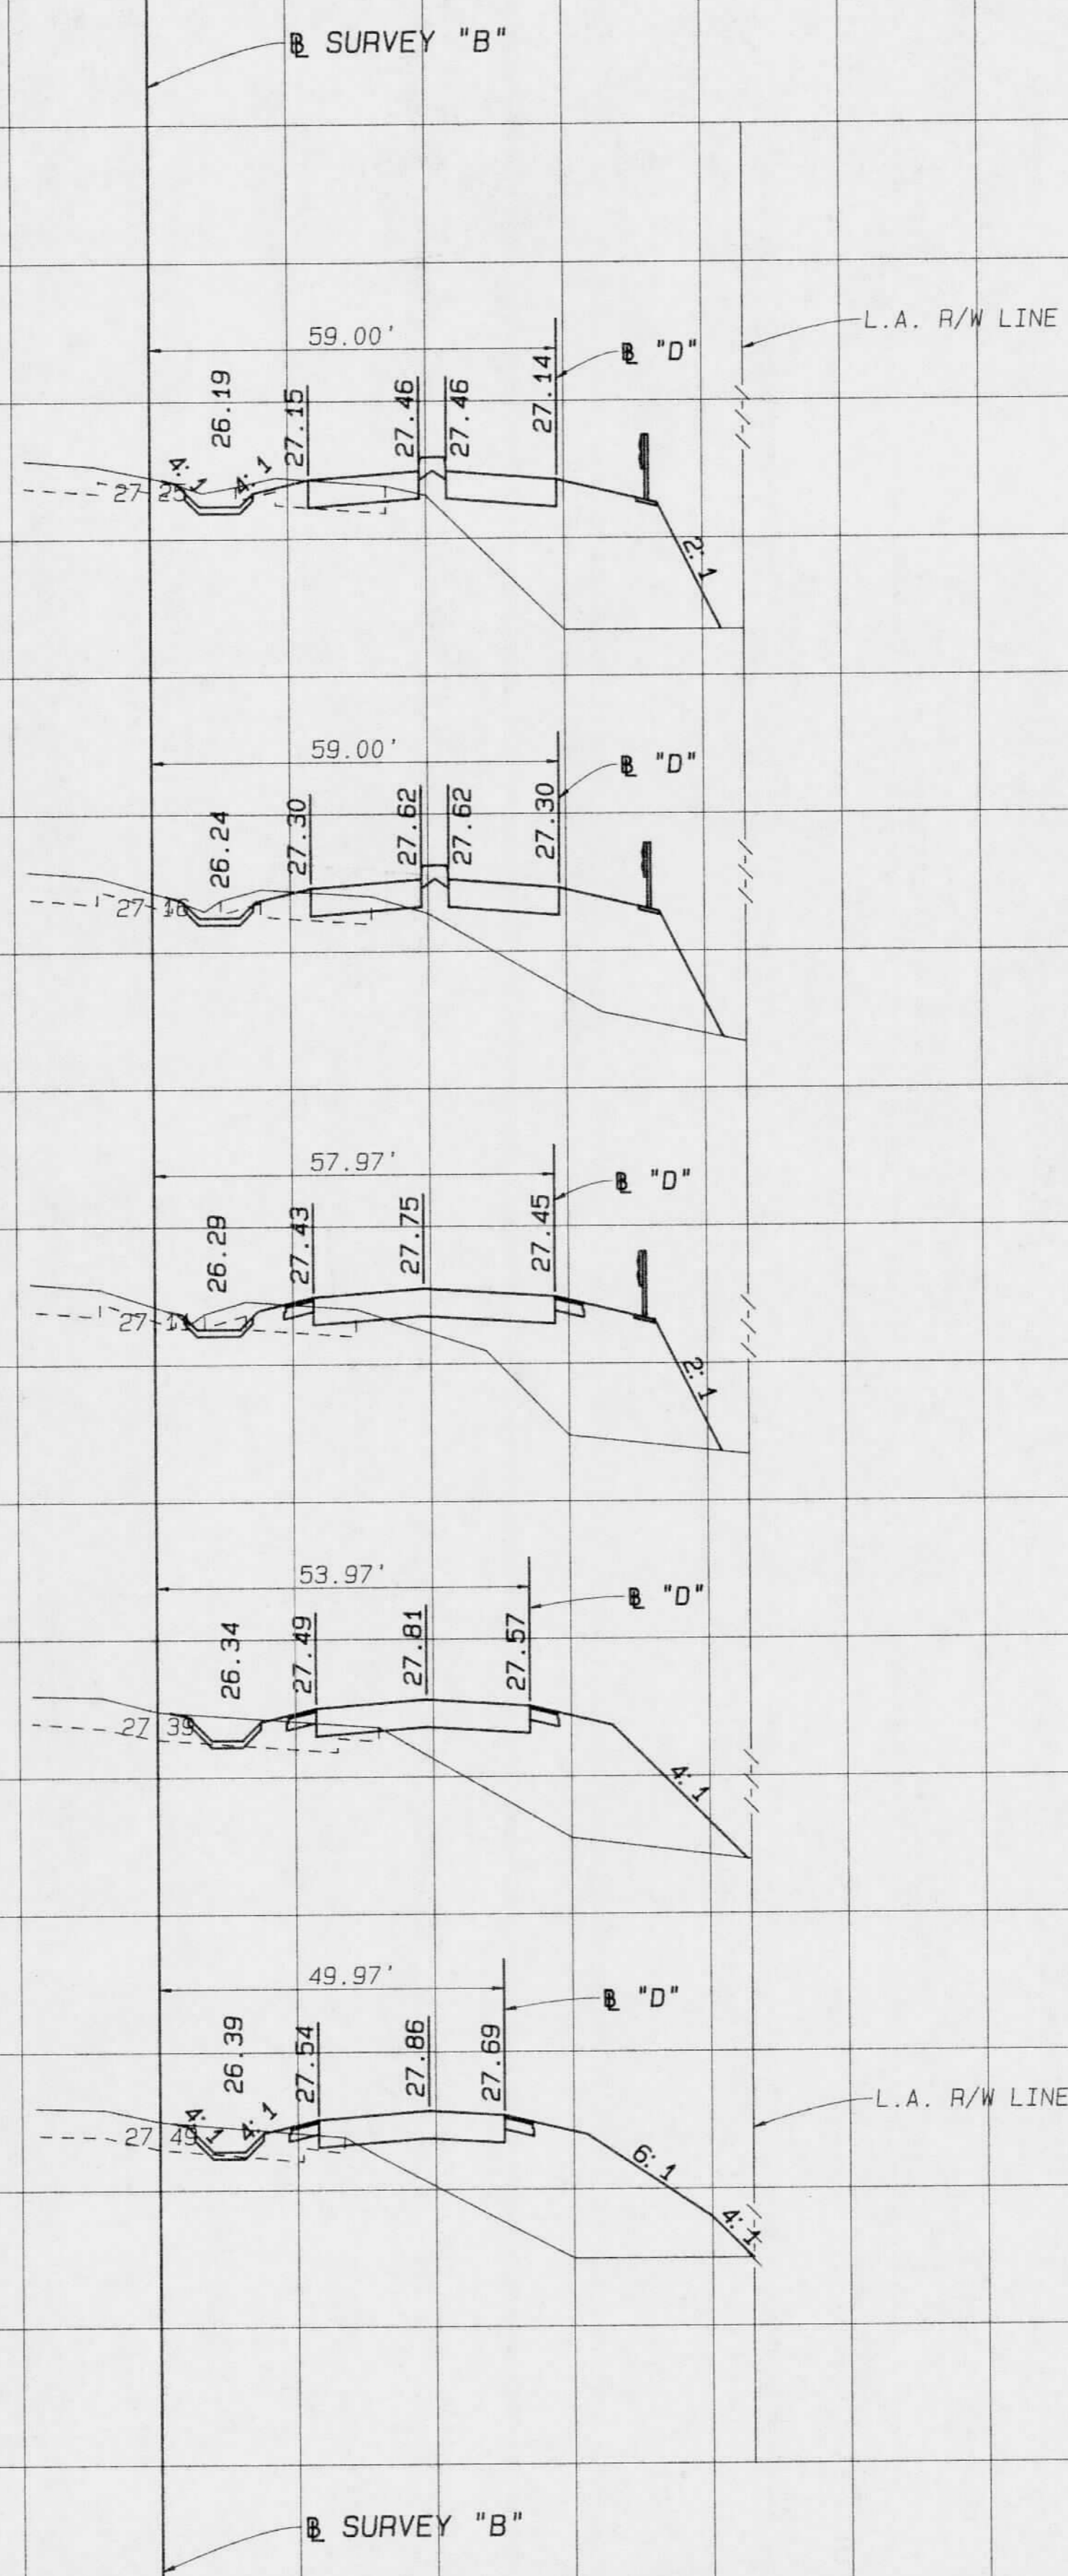

24+00.00 B "B"
 134+63.18 B "D"

23+00.00 B "B"
 133+63.18 B "D"

22+00.00 B "B"
 132+63.15 B "D"

21+00.00 B "B"
 131+63.07 B "D"

20+00.00 B "B"
 130+62.99 B "D"

PERMITTEE SHALL NOTIFY IN WRITING
 THE VENICE PERMITTING DEPARTMENT,
 SOUTHWEST FLORIDA WATER MANAGEMENT
 DISTRICT, WHEN CONSTRUCTION BEGINS.

SOUTHWEST FLORIDA WATER
 MANAGEMENT DISTRICT
 PERMITTED CONSTRUCTION
 DRAWING
 [Signature]

FILE OF RECORD
 PERMIT NO. 409592.00

SCALE: 1" = 20' HORIZ.
 1" = 5' VERT.

Imaged As Is

REVISIONS											
DATE	BY	DESCRIPTION	DATE	BY	DESCRIPTION	DATE	BY	DESCRIPTION	DATE	BY	DESCRIPTION

DESIGNED BY	L. P. CLEGG	8-91	DRAWN BY	S. W. / A. C.	8-91
CHECKED BY	W. F. BIGGS	8-91	CHECKED BY	L. P. CLEGG	8-91
SUPERVISED BY		WILLIAM F. BIGGS, P.E.			


FLORIDA DEPARTMENT OF TRANSPORTATION
 APPROVED BY [Signature] DATE 12/10/91

Boyle Engineering Corporation
 of Florida
 5912-A Breckenridge Parkway, Tampa, FL 33610-4551 813/921-7900

**CROSS SECTIONS
 NORTHBOUND I-75**

C:\JUMBLE\TASK\M_BIGGS\MEIGH-PUNTA\6.XS-86 SPOOLED BY CDE ON 16 SEP 1991 AT 15:48:24

RECEIVED
Southwest Florida Water
Management District
DEC 09 1991
RRD-VENICE

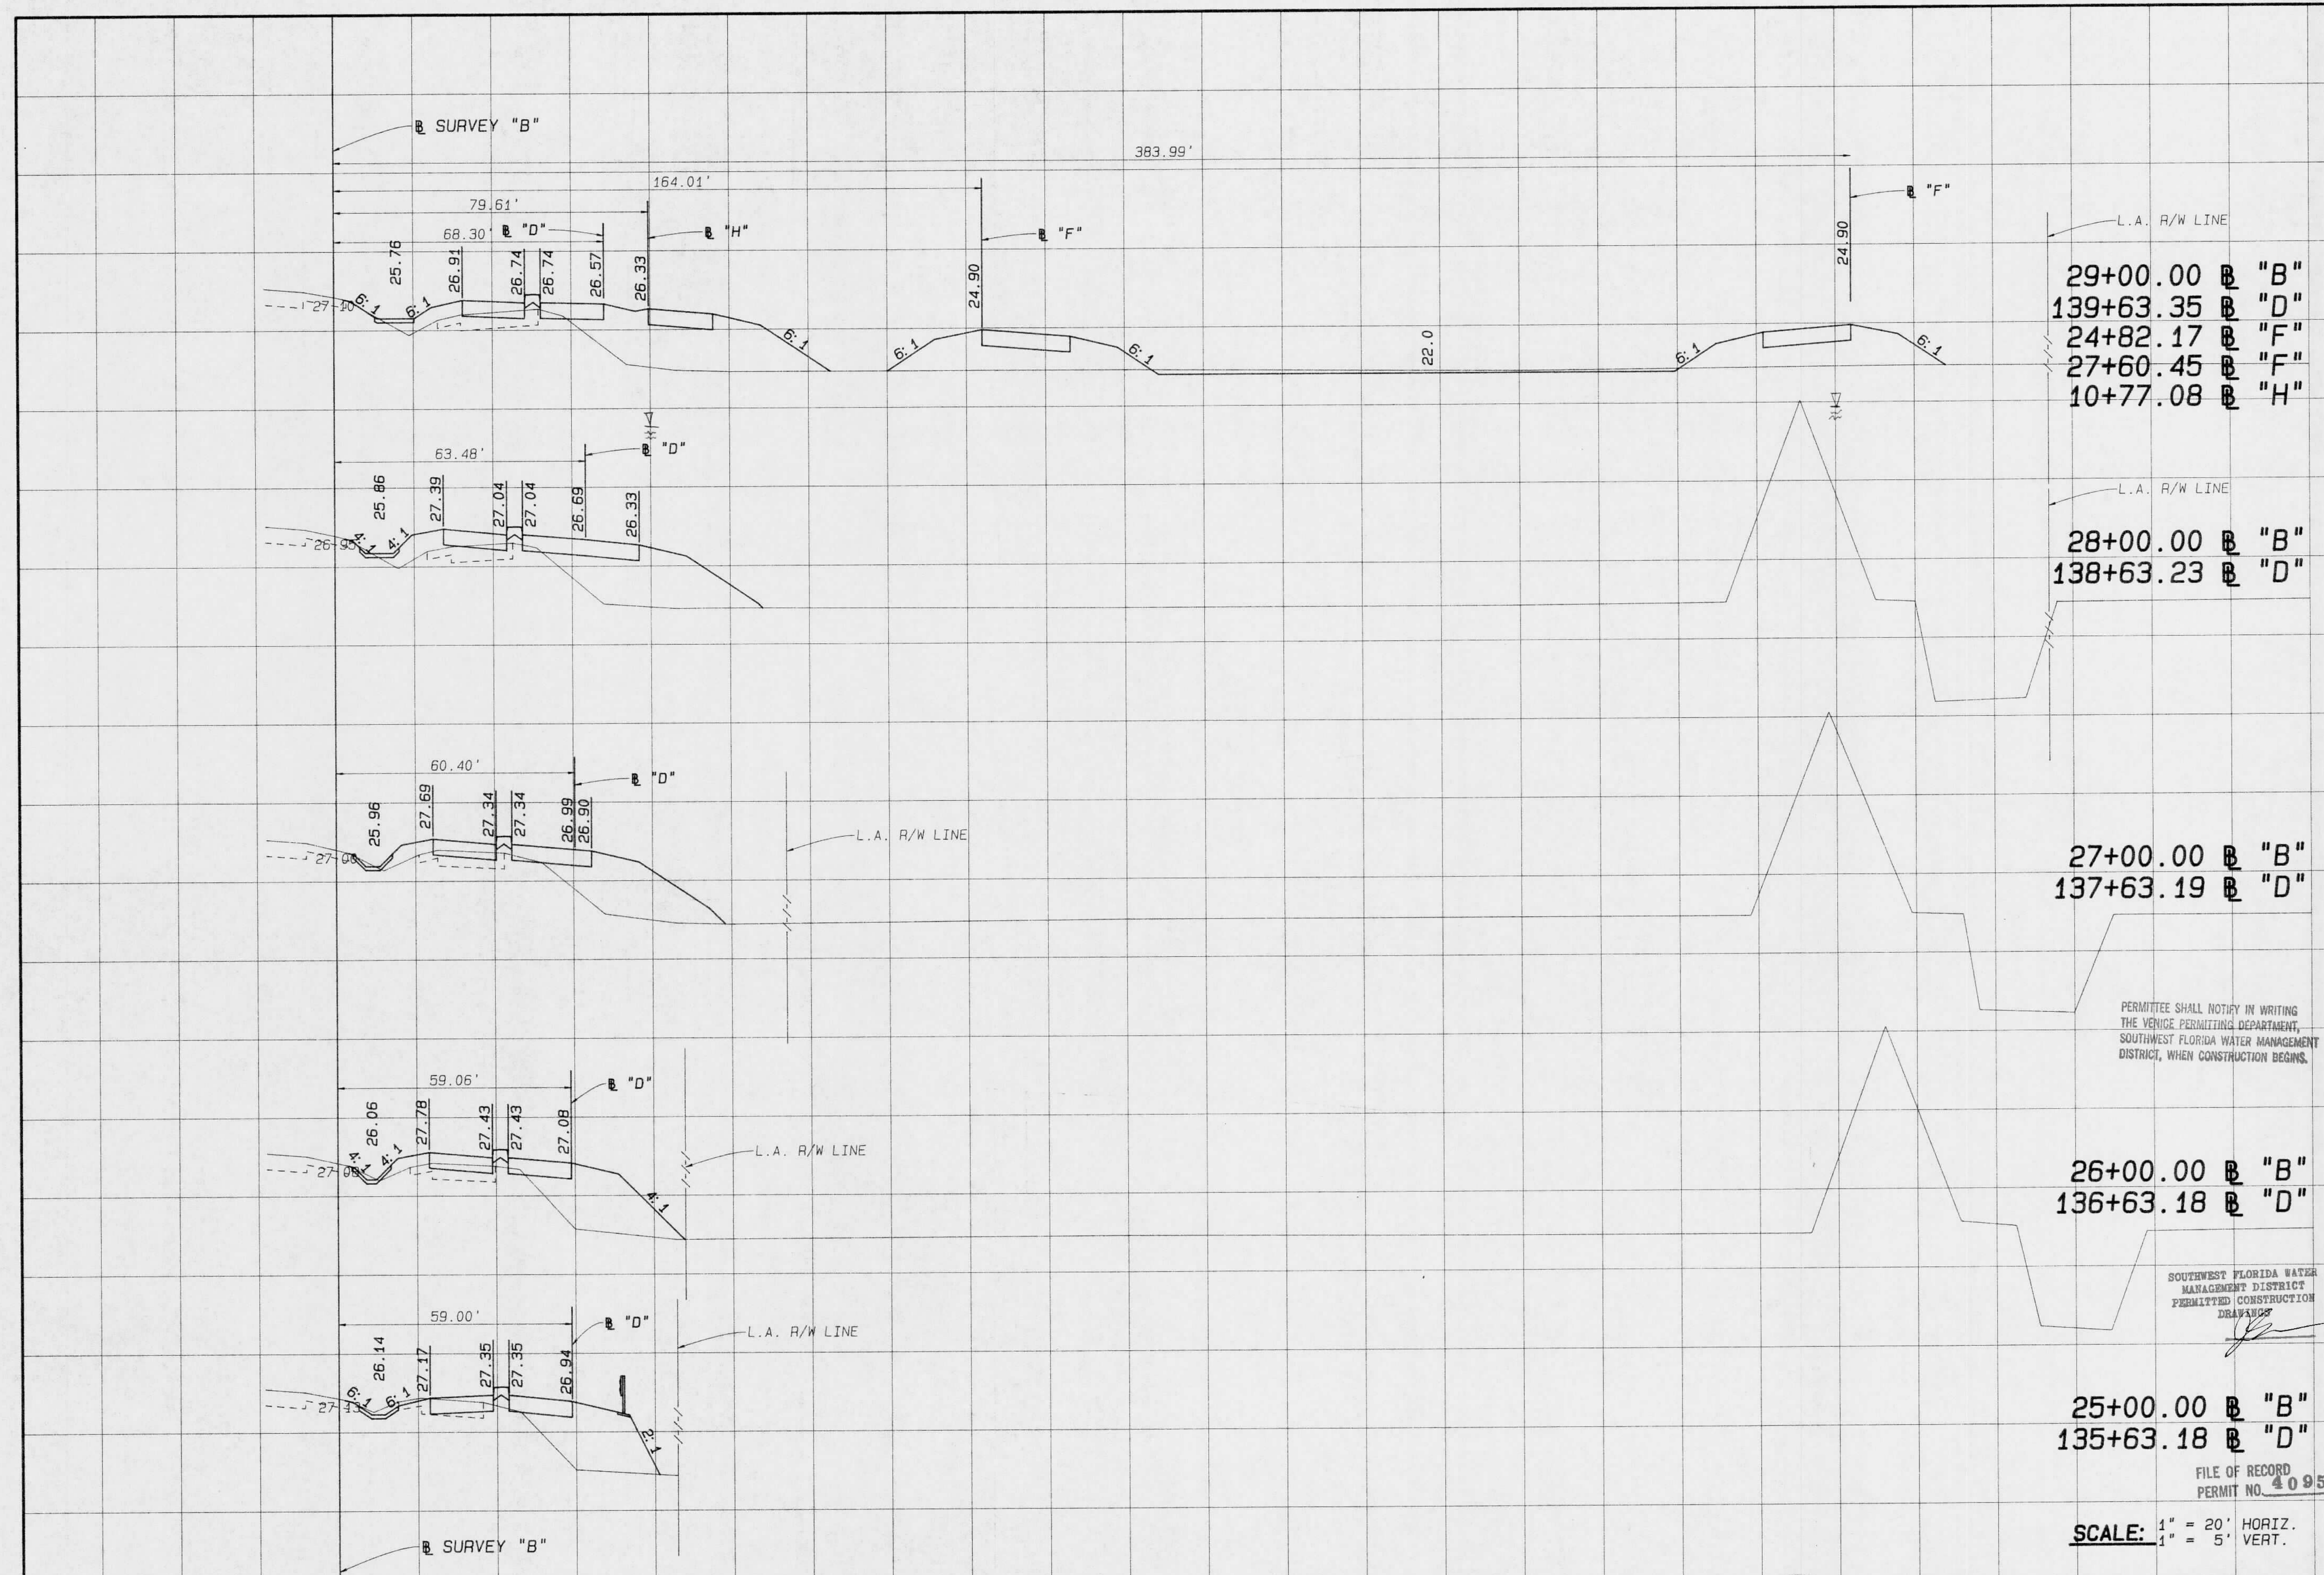

29+00.00 @ "B"
139+63.35 @ "D"
24+82.17 @ "F"
27+60.45 @ "F"
10+77.08 @ "H"

28+00.00 @ "B"
138+63.23 @ "D"

27+00.00 @ "B"
137+63.19 @ "D"

26+00.00 @ "B"
136+63.18 @ "D"

25+00.00 @ "B"
135+63.18 @ "D"

PERMITTEE SHALL NOTIFY IN WRITING THE VENICE PERMITTING DEPARTMENT, SOUTHWEST FLORIDA WATER MANAGEMENT DISTRICT, WHEN CONSTRUCTION BEGINS.

SOUTHWEST FLORIDA WATER MANAGEMENT DISTRICT PERMITTED CONSTRUCTION DRAWING

FILE OF RECORD PERMIT NO. 409592.00

SCALE: 1" = 20' HORIZ.
1" = 5' VERT.

Imaged As Is

REVISIONS							
DATE	BY	DESCRIPTION	DATE	BY	DESCRIPTION	DATE	BY

XS-B7	NAME	DATE	NAME	DATE
DESIGNED BY	L.P. CLEGG	8-91	DRAWN BY	S.W./A.C.
CHECKED BY	W.F. BIGGS	8-91	CHECKED BY	L.P. CLEGG
SUPERVISED BY	WILLIAM F. BIGGS, P.E.			


FLORIDA DEPARTMENT OF TRANSPORTATION
APPROVED BY: *[Signature]* DATE: 12/01/91

Boyle Engineering Corporation
of Florida
5912-A Breckenridge Parkway, Tampa, FL 33610-4251 813/621-7900

**CROSS SECTIONS
NORTHBOUND I-75**

<JUMBLE>TASKOM-BIGGS-NEIGH-PUNTA-S-XS-B7 SPOOLED BY COE ON 16 SEP 1991 AT 16:19:09

Rdwy. Exc. FILL
A V A V
RECEIVED Southwest Florida Water Management District DEC. 9, 1991 BRD - VENICE

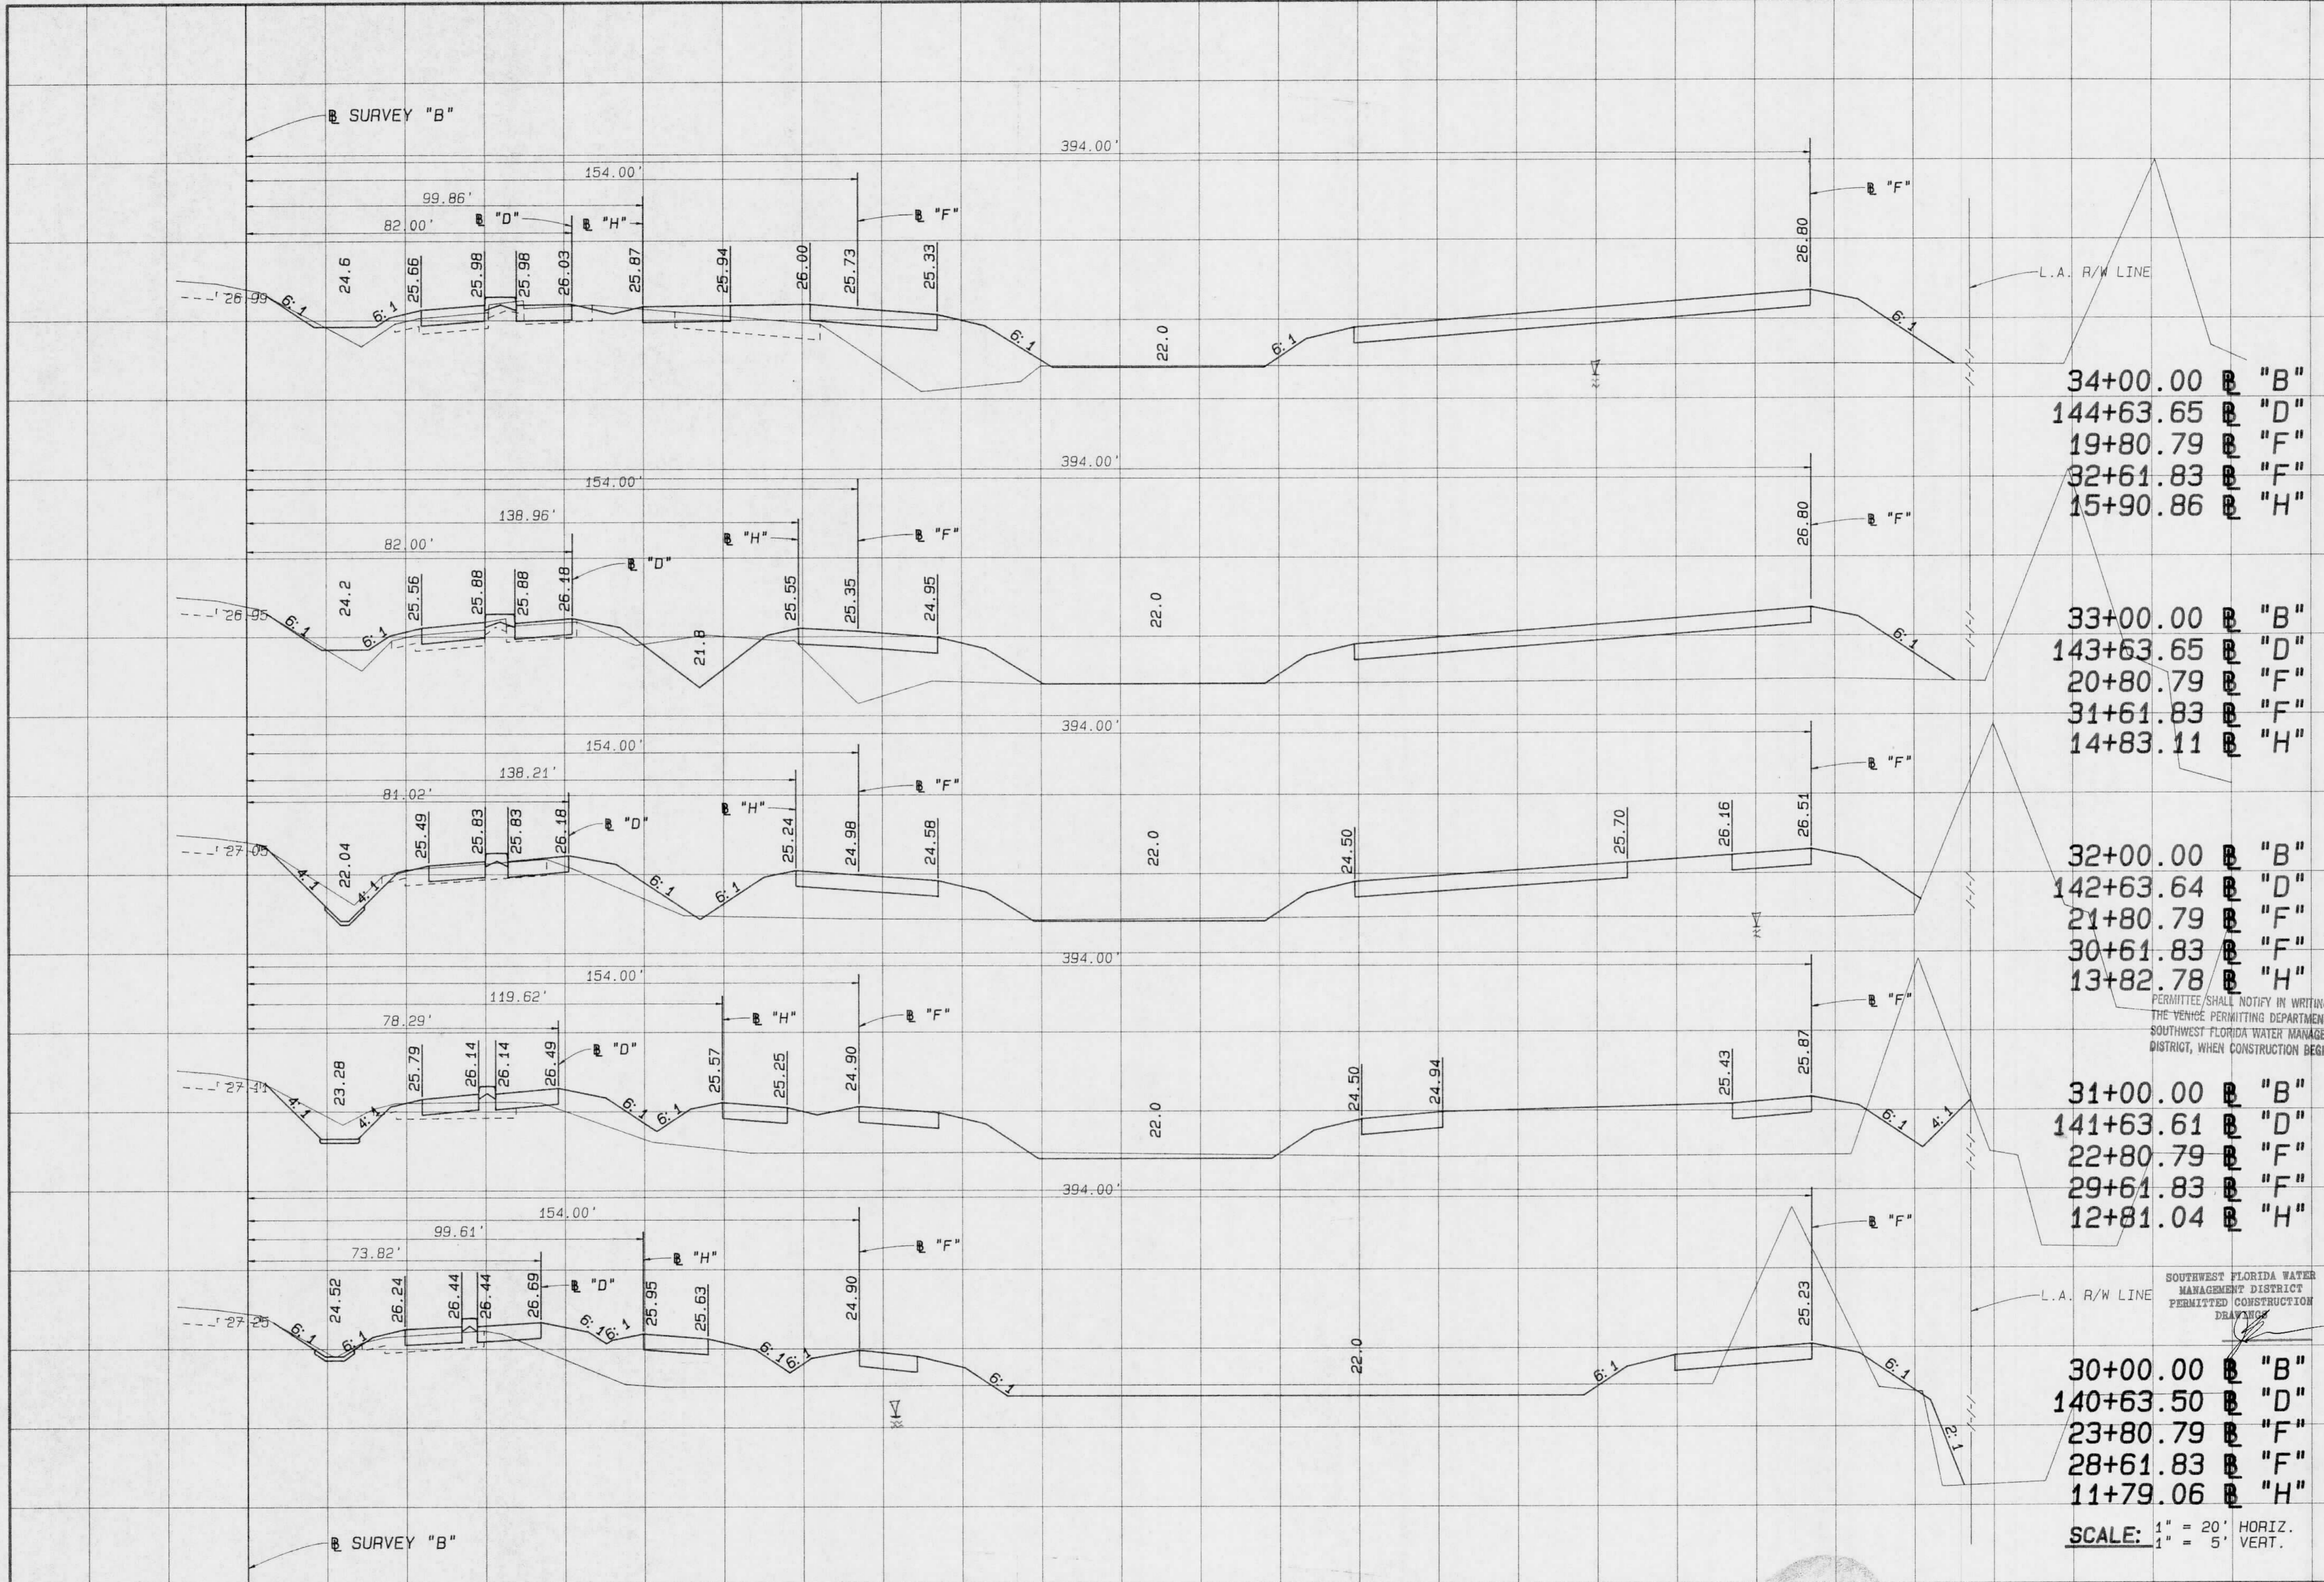

34+00.00 "B"
144+63.65 "D"
19+80.79 "F"
32+61.83 "F"
15+90.86 "H"

33+00.00 "B"
143+63.65 "D"
20+80.79 "F"
31+61.83 "F"
14+83.11 "H"

32+00.00 "B"
142+63.64 "D"
21+80.79 "F"
30+61.83 "F"
13+82.78 "H"

31+00.00 "B"
141+63.61 "D"
22+80.79 "F"
29+61.83 "F"
12+81.04 "H"

30+00.00 "B"
140+63.50 "D"
23+80.79 "F"
28+61.83 "F"
11+79.06 "H"

PERMITTEE SHALL NOTIFY IN WRITING THE VENICE PERMITTING DEPARTMENT, SOUTHWEST FLORIDA WATER MANAGEMENT DISTRICT, WHEN CONSTRUCTION BEGINS.

SOUTHWEST FLORIDA WATER MANAGEMENT DISTRICT PERMITTED CONSTRUCTION DRAWING

FILE OF RECORD PERMIT NO. 409592-00


SCALE: 1" = 20' HORIZ.
1" = 5' VERT.

Imaged As Is

REVISIONS							
DATE	BY	DESCRIPTION	DATE	BY	DESCRIPTION	DATE	BY

XS-BB DESIGNED BY L.P. CLEGG 8-91 CHECKED BY W.F. BIGGS 8-91 SUPERVISED BY WILLIAM F. BIGGS, P.E.	NAME DATE S.W./A.C. 8-91 L.P. CLEGG 8-91	FLORIDA DEPARTMENT OF TRANSPORTATION APPROVED BY DATE 12/1/91	Boyle Engineering Corporation of Florida 551-A Breckenridge Parkway, Tampa, FL 33610-4251 813/621-7900	CROSS SECTIONS NORTHBOUND I-75
--	--	---	---	---

RECEIVED
 Southwest Florida Water Management District
 D-09 1991
 RRD-VEHICLE

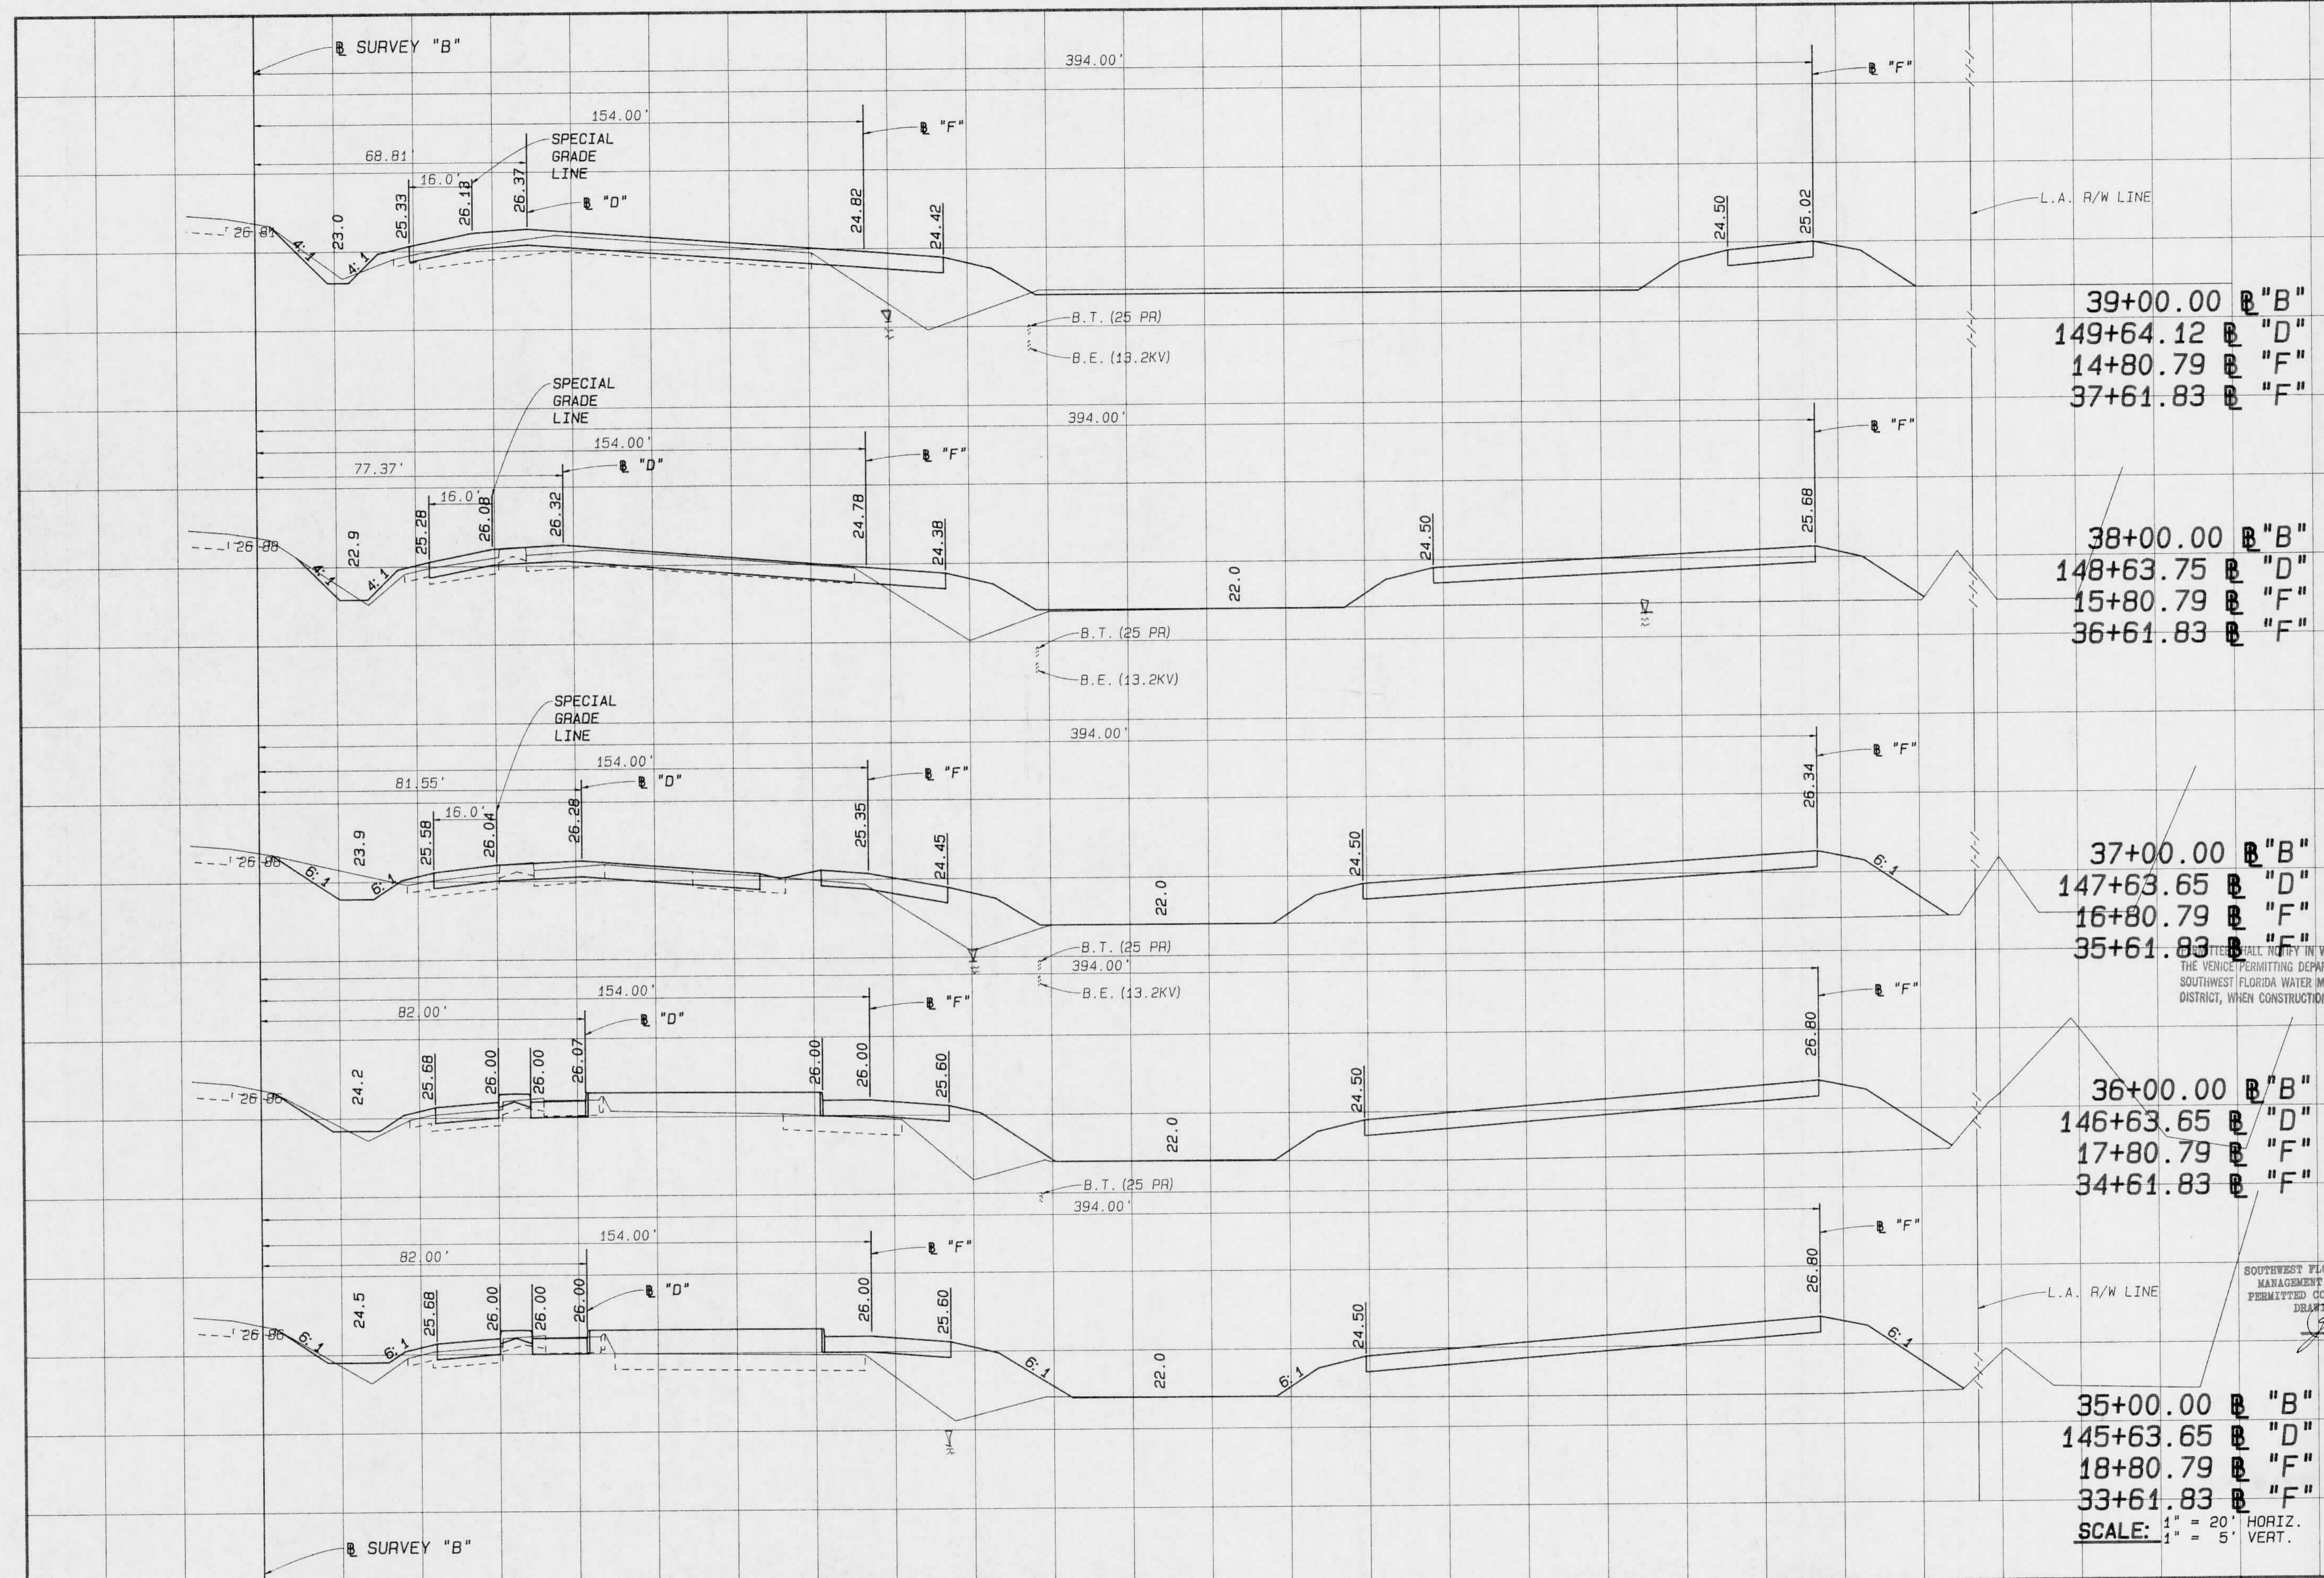

39+00.00 B "B"
 149+64.12 B "D"
 14+80.79 B "F"
 37+61.83 B "F"

38+00.00 B "B"
 148+63.75 B "D"
 15+80.79 B "F"
 36+61.83 B "F"

37+00.00 B "B"
 147+63.65 B "D"
 16+80.79 B "F"
 35+61.83 B "F"

36+00.00 B "B"
 146+63.65 B "D"
 17+80.79 B "F"
 34+61.83 B "F"

35+00.00 B "B"
 145+63.65 B "D"
 18+80.79 B "F"
 33+61.83 B "F"

NOTICE: SHALL NOTIFY IN WRITING THE VENICE PERMITTING DEPARTMENT, SOUTHWEST FLORIDA WATER MANAGEMENT DISTRICT, WHEN CONSTRUCTION BEGINS.

SOUTHWEST FLORIDA WATER MANAGEMENT DISTRICT PERMITTED CONSTRUCTION DRAWING

FILE OF RECORD PERMIT NO. 409592.00

SCALE: 1" = 20' HORIZ. VERT. 1" = 5'

Imaged As Is


REVISIONS				FLORIDA DEPARTMENT OF TRANSPORTATION				Boyle Engineering Corporation of Florida		CROSS SECTIONS NORTHBOUND I-75
DATE	BY	DESCRIPTION	DATE	BY	DESCRIPTION	DESIGNED BY	DATE	NAME	DATE	
						DESIGNED BY	8-91	L. P. CLEGG	8-91	
						CHECKED BY	8-91	W. F. BIGGS	8-91	
						SUPERVISED BY		WILLIAM F. BIGGS, P.E.		

APPROVED BY: [Signature]
 DATE: 12/6/91

5912-A Bruckley Lane, Tampa, FL 33610-4251 813/627-7900

C:\JUMBLE\TASK\M.BIGGS\MEIGH\PUNTA\1.XS-D9 SPOOLED BY CLEGG ON 23 SEP 1991 AT 16:50:09

Rdwy. Exc. F311
A V A V
RECEIVED
Southwest Florida Water
Management District
DEC 09 1991
BRD-VEHICLE

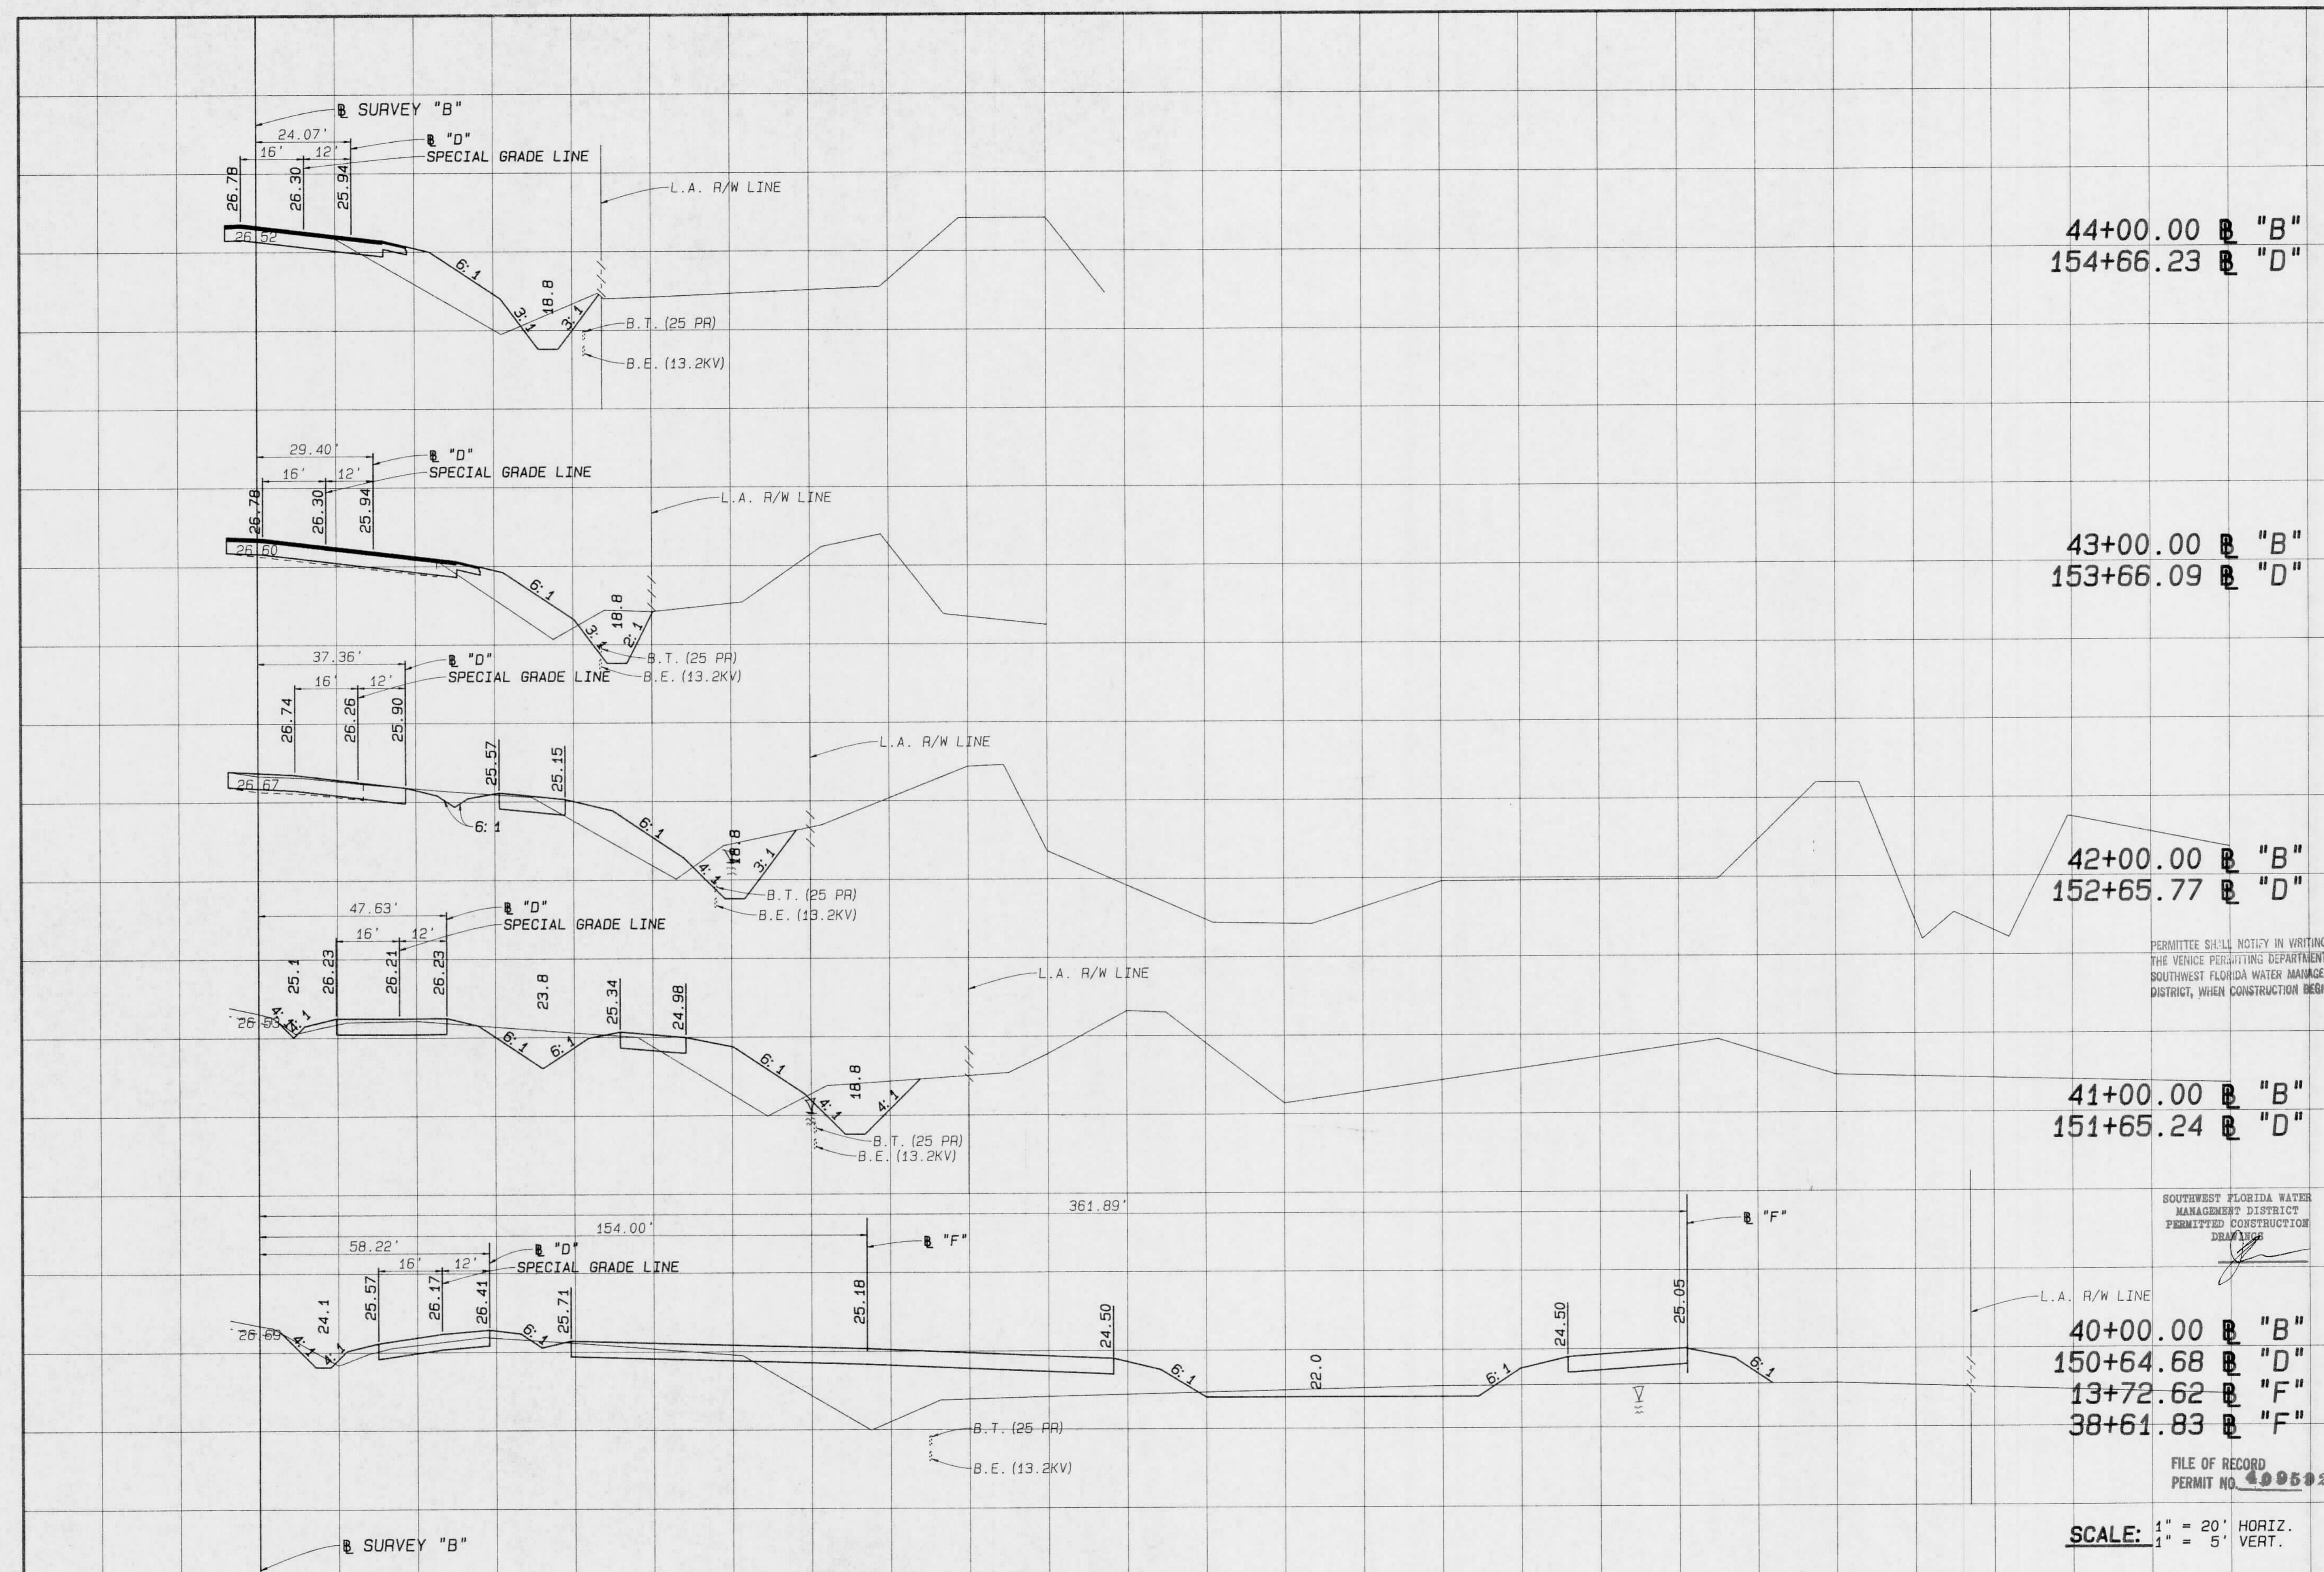

44+00.00 B "B"
154+66.23 B "D"

43+00.00 B "B"
153+66.09 B "D"

42+00.00 B "B"
152+65.77 B "D"

41+00.00 B "B"
151+65.24 B "D"

40+00.00 B "B"
150+64.68 B "D"
13+72.62 B "F"
38+61.83 B "F"

PERMITTEE SHALL NOTIFY IN WRITING THE VEHICLE PERMITTING DEPARTMENT, SOUTHWEST FLORIDA WATER MANAGEMENT DISTRICT, WHEN CONSTRUCTION BEGINS.

SOUTHWEST FLORIDA WATER MANAGEMENT DISTRICT PERMITTED CONSTRUCTION DRAWINGS

FILE OF RECORD PERMIT NO. 409592.00

SCALE: 1" = 20' HORIZ.
1" = 5' VERT.

Imaged As Is

REVISIONS							
DATE	BY	DESCRIPTION	DATE	BY	DESCRIPTION	DATE	BY

XS-B10	NAME	DATE	NAME	DATE
DESIGNED BY	L.P. CLEGG	8-91	DRAWN BY	S.W./A.C.
CHECKED BY	W.F. BIGGS	8-91	CHECKED BY	L.P. CLEGG
SUPERVISED BY	WILLIAM F. BIGGS, P.E.			

FLORIDA DEPARTMENT OF TRANSPORTATION
APPROVED BY
William F. Biggs
DATE 12/01/91


Boyle Engineering Corporation
of Florida
5912-A Breckenridge Parkway, Tampa, FL 33610-4251 813/821-7900

CROSS SECTIONS
NORTHBOUND I-75

C:\JUMBLE\TASK\M-BIGGS\WEIGH\PRINT\A-XB-B10 SPOOLED BY CLEGG ON 23 SEP 1991 AT 16:51:13

Rdwy. Exc.		Fill	
A	V	A	V

RECEIVED
 Southwest Florida Water Management District
 DEC 09 1991
 RRD-148-1-E

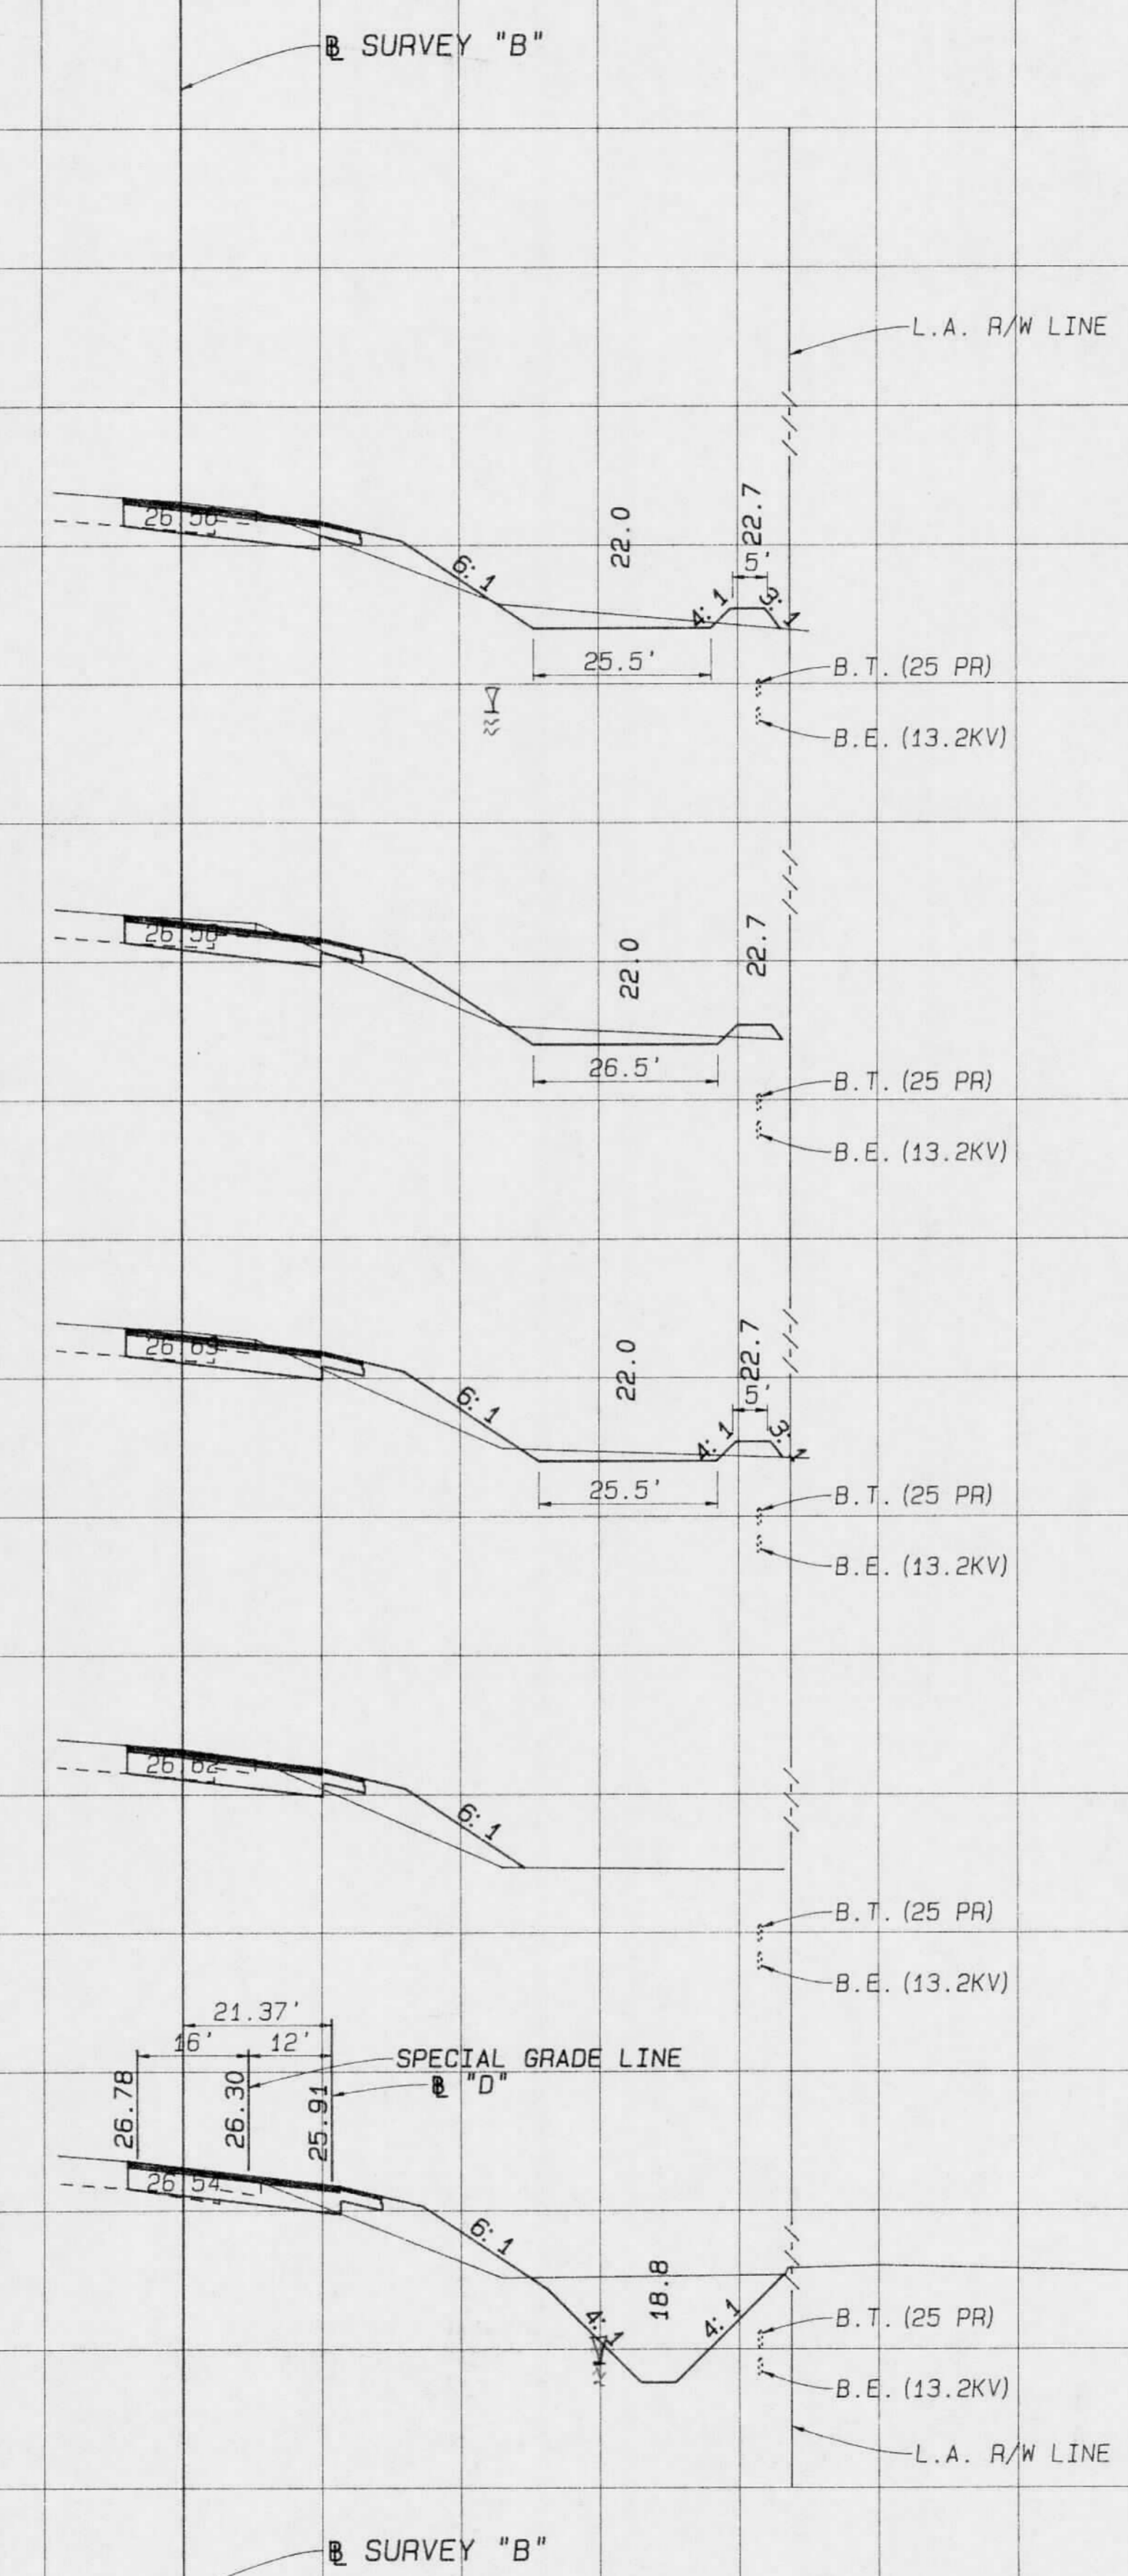

49+00.00 B "B"

48+00.00 B "B"

47+00.00 B "B"

46+00.00 B "B"

45+00.00 B "B"
 155+66.27 B "D"

PERMITEE SHALL NOTIFY IN WRITING THE VENICE PERMITTING DEPARTMENT, SOUTHWEST FLORIDA WATER MANAGEMENT DISTRICT, WHEN CONSTRUCTION BEGINS.

SOUTHWEST FLORIDA WATER MANAGEMENT DISTRICT PERMITTED CONSTRUCTION DRAWINGS

FILE OF RECORD PERMIT NO. 409592.00

SCALE: 1" = 20' HORIZ.
 1" = 5' VERT.

Imaged As Is

REVISIONS							
DATE	BY	DESCRIPTION	DATE	BY	DESCRIPTION	DATE	BY

XS-B11	NAME	DATE	NAME	DATE
DESIGNED BY	L.P. CLEGG	8-91	DRAWN BY	S.W./A.C.
CHECKED BY	W.F. BIGGS	8-91	CHECKED BY	L.P. CLEGG
SUPERVISED BY	WILLIAM F. BIGGS, P.E.			


FLORIDA DEPARTMENT OF TRANSPORTATION
 APPROVED BY: *[Signature]* DATE 12/6/91

Boyle Engineering Corporation
 of Florida
 5812-A Breckinridge Parkway, Tampa, FL 33610-4251 813/921-7500

CROSS SECTIONS
 NORTHBOUND I-75

<JUMBLE>TASK\M_BIGGS\NEIGH\PUNTA*.XB-B11 SPOOLED BY CLEGG ON 02 DEC 1991 AT 17:30:02

RECEIVED
Southwest Florida Water Management District
DEC 08 1991
RDW-VENICE

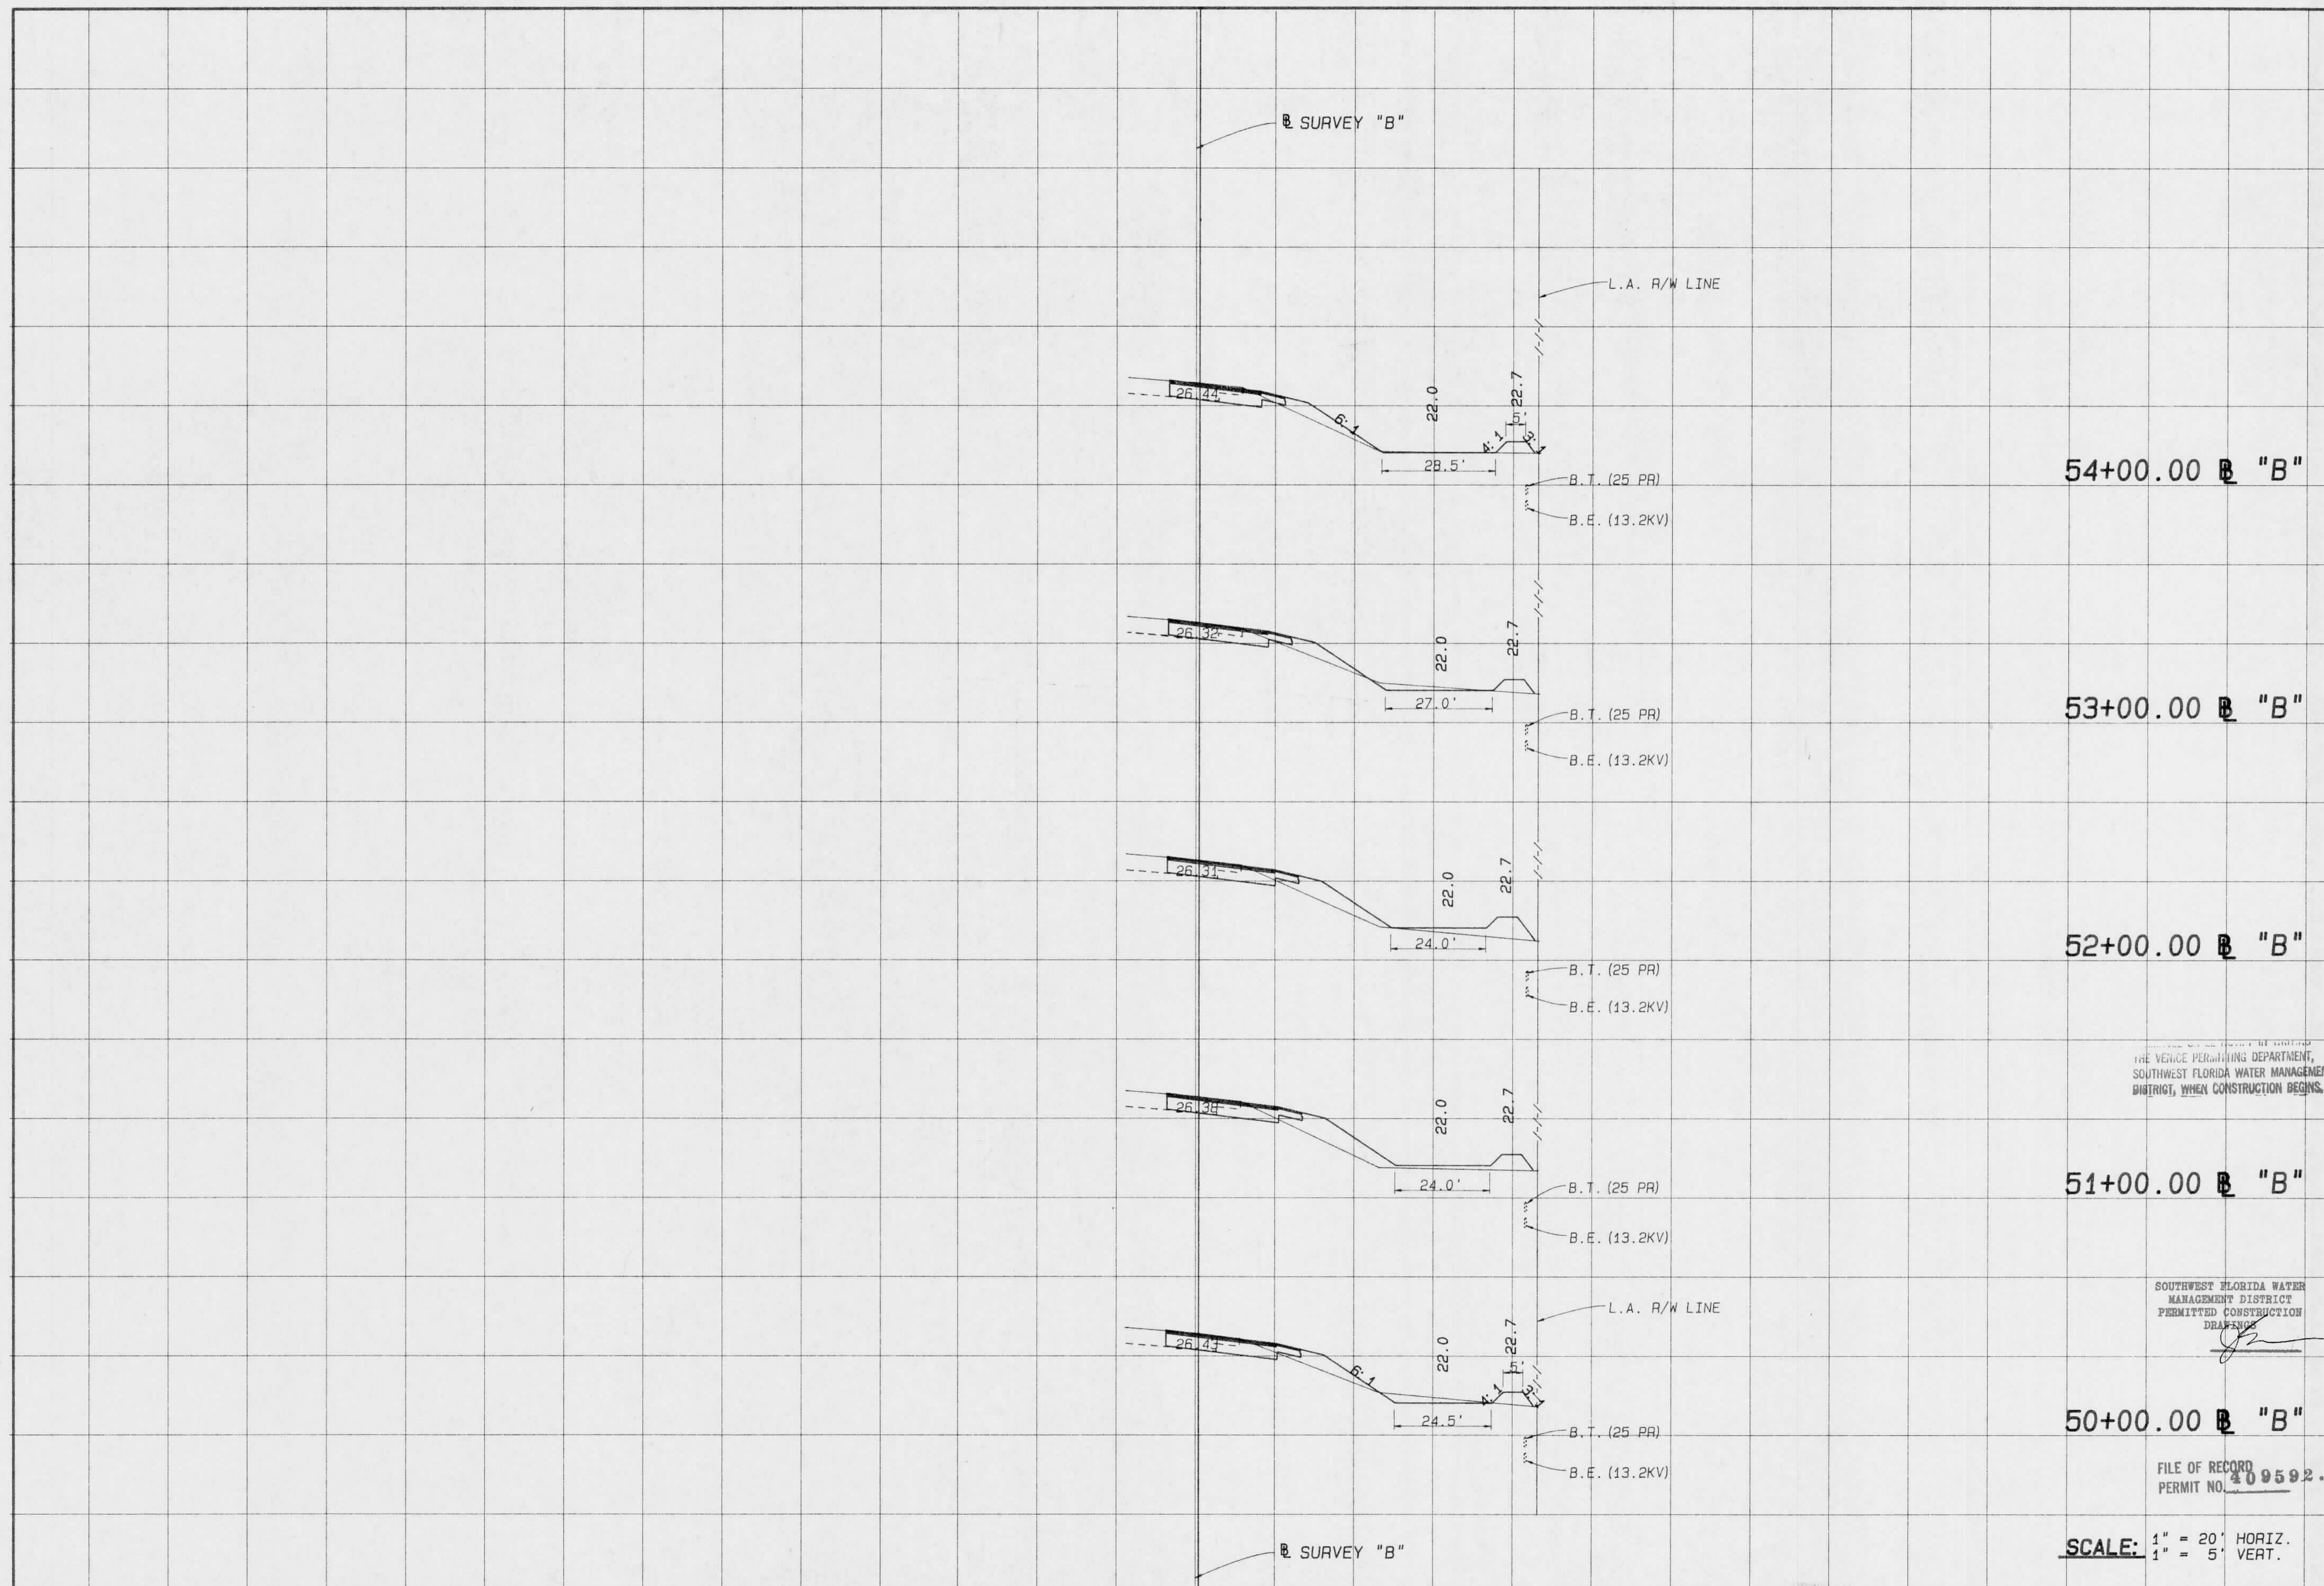

THE VENICE PERMITTING DEPARTMENT, SOUTHWEST FLORIDA WATER MANAGEMENT DISTRICT, WHEN CONSTRUCTION BEGINS.

SOUTHWEST FLORIDA WATER MANAGEMENT DISTRICT PERMITTED CONSTRUCTION DRAWING

FILE OF RECORD PERMIT NO. 409592.00

SCALE: 1" = 20' HORIZ. 1" = 5' VERT.

Imaged As Is

REVISIONS							
DATE	BY	DESCRIPTION	DATE	BY	DESCRIPTION	DATE	BY

XS-B12	NAME	DATE	NAME	DATE
DESIGNED BY	L.P. CLEGG	8-91	DRAWN BY	S.M./A.C.
CHECKED BY	W.F. BIGGS	8-91	CHECKED BY	L.P. CLEGG
SUPERVISED BY		WILLIAM F. BIGGS, P.E.		

FLORIDA DEPARTMENT OF TRANSPORTATION
APPROVED BY
William F. Biggs
DATE 12/1/91


Bouje Engineering Corporation of Florida
5912-A Breckinridge Parkway, Tampa, FL 33610-0251 813/621-7900

CROSS SECTIONS
NORTHBOUND I-75

409592.00

Rdwy. Exc.	Fill
A V	A V

RECEIVED
Southwest Florida Water
Management District
DEC 09 1991
RDW - VENICE

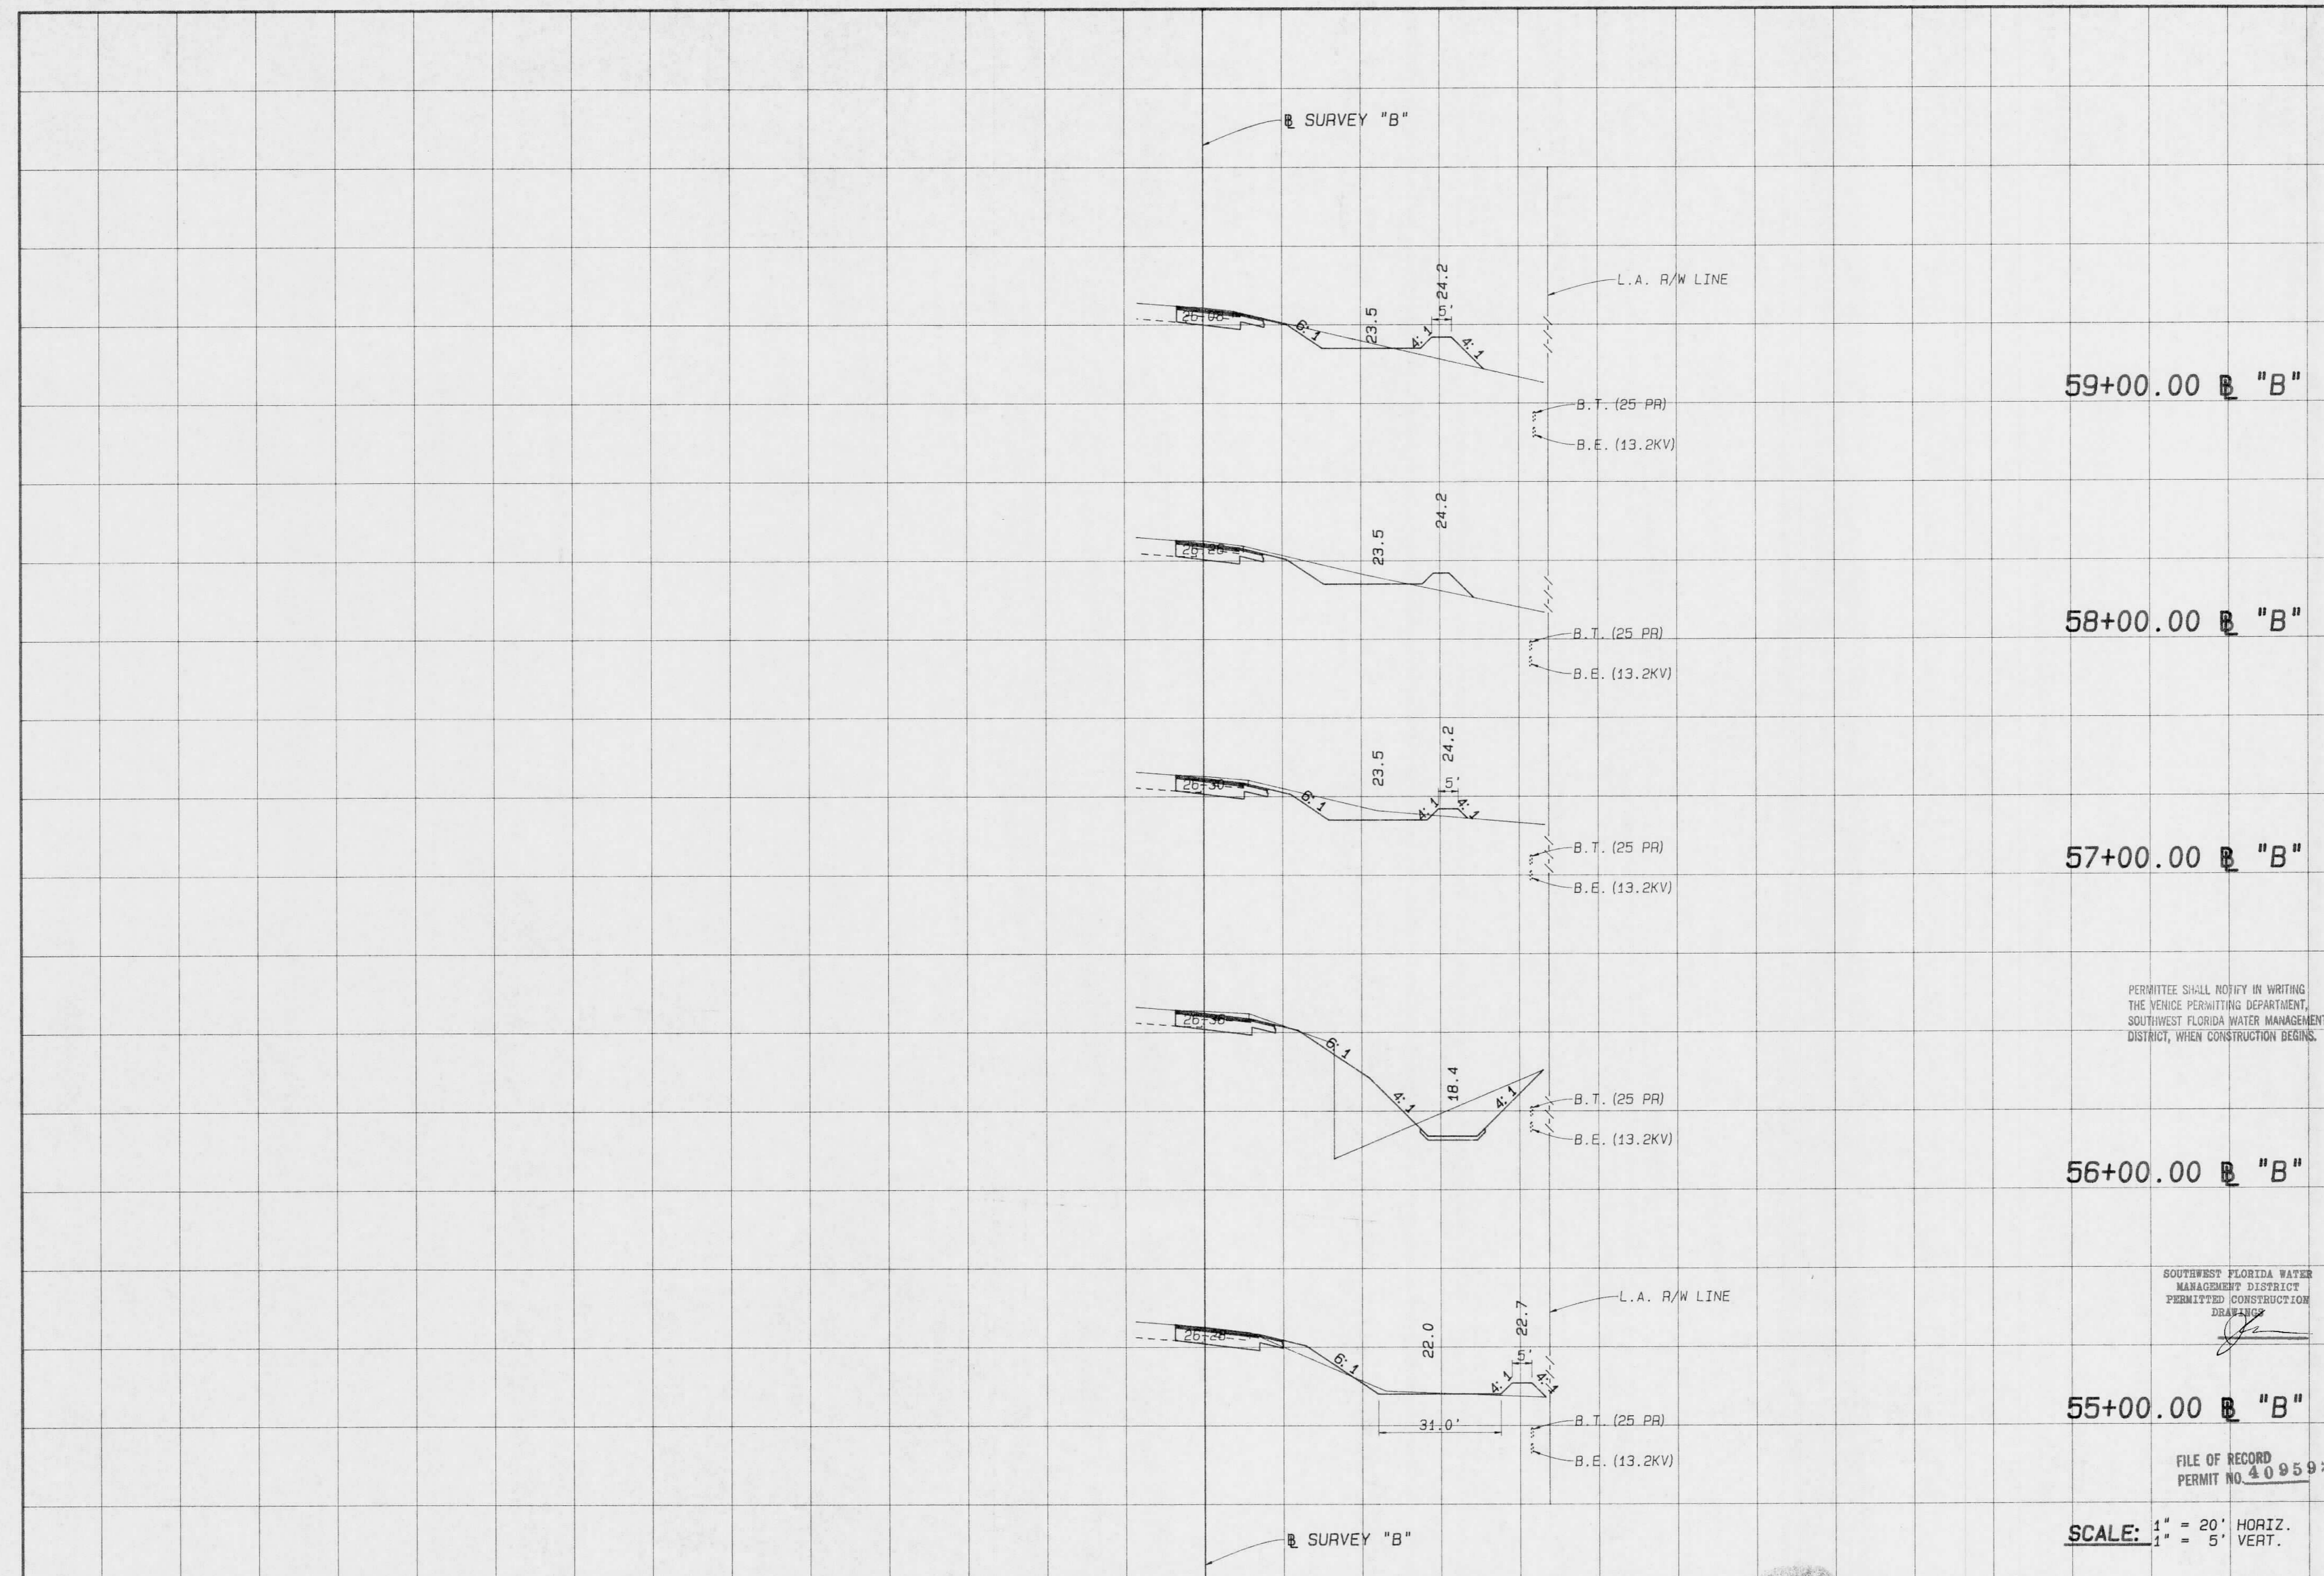

59+00.00 B "B"

58+00.00 B "B"

57+00.00 B "B"

56+00.00 B "B"

55+00.00 B "B"

PERMITTEE SHALL NOTIFY IN WRITING THE VENICE PERMITTING DEPARTMENT, SOUTHWEST FLORIDA WATER MANAGEMENT DISTRICT, WHEN CONSTRUCTION BEGINS.

SOUTHWEST FLORIDA WATER MANAGEMENT DISTRICT PERMITTED CONSTRUCTION DRAWING

FILE OF RECORD PERMIT NO. 409592-00

SCALE: 1" = 20' HORIZ. 1" = 5' VERT.

Imaged As Is

REVISIONS											
DATE	BY	DESCRIPTION	DATE	BY	DESCRIPTION	DATE	BY	DESCRIPTION	DATE	BY	DESCRIPTION

XS-B13	NAME	DATE	NAME	DATE
DESIGNED BY	L.P. CLEGG	8-91	DRAWN BY	S.W./A.C.
CHECKED BY	W.F. BIGGS	8-91	CHECKED BY	L.P. CLEGG
SUPERVISED BY	WILLIAM F. BIGGS, P.E.			


FLORIDA DEPARTMENT OF TRANSPORTATION
APPROVED BY: [Signature]
DATE: 12/01/91

Boyle Engineering Corporation
of Florida
5912-A Breckenridge Parkway, Tampa, FL 33610-4251 813/521-7800

CROSS SECTIONS
NORTHBOUND I-75

C:\JUNBLE\TASK\N.BIGGS\WEIGH\PUNTA\8.X8-B13 SPOOLED BY CLEGG ON 03 DEC 1991 AT 16:56:39

RECEIVED
 Southwest Florida Water
 Management District
 DEC 19 1991
 RR0-VENICE

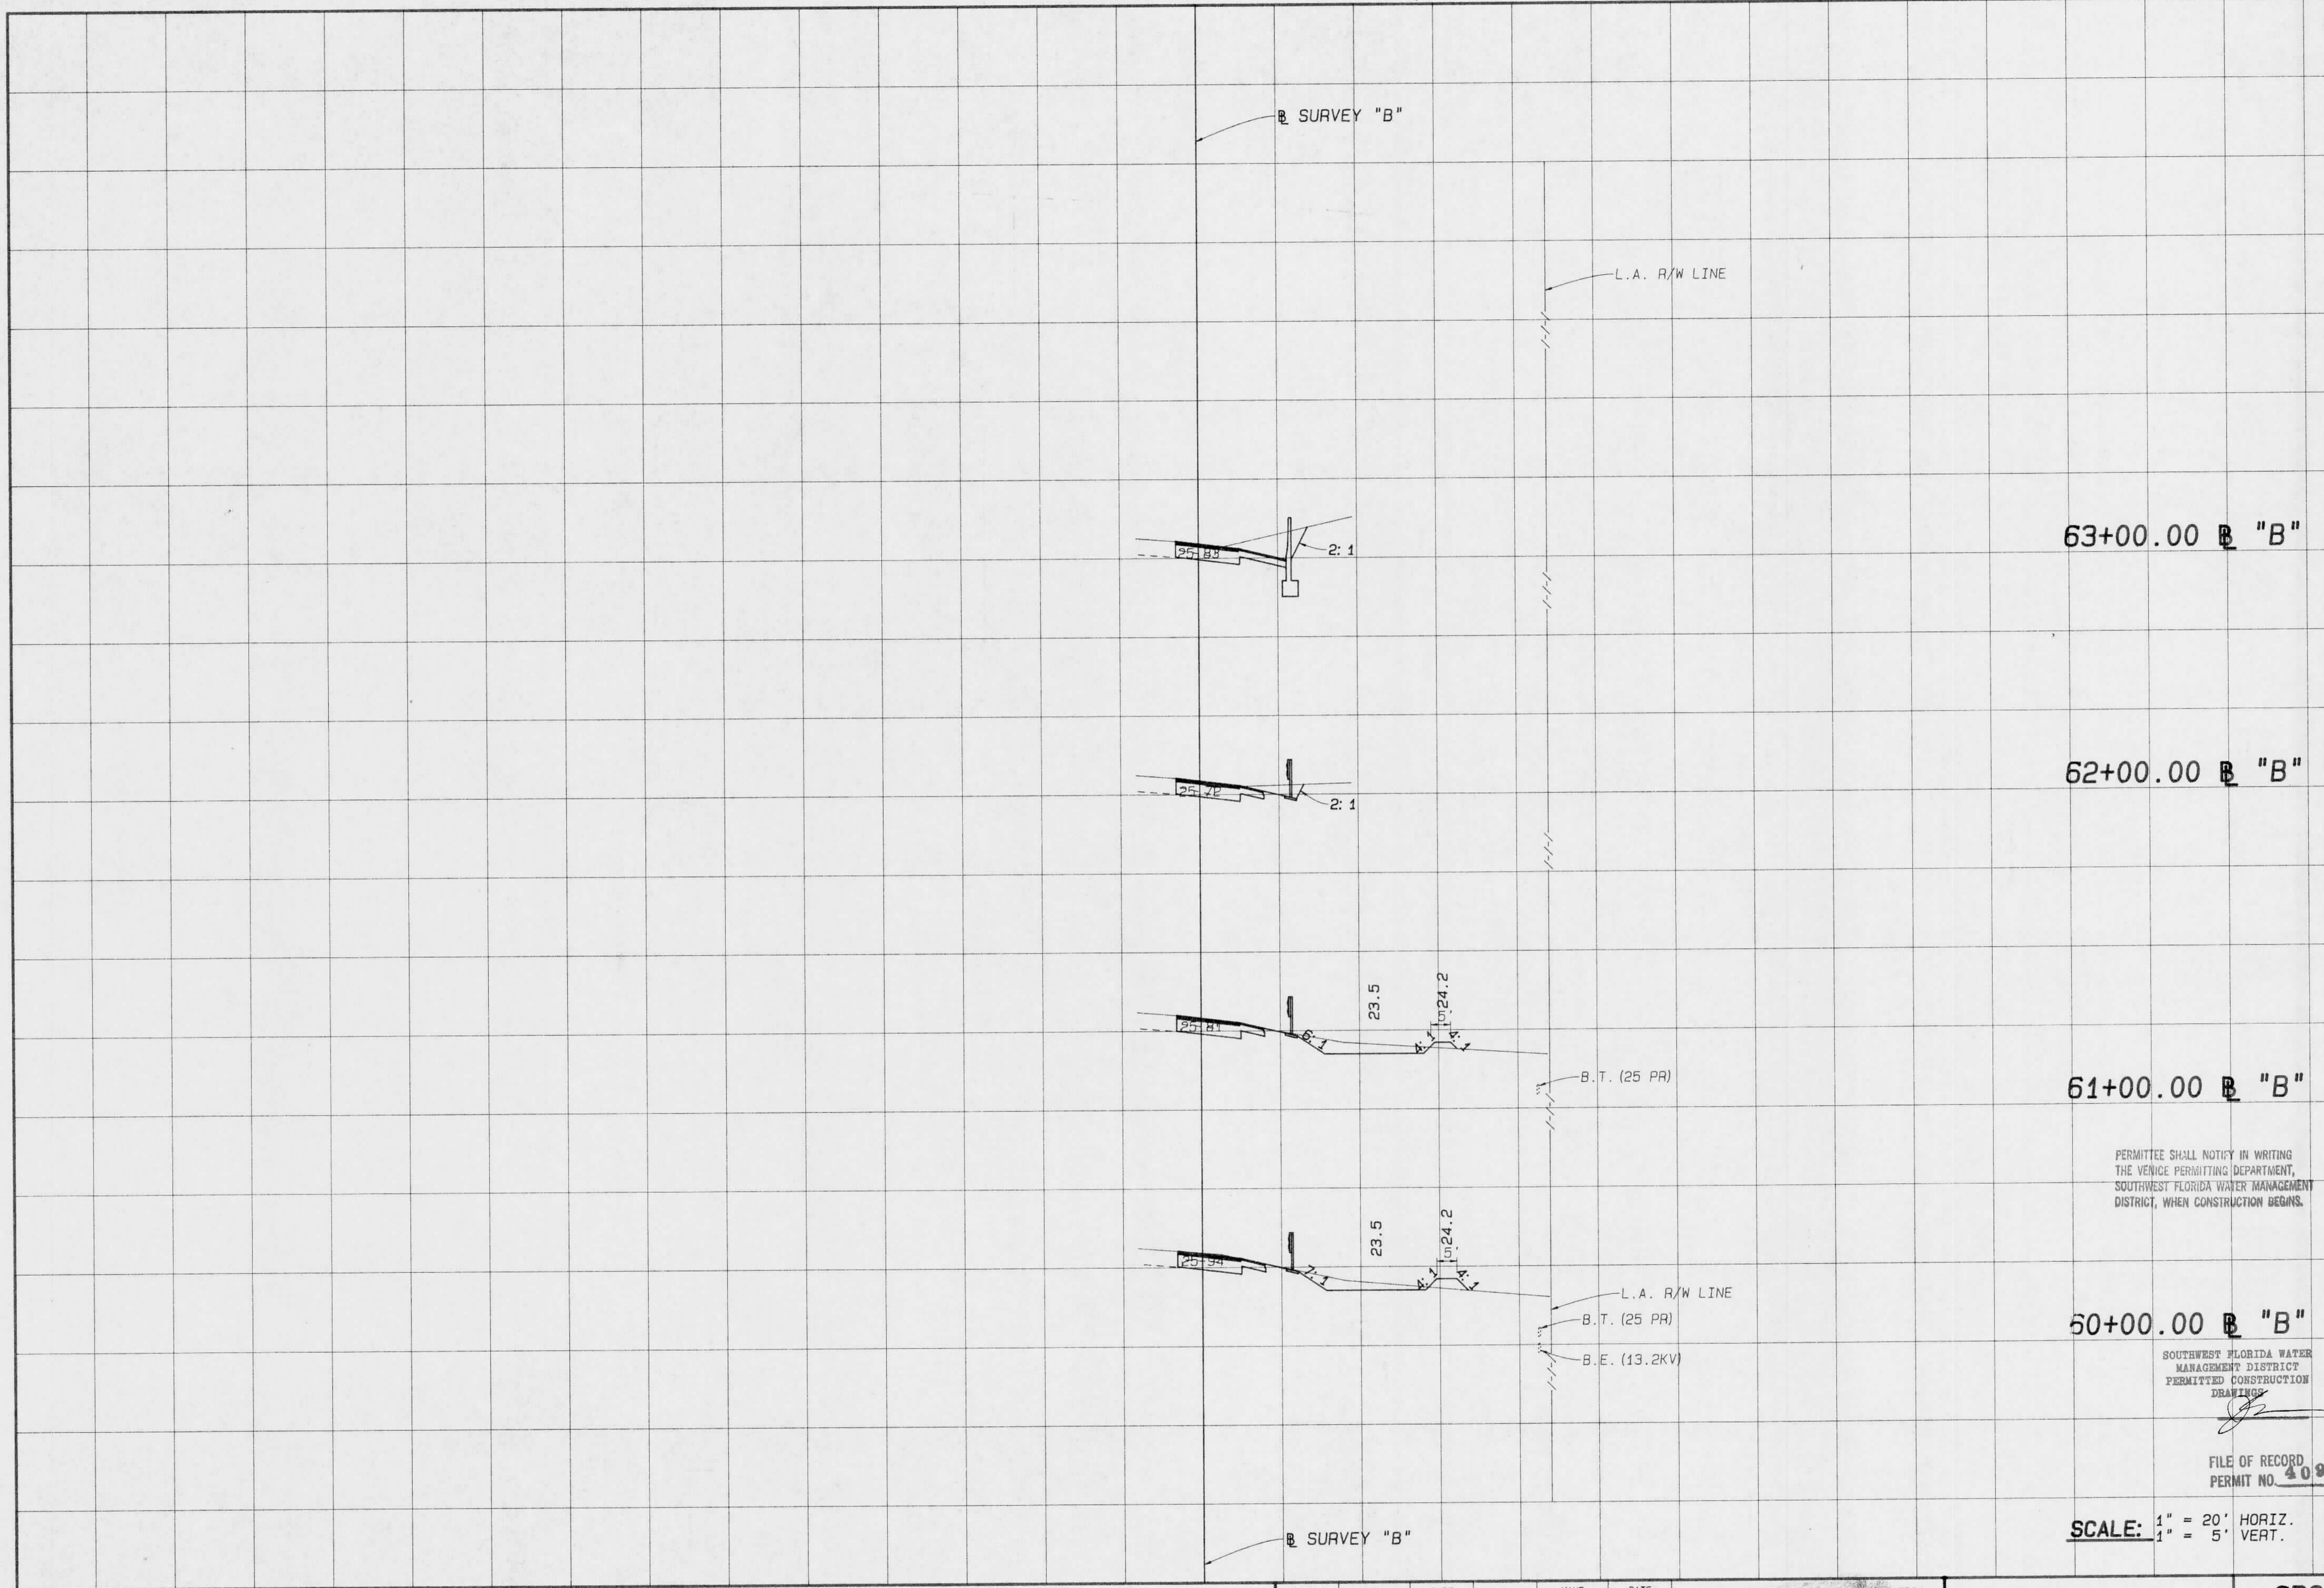

63+00.00 B "B"

62+00.00 B "B"

61+00.00 B "B"

50+00.00 B "B"

PERMITTEE SHALL NOTIFY IN WRITING THE VENICE PERMITTING DEPARTMENT, SOUTHWEST FLORIDA WATER MANAGEMENT DISTRICT, WHEN CONSTRUCTION BEGINS.

SOUTHWEST FLORIDA WATER MANAGEMENT DISTRICT PERMITTED CONSTRUCTION DRAWING

FILE OF RECORD PERMIT NO. 409592.00

SCALE: 1" = 20' HORIZ. 1" = 5' VERT.

Imaged As Is


REVISIONS							
DATE	BY	DESCRIPTION	DATE	BY	DESCRIPTION	DATE	BY

XS-B14	NAME	DATE	NAME	DATE	FLORIDA DEPARTMENT OF TRANSPORTATION
DESIGNED BY	L. P. CLEGG	8-91	DRAWN BY	S. W. / A. C.	8-91
CHECKED BY	W. F. BIGGS	8-91	CHECKED BY	L. P. CLEGG	8-91
SUPERVISED BY	WILLIAM F. BIGGS, P.E.				

Bouje Engineering Corporation of Florida
 5815-A Breckenridge Parkway, Tampa, FL 33610-4251 813/901-7900

CROSS SECTIONS NORTHBOUND I-75

RECEIVED
 Southwest Florida Water
 Management District
 DEC-09 1991
 BRD-VENTICE

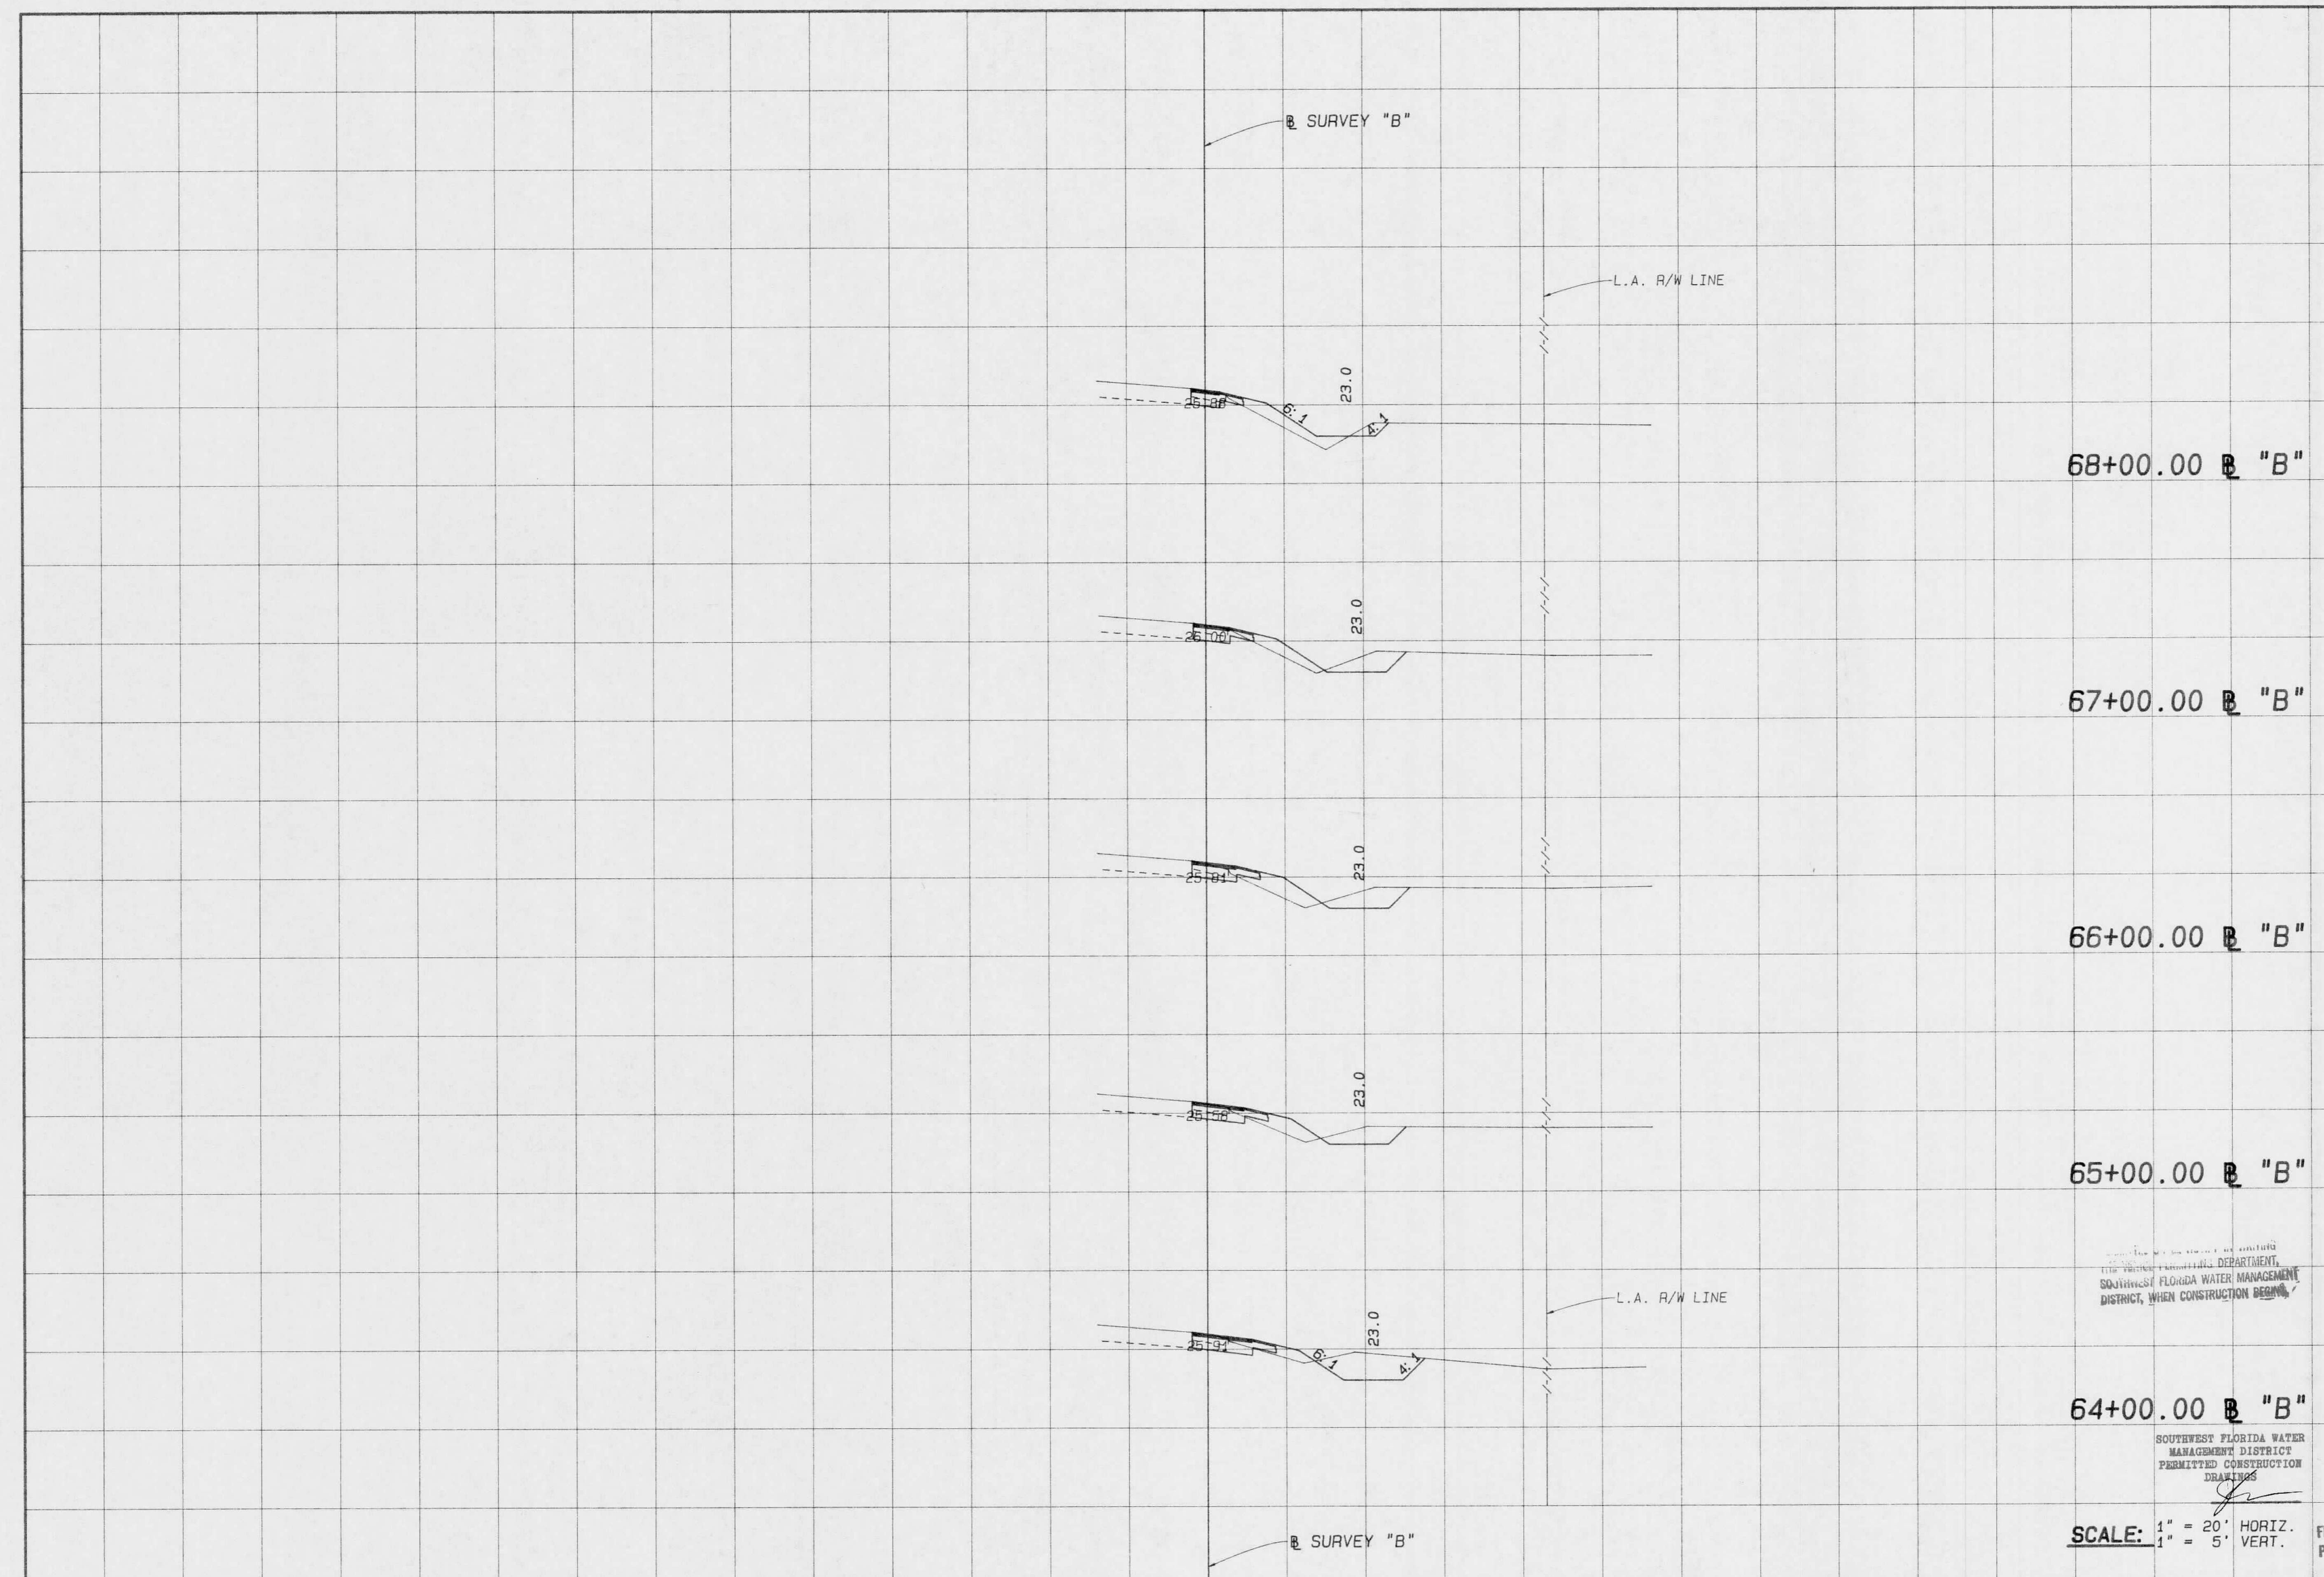

SOUTHWEST FLORIDA WATER
 MANAGEMENT DISTRICT
 PERMITTED CONSTRUCTION
 DRAWINGS

SCALE: 1" = 20' HORIZ.
 1" = 5' VERT.

FILE OF RECORD
 PERMIT NO. 409592-00

REVISIONS							
DATE	BY	DESCRIPTION	DATE	BY	DESCRIPTION	DATE	BY

XS-B15	NAME	DATE	NAME	DATE
DESIGNED BY	L.P. CLEGG	8-91	DRAWN BY	S.W./A.C.
CHECKED BY	W.F. BIGGS	8-91	CHECKED BY	L.P. CLEGG
SUPERVISED BY		WILLIAM F. BIGGS, P.E.		

FLORIDA DEPARTMENT OF TRANSPORTATION
 APPROVED BY
 DATE 12/1/91


Boyle Engineering Corporation
 of Florida
 5912-A Breckenridge Parkway, Tampa, FL 33610-4251 813/821-7900

**CROSS SECTIONS
 NORTHBOUND I-75**

<JUMBLE>TASK=M.BIGGS-WEIGH-PUNTA>S.XS-B15 SPOOLED BY CLEGG ON 02 DEC 1991 AT 11:27:05

Rdwy. Exc. Fill
A V A V

RECEIVED
Southwest Florida Water
Management District
DEC 09 1991
RDW-VEHICLE

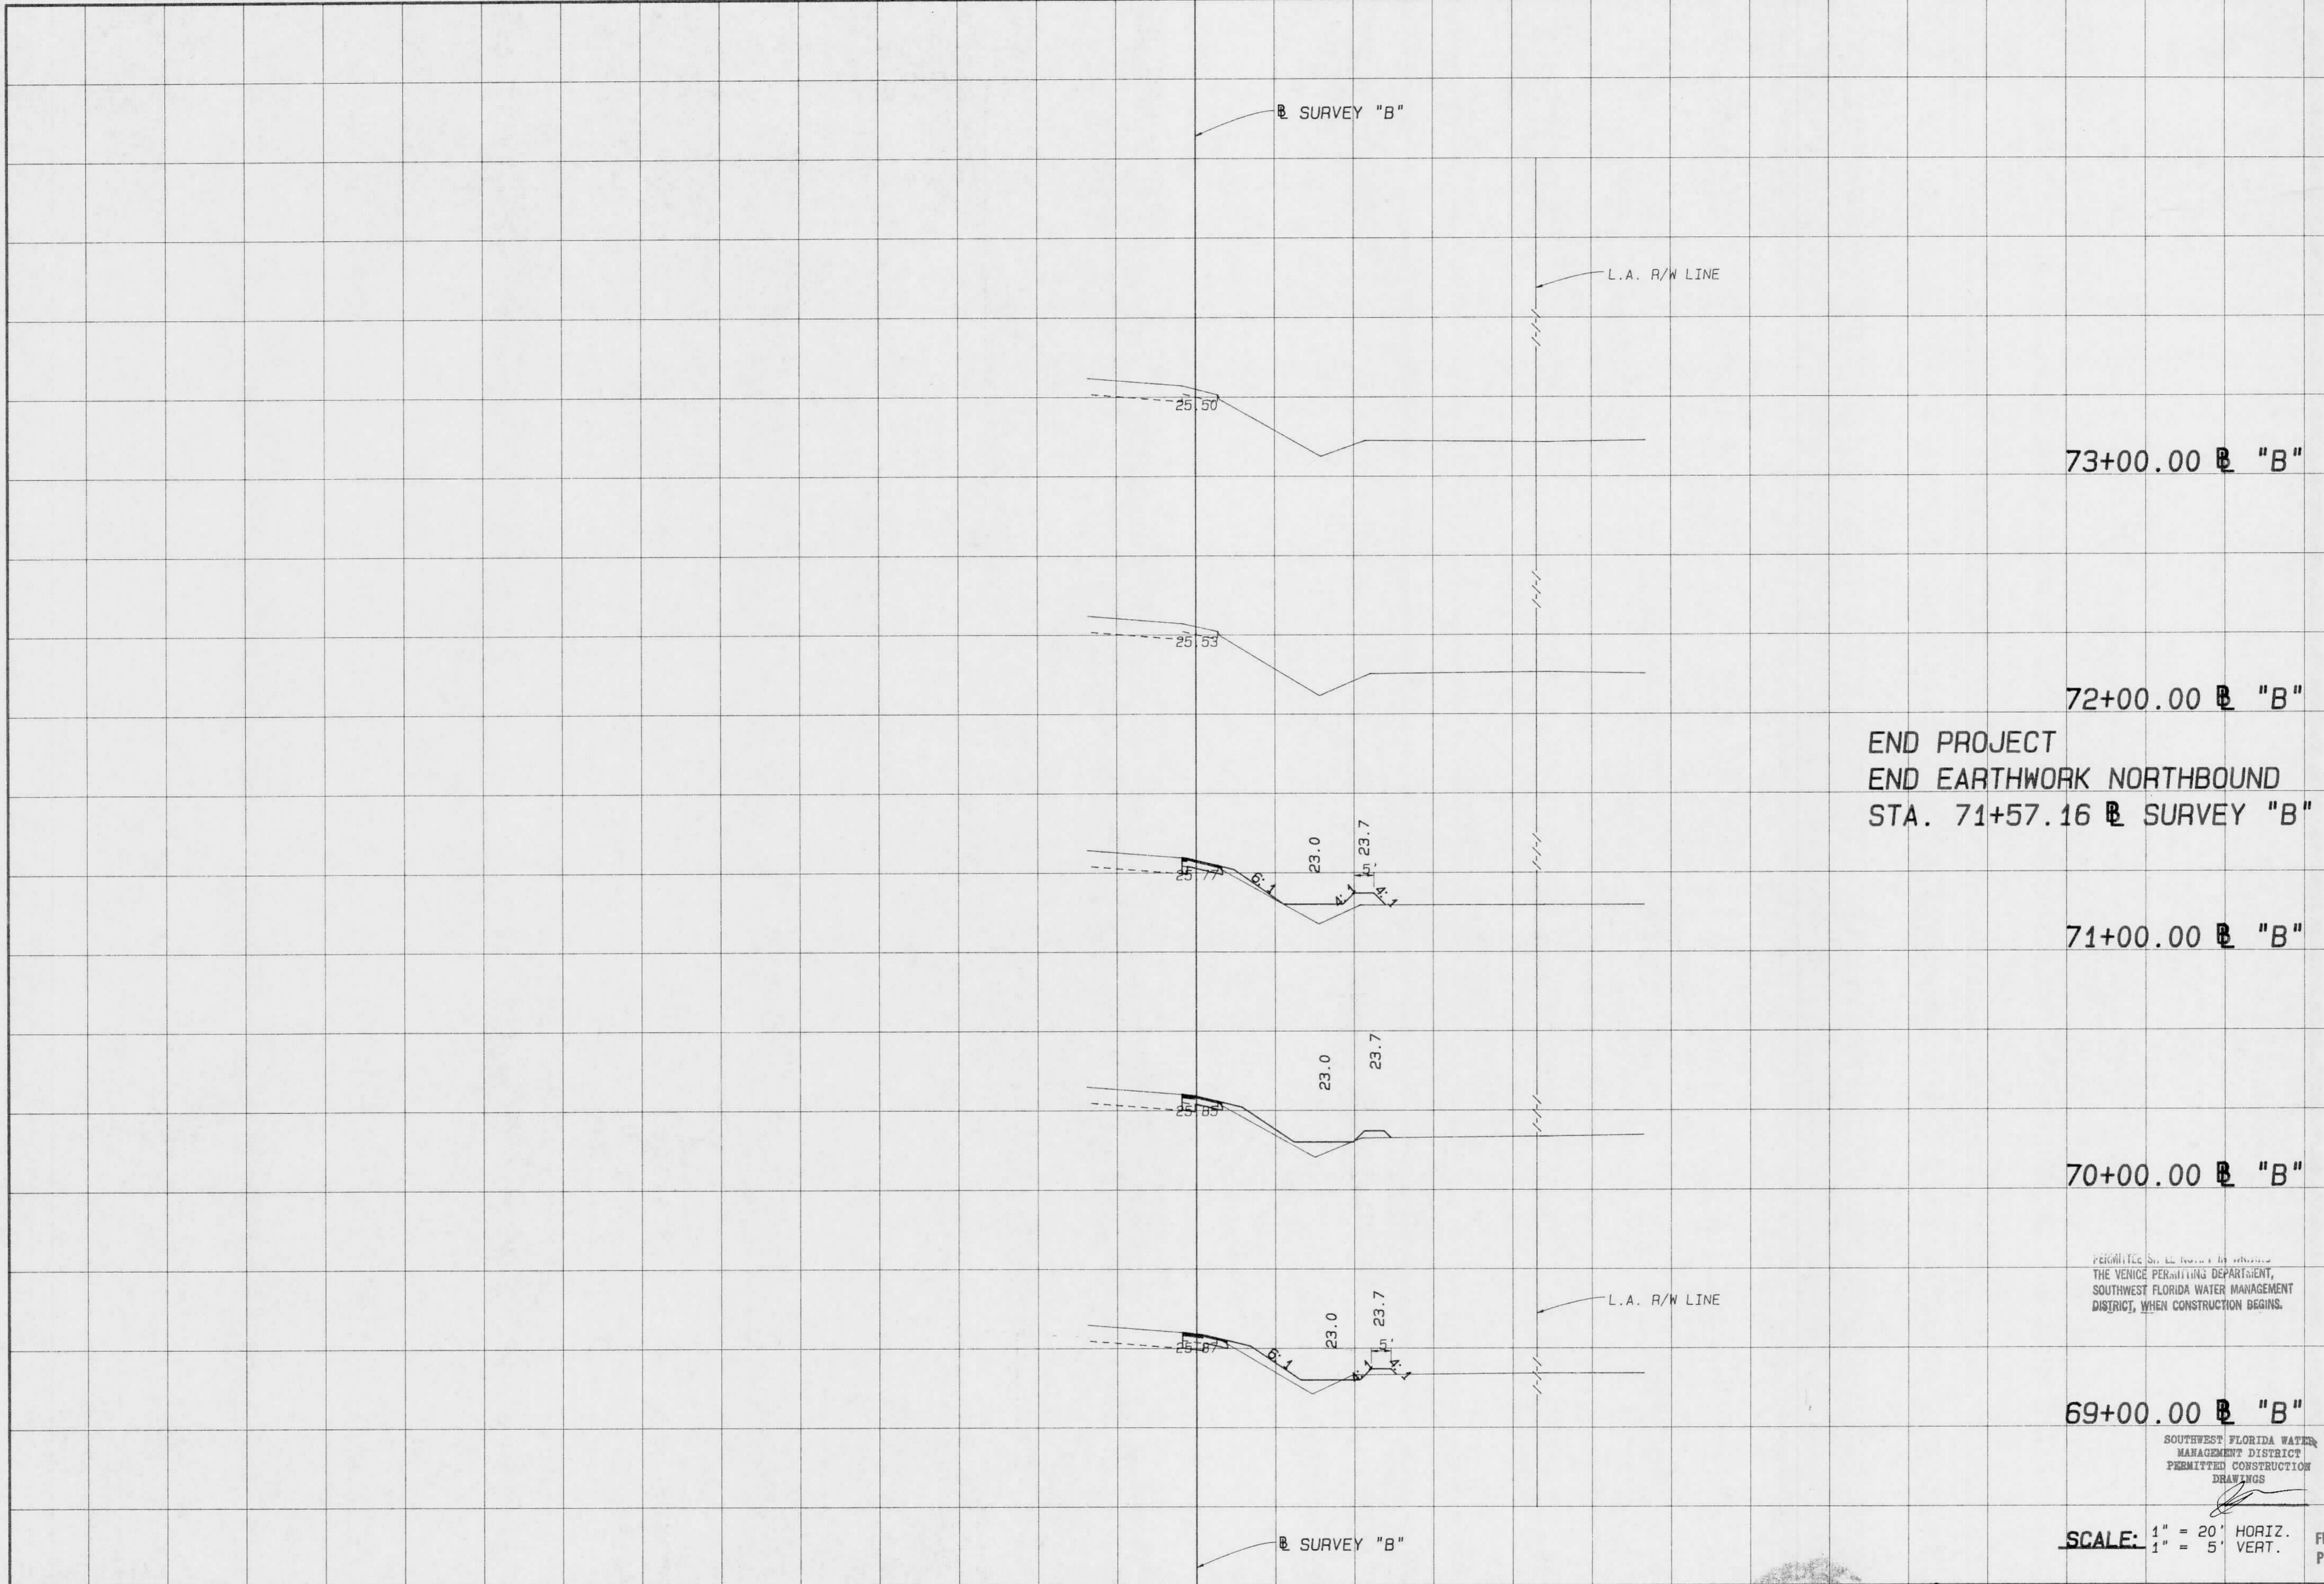

409592.00 FOR

PERMITS SHALL BE OBTAINED FROM THE VENICE PERMITTING DEPARTMENT, SOUTHWEST FLORIDA WATER MANAGEMENT DISTRICT, WHEN CONSTRUCTION BEGINS.

SOUTHWEST FLORIDA WATER MANAGEMENT DISTRICT PERMITTED CONSTRUCTION DRAWINGS

Imaged As Is

SCALE: 1" = 20' HORIZ.
1" = 5' VERT.

FILE OF RECORD PERMIT NO. 409592-00

REVISIONS											
DATE	BY	DESCRIPTION	DATE	BY	DESCRIPTION	DATE	BY	DESCRIPTION	DATE	BY	DESCRIPTION

XS-B16	NAME	DATE	NAME	DATE	
DESIGNED BY	L.P. CLEGG	8-91	DRAWN BY	S.W./A.C.	8-91
CHECKED BY	W.F. BIGGS	8-91	CHECKED BY	L.P. CLEGG	8-91
SUPERVISED BY		WILLIAM F. BIGGS, P.E.			

FLORIDA DEPARTMENT OF TRANSPORTATION
APPROVED BY: *[Signature]* DATE: 12/1/91

Boyle Engineering Corporation
5912-A Breckenridge Parkway, Tampa, FL 33610-0251 813/621-7900

CROSS SECTIONS
NORTHBOUND I-75